

Parrearra Lake Management Plan

2019 - 2029

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Acknowledgements

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1 Introduction

This Lake Management Plan has been prepared by Sunshine Coast Council to promote effective long-term management of the Parrearra Lake system. It is a 10 year plan that supersedes the original Lake Management Plan developed by Lensworth in 2001.

1.1 Purpose

The purpose of the Lake Management Plan is to:

- outline the rights and responsibilities of the lake owners, residents and users;
- develop an appropriate inspection and maintenance schedule to meet objectives and performance standards;
- provide guidelines and management actions for ensuring the lake continues to function as an effective flood bypass channel (based on previously accepted and approved criteria);
- provide guidelines and management actions for ensuring compliance with secondary contact water quality guidelines;
- provide guidelines for acceptable use of the lake such as sport and recreation; and
- define permitted uses subject to approval such as commercial operations and private structures.

1.2 Objectives

The objectives of the Lake Management Plan are specified in Table 1 below.

Table 1: Management plan objectives

Objective	Performance standard	Refer
Public use complies with guidelines outlined in this management plan	<ul style="list-style-type: none"> Public, residents and sporting bodies are informed of acceptable uses, their rights and responsibilities 	Section 5
Water quality is maintained to a standard suitable for secondary contact recreation use ¹	<ul style="list-style-type: none"> Compliance with water quality guidelines Effective operation and maintenance of tidal exchange system and weir Growth of undesirable marine organisms is absent or regulated 	Section 6
The lake functions as an effective flood bypass channel	<ul style="list-style-type: none"> No flooding above Q100 level Compliance with design criteria for lake operation as a flood channel Effective operation and maintenance of tidal exchange system and weir Maintain lake to acceptable tolerances from design profile 	Section 7
Amenity and visual quality of the lake is of an acceptable standard	<ul style="list-style-type: none"> The lake is free of litter and debris and/or removed in a timely manner Growth of undesirable marine organisms is absent or regulated Structures are designed and located suitably 	Section 6 and 9
Lake assets are maintained in a structurally sound and safe condition	<ul style="list-style-type: none"> Routine inspections and maintenance are undertaken in accordance with relevant schedules Sinking fund adequate to maintain assets 	Section 9

¹ Secondary contact recreation is any activity where only the limbs are regularly wet, and swallowing water is unusual. Examples of secondary contact recreation are boating, fishing, rowing, kayaking, dragon boating, wading etc.

2 Background

2.1 Site overview

Parrearra Lake Reserve is a brackish artificial tidally restricted lake, 48.6 ha in area, built in accordance with the relevant planning approvals granted by the Department of Natural Resources and Mines and the former Caloundra City Council.

The land abutting the Reserve was developed for urban purposes in accordance with DCP1 - Kawana Waters, except in the south and south east where industrial uses have been established.

The lake is defined as the area contained within the concrete revetment walls upstream of the lock and weir structure adjacent to Chelsea Crescent in the north (Structure Z) to the weir adjacent to the Kawana Industrial Estate in the south (Structure Y). Figure 1 represents the Parrearra Lake system and locality.

The lake has a restricted tidal range of about 300mm and rock protection exists along areas of the bank where design velocities determined such protection was needed when the lake functions as a flood control structure.

Stormwater drainage enters the lake from the adjoining land development through controlled outlet structures and pipes into the lake.

Residents can navigate their powered vessels to Mooloolah River via the lock structure to the north (Structure Z). Public access is available at designated places along the eastern bank and along the substantial majority of the western bank. All public access areas are created as public park abutting the lake. Use of the lake system for recreational purposes is an added benefit and subject to guidelines outlined in this management plan.

2.2 Exclusion

The entry channel between the Mooloolah River and the upstream Structure Y is not included in this Management Plan. This area is designated Drainage Reserve.

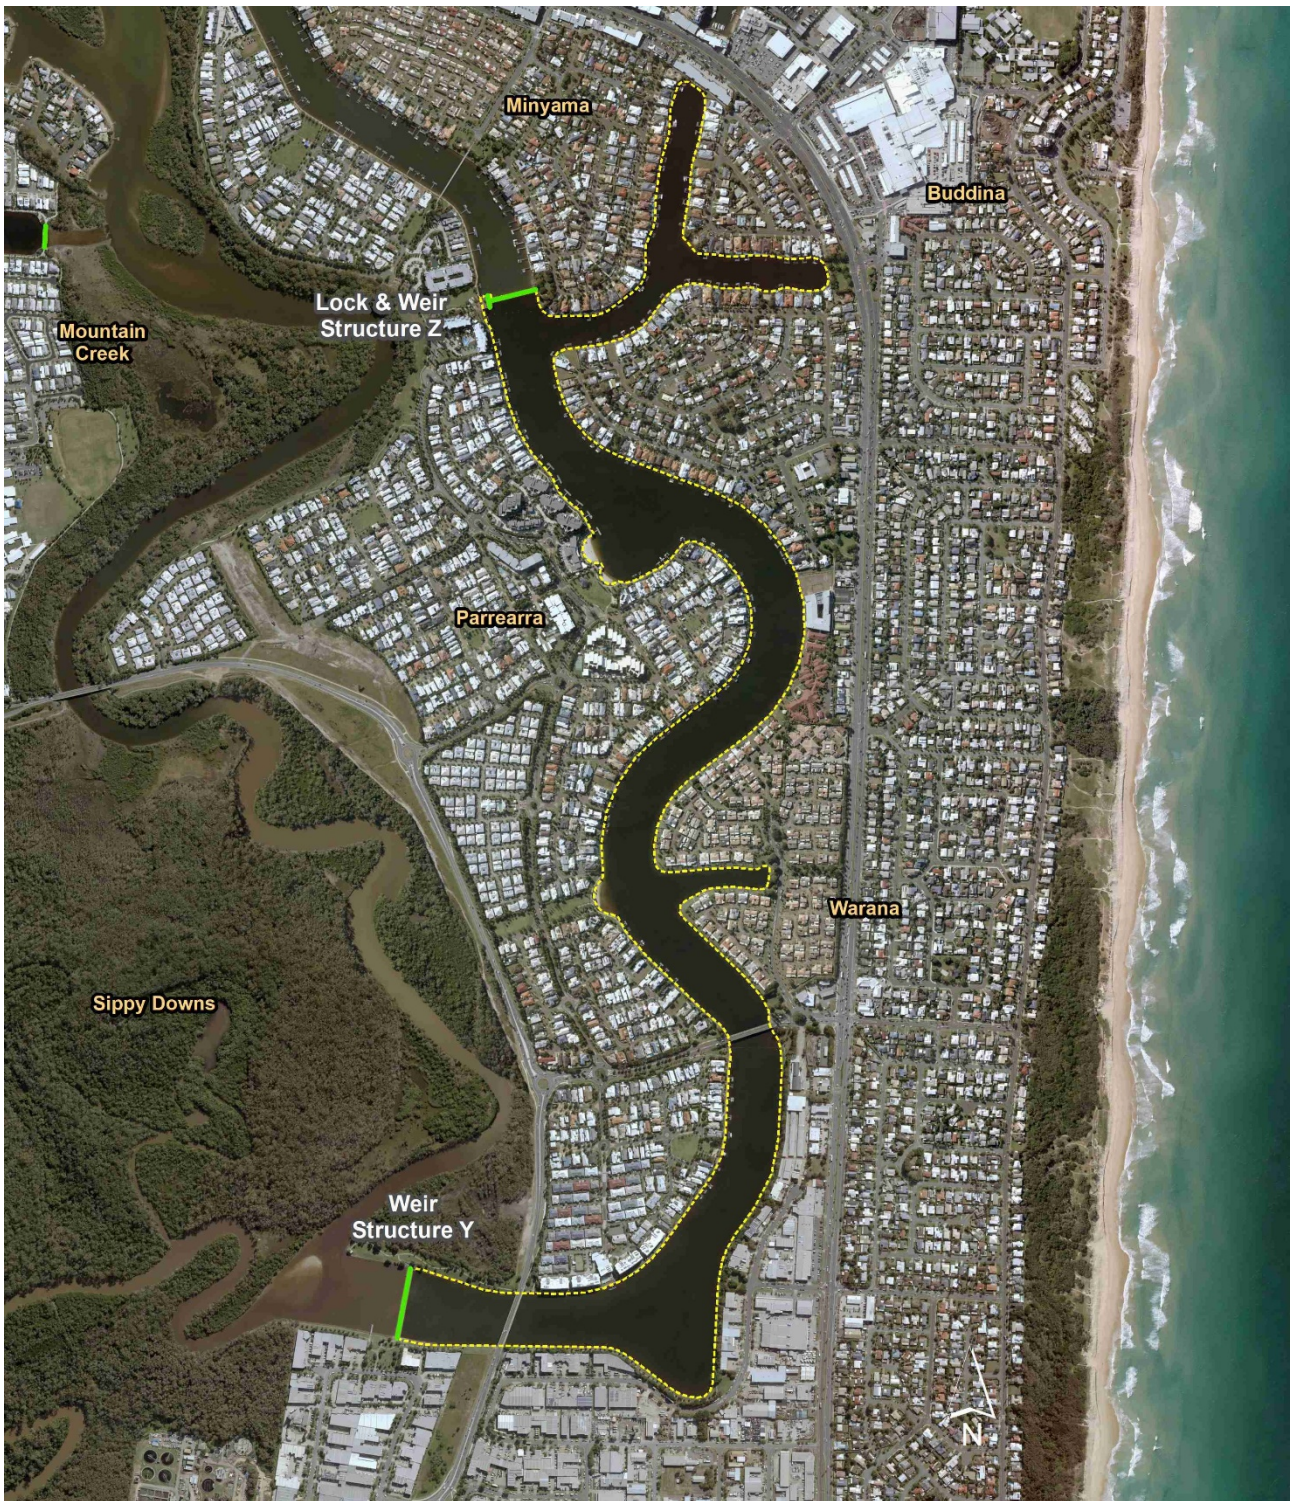





Figure 1: Locality plan


2.3 Assets



The assets included in this management plan are specified in Table 2 below.


Table 2: Lake assets

Assets	Description	Quantity
Southern weir (structure Y)	<p data-bbox="371 405 1249 465">A broad crested weir that controls the entry of flood flows to the Parrearra Channel. Refer design drawings in Appendix A.</p> 	1


Assets	Description	Quantity
<p>Northern weir (structure Z)</p>	<p>A broad crested weir that was constructed to restrict the increase in the tidal prism of the Mooloolah River caused by the construction of the Parrearra Channel. Refer design drawings in Appendix B.</p> 	<p>1</p>
<p>Lock (structure Z)</p>	<p>Allows vessels of a size up to 15 m in length, 4.5 m in width and 2 m draft to pass through safely. There is no height limitation for vessels using the lock, however the bridges within the lake and those further downstream in the Mooloolah River will cause a height restriction. Refer design drawings in Appendix B.</p> 	<p>1</p>


Assets	Description	Quantity
<p>Revetment walls</p>	<p>Lake edge abutting public land only - required to maintain the stability of the lake edge, whilst contributing to the aesthetics and usefulness of the lake.</p> <p>In accordance with the Building Regulations for slab on ground the Finish Floor Level is 0.225m above natural ground level. The top of the revetment wall to residential properties is RL 0.9m AHD.</p> 	<p>Approx. 5,500m</p>


Assets	Description	Quantity
<p>Rock scour</p>	<p>Rock scour provides protection to revetment walls and associated land assets.</p> 	<p>Approx. 8,500 m</p>
<p>Salinity exchange system (northern*)</p>	<p>Salinity exchange system includes pipe, pit and fittings, including an actuated penstock to control flows.</p> 	<p>1</p>


Assets	Description	Quantity
Pontoon	<p data-bbox="371 215 1150 275">Floating platforms built over the water to facilitate lake access and enjoyment.</p> 	2

Assets	Description	Quantity
Viewing platform	<p data-bbox="371 215 1181 277">Platforms built partially over or adjacent to the water to facilitate lake viewing and enjoyment.</p> 	2

Assets	Description	Quantity
<p>Constructed beaches</p>	<p>Beach artificially created to facilitate enjoyment of the lake foreshore areas.</p> 	<p>5</p>

Assets	Description	Quantity
Portages	<p data-bbox="371 215 1206 275">Steps built into the southern weir to facilitate waterway access for non-motor powered craft.</p>  	2

Assets	Description	Quantity
Waterway access	<p data-bbox="371 215 1236 304">Infrastructure facilitating access from public land to the water, e.g. stairs and ramps. There are only 2 accesses in Parrearra which are both stairs for human powered craft.</p> 	2

Assets	Description	Quantity
<p>Gross pollutant trap (GPT)</p>	<p>Gross pollutant traps (GPT's) are provided at most outlets from stormwater drainage systems to the lake. The GPT's provide primary treatment to all road runoff and secondary treatment to surface runoff.</p> <p>Includes those on the western side of the lake only, as those on the east are maintained by the state government (draining a state-owned road).</p> 	<p>23</p>
<p>Stormwater pipe outlet</p>	<p>Stormwater pipes draining directly into the lake. 11 on western side and 20 on eastern side.</p>	<p>31</p>

Assets	Description	Quantity
<p>Aids to navigation</p>	<p>Aids to navigation are usually in the form of a channel marker, buoy or pile and may house a sign, light or beacon.</p> <p>28 piles are located approximately 30m either side of both weirs, with 16 of those housing a beacon.</p> <p>2 blue channel markers are located either side of Kawana Island Blvd bridge.</p> 	<p>28 piles 16 beacons 2 channel markers</p>
<p>Signs</p>	<p>Public signage associated with lake use and safety.</p> 	<p>10</p>

Note: Any assets managed by state government agencies are not included in this management plan e.g. channel markers on Kawana Way Bridge and GPT's draining Nicklin Way.

* the southern salinity exchange at structure Y forms part of the Lake Kawana Management Plan

3 Land tenure and statutory requirements

3.1 History

As a result of a Design Approval granted by the Department of Natural Resources and Mines on the 26 June 1998 for the creation of a waterway (lake) as shown on plan P-2780-54A, plus an earlier similar approval on 20 October 1997 for additional waterway (lake) as shown on plan P-2780-498, the constructed lake was surrendered out of Development Lease No. 2 in stages for the purpose of a Sport and Recreation Reserve under the provisions of the Land Act 1994.

From 1959 to 2001, the land was held as part of Development Lease No. 2 granted to Lensworth Kawana Waters Ply Ltd and was dedicated as a Sport and Recreation Reserve under council's control on 26th April 2002.

3.2 Lake ownership details

Name: State of Queensland (DNRME)

3.3 Lake owner's responsibilities

As trustee of the Reserve, council is responsible for ensuring that the lake system and its infrastructure:

- is maintained to a safe and reasonable standard to the best of council's ability;
- provides adequate amenity for residents and general public;
- maintain its function as an effective flood bypass channel; and
- residents can access downstream Mooloolah River via their powered craft.

Facilitating water-based recreational use is not a responsibility of council, however guidelines are provided in this plan to allow for this additional community benefit of the lake (refer section 5).

3.4 Private landowners responsibilities

Private landowners abutting the lake are responsible for:

- their private property and infrastructure, including any constructed ramp, jetty, deck and/or pontoon;
- stormwater management within their property boundary;
- any pollution or run-off from their property that adversely affects lake water quality; and
- revetment walls fronting their property.

If any maintenance of privately owned revetment walls are required, owners are advised to first speak with council staff and also refer to the following:

- *Sunshine Coast Council Residents' Handbook: Artificial Waterways*;
- standards in section 9.3; and
- recommended typical revetment wall section, as designed in Appendix A.

3.5 Legislation

The Lake Management Plan complies with the following statutory legislation and its associated regulations and policies:

- Local Government Act 2009
 - Sunshine Coast Council Local Laws
- Coastal Protection and Management Act 1995
- Planning Act 2016
- Environmental Protection Act 1994
- Waste Reduction and Recycling Act 2011
- Fisheries Act 1994
- Nature Conservation Act 1992
- Transport Operations (Marine Safety) Act 1994
- Transport Operations (Marine Pollution) Act 1995
- Aboriginal Cultural Heritage Act 2003

4 Lake purpose and function

4.1 Intent for use

The primary purpose of Parrearra Lake is to provide an effective flood control solution for the surrounding urban development (flood bypass channel). Secondary to that is to provide resident's navigational access to Mooloolah River via the lock and maintain amenity and visual quality of public spaces. Additional water-based recreation presents an opportunity for added benefit, however it's not the purpose of the lake.

The lake is intended to be used by the community in a responsible way for their recreational enjoyment, with minimal adverse impact upon the amenity of those dwellings in proximity to the lake. Contact with the water is proposed as secondary contact only (e.g. kayaks, canoes and stand-up paddle board).

4.2 Function of lake as a flood bypass channel

Parrearra Lake forms an essential component of the flood solution for the Kawana Waters development. The lake, together with the Parrearra Canal and the channel between Structure Y and the Mooloolah River form the Parrearra Flood Bypass channel. The development on the flood plain and the associated flood solution incorporating the bypass channel were the subject of extensive hydraulic model testing.

Model testing was undertaken by the University of New South Wales, Water Research Laboratory, under the guidance of the Mooloolah River Hydraulic Model Technical Committee. This committee consisted of representatives of the following organisations:

- Land Administration Commission (Joint Principal)
- Kawana Estates Pty Ltd (Joint Principal)
- Co-ordinator General's Department
- Department of Harbours & Marine
- Department of Local Government
- Landsborough Shire Council
- Maroochy Shire Council
- Cardno & Davies Australia Pty Ltd

At its final meeting on 10 March 1983, the Committee accepted the Water Resource Laboratory report on the testing and commended to the joint principals the ultimate development proposal and flood solution.

The flood solution compensates for the loss of flood storage due to the reclamation on the flood plain by providing additional flood conveyance. This is achieved by the construction of a flood bypass channel through the development.

The lake conveys floodwaters from the river just downstream of the sewage treatment works to re-join the river on the northern side of the Nicklin Way. Downstream of this point, the additional conveyance is provided by dredging the river.

The entry of flood flows to the Parrearra Channel is regulated by a flood control structure located within the channel near its upstream end. The structure is a broad crested weir and has been designated Structure Y. To restrict the increase in the tidal prism of the Mooloolah River caused by the construction of the Parrearra Channel to the limit imposed by the approving authorities, a second broad-crested control structure, Structure Z, was constructed near the downstream end of the channel, approximately 1.5km from its junction with the Mooloolah River. The waterway between the control structures is a tidally restricted lake. Boating access to the lake is provided by a navigation lock incorporated in Structure Z. The Parrearra Canal forms the fully tidal reach of the Parrearra Channel between Structure Z and the river.

5 Lake use

Permitted and prohibited uses are detailed in the following section and must be adhered to at all times.

5.1 Permitted uses

Lake use is open to the general public or 'sports-based' user groups providing the use is a 'permitted use' as described below.

With the exception of enforcement/safety/disaster response craft in emergency situations, the maximum speed must not exceed 6 knots.

Access to the lake is provided via the navigation lock, from private dwellings with direct frontage to the lake, from parks or road reserve.

Council, as the trustee, may from time to time utilise the lake and/or surrounding open space for public events (e.g. markets, public displays etc.).

The following uses and/or actions are permitted in or on the lake:

- human powered craft (e.g. canoe, kayak, row boat and stand-up paddle board);
- small wind powered sail craft;
- model boat;
- motor powered pleasure craft;
- recreational fishing, except as precluded in section 0;
- mobile structures (e.g. dry docks, seapens and float bricks) that are secured to an approved privately owned pontoon or jetty;
- approved maintenance, safety, disaster response and enforcement craft;
- approved construction craft (e.g. barges, dredges and support craft);
- flood storage purposes and to control flood discharge at the weir;
- use of lake water for fire control purposes (e.g. helicopter fire services); and
- any other activity prescribed by council from time to time.

Please note:

All lake users are encouraged to exercise a personal duty of care when accessing the lake system and/or participating in water-based recreation. Recreating in constructed tidal lakes has inherent risks, including but not limited to potentially hazardous marine creatures such as sharks and stingrays.

The water quality in the lake is maintained to a secondary contact standard. At times post major rainfall events the water quality within the lake may be diminished below secondary contact standards (refer section 6 for an overview of council's water quality management of the lake).

Due to the above reasons, direct exposure through swimming is not advised.

5.2 Permitted uses subject to approval

5.2.1 Events, recreational clubs and commercial operations

Council may agree to allow certain low-use/low-impact events, group/club recreational activities and commercial operations to occur on the lake that do not negatively impact on surrounding residents and the overall amenity. The activity must be a permitted use as specified in section 5.1, including (but not limited to) water taxi, vessel hire and other water-based activities/events e.g. SUP lessons, dragon boat user groups, model boats etc. For such operations to be considered for approval, council requires a written submission detailing the type of activity and any potential impact the activity will have on surrounding residents, other users of the lake, water quality, council-owned assets and overall amenity.

Refer to council's [Community Land and Complementary Commercial Activity Policy](#) for more information.

5.2.2 Structures and permanent moorings within the lake

The location of private structures, namely a boat ramp, pontoon, deck or jetty for lot owners abutting the lake, must be approved by council. All works must comply with the standards outlined in the Planning Scheme Policy for Development Works within the Sunshine Coast Planning Scheme 2014.

A Quay Line Plan defines the allowable location of any structures available to an adjacent landowner. All works must be constructed in accordance with the Quay Line Plan in Appendix C.

5.2.2.1 Tenure

Prior to any adjoining lot owner lodging an application for approval to construct a boat ramp, pontoon, deck or jetty on part of the lake, they must enter into a lease over the area containing the proposed structure or works and its appurtenances, from council, in accordance with the provisions of Section 57 of the Land Act 1994. Council will charge an application fee and an annual lease fee for the leased area as determined by council from time to time. The lease term would be to a maximum of 30 years.

The registration on title of the lease into the name of the adjoining lot owner, must be completed before any applications to council for the proposed structure may be made.

5.2.2.2 Approval of works

Private boat ramps, pontoons, decks and jetties contained within the quay line designated area may be approved by council on application by that lot owner, subject to lodgement of engineering plans for the proposed structure and any/all conditions applied by Council.

For lots that directly abut the lake, if part of a pontoon, deck or jetty is proposed to be located within 1.5 metres of the rear boundary of the lot an application for relaxation under the Standard Building Law 1993, will also be required.

Pontoons may be approved by council for allotments abutting the park fronting the lake in the case of Kawana Island.

Construction of any permanent works must be approved by council and a private building certifier before any onsite work commences. Use of the works or structure must not commence until a final inspection and approval to use has been granted by the relevant authority. Failure to obtain the relevant approval or the carrying out of works to a lesser standard than required, may result in an order to remove the offending works.

The use of standard appropriate design structures is encouraged and provided in Appendix D.

5.2.2.3 Exclusivity and restrictions

By the action of granting a lease over the mooring structure or works, exclusivity of use is secured to the adjacent lot owner to whom the lease was granted, to the exclusion of any other user of the lake reserve.

As described in section 1.1, a lock access card is required should a vessel owner wish to use the lock facility to access Mooloolah River.

5.3 Prohibited uses and practices

The following uses or actions are prohibited in the lake:

- events/recreational clubs/commercial operations (SCC approved permits excepted, refer section 5.2.1);
- construction of ramps/pontoons/decks/jetties (SCC approved structures excepted, refer section 5.2.2);
- temporary moorings² (SCC approved event/recreational club/commercial permits excepted, refer section 5.2.1);
- diving or jumping off any structure over or in the lake;
- fishing from the following public infrastructure:
 - bridge;
 - deck/boardwalk;
 - jetty;
 - pontoon;
 - weir; or
 - lock structure.
- motor powered vessels navigating at speeds exceeding 6 knots (with the exception of enforcement/safety/disaster craft in emergency situations);
- waterskiing, freestyling or wave jumping whilst operating any watercraft;
- living on watercraft whether temporarily, intermittently or permanently;
- the construction, reconstruction, refitting or undertaking of structural repairs on or to watercraft;
- unmarked fishing equipment (e.g. crab pots and fish traps);
- refuelling of watercraft;
- dumping or depositing of any wastes (including garden wastes), contaminants or other pollutants into the lake, adjoining waterways or in a place (e.g. road-side gutter or stormwater drain) where it could reasonably be expected to blow or wash into the lake or adjoining waterways; and
- any other activity prescribed by council from time to time.

² Temporary moorings include the use of dry docks, seapens, float bricks etc. that are not secured to an approved pontoon or jetty.

5.4 Lock and weirs

The navigation lock allows vessels of a size up to 15 metres in length, 4.5 metres in width and 2.0 metres draft to pass through safely at low tide. Whilst there is no height limitation for vessels using the lock, the downstream bridges and bridges within the lake will cause a height restriction. The maximum speed limit for vessels navigating the lake is six (6) knots (with the exception of enforcement/safety/disaster response craft in emergency situations).

5.4.1 Lock access

The lock may only be accessed by using a lock access card. These cards must be purchased from the Caloundra and Maroochydore Office of the Sunshine Coast Council. An application form must be completed and the applicable fees need to be paid prior to the issue of the access card. For security and safety of both the lock and residents, a photo identification with permanent address must be attached to the application form.

All access cards include a 2 year replacement warranty and typically last 3-4 years depending on use.

The fees payable to obtain a lock access card can be found on council's website at <https://www.sunshinecoast.qld.gov.au/Pay-and-Apply/Fees-and-Charges>

5.4.1.1 Faulty access card

If an access card is faulty, the following applies:

1. access card to be returned to council;
2. application for replacement card to be completed;
3. if the card is more than 2 years old, pay replacement fee (refer link above);
4. if the card is less than 2 years old and a test confirms the fault, no charge will apply; and
5. new card will be issued

Further enquiries may be made to council's Customer Services Centre staff on 1300 007 272 (local calls) or (07) 5475 7272 (outside local area and mobile phones).

5.4.1.2 Commerciality

Income from the annual fee for lock access cards and annual lease fee for the leased area pursuant to Section 57 of the Land Act 1994, will be retained by council to assist in the maintenance of the lake and abutting public land.

The quantum of the fee or charge will be determined annually by council in association with normal budgetary considerations.

5.1 Abutting public land

Abutting public land is under the control of council. All normal activities that are permitted in parks and on roads are permitted on abutting public land fronting the lake except as may be restricted elsewhere in this Lake Management Plan, or by approved signs erected on such land.

5.2 Temporary restricted use

Council reserves the right to restrict lake use for a specific purpose at any time, if such action is required to either protect public health and safety or prevent pollution of the lake.

5.3 Future development

No further development within the Lake Reserve or on adjacent Reserves is intended by council, unless determined necessary to support the primary purpose and function of the lake.

6 Water quality management

The lake system is best described as a lower catchment flow through system i.e. an artificial waterway which acts as an estuary in some part, where the flow through rate is determined by a salinity exchange system and weir. As such, the water level and flushing can be controlled to ensure ideal conditions.

Influences on water quality in the lake system are therefore principally impacted by:

- appropriate exchange of water;
- up-stream catchment practices;
- surrounding urban runoff (i.e hydrocarbons, particulates, pesticides, herbicides etc.);
- activities associated with vessel maintenance; and
- colonisation by marine organisms. Certain species may proliferate at times of elevated nutrient levels and cause other environment and human health risks e.g. algal blooms

Table 3 provides a framework to effectively manage these influences to ensure acceptable water quality is maintained.

Table 3: Water quality management overview

Objective	Water quality is maintained to a standard suitable for secondary contact recreation
Performance standards	<ul style="list-style-type: none"> • Water quality is maintained in accordance with scheduled water quality objectives for secondary contact recreation in the Environmental Protection (Water and Wetland Biodiversity) Policy 2019 and Guidelines for Managing Risks in Recreational Water (NHMRC 2008) • Reactive water quality sampling is in accordance with the methods prescribed in the Queensland Monitoring and Sampling Manual (2018) • Growth of undesirable marine organisms is absent or regulated
Management controls	<ol style="list-style-type: none"> 1. Maintain impervious and/or vegetated overland flow paths in accordance with routine inspection and maintenance schedules 2. Maintain stormwater drainage systems and GPTs in accordance with routine inspection and maintenance schedules 3. Maintain salinity exchange systems and weir in accordance with routine inspection and maintenance schedules 4. Educate residents and public to reduce pollutant run-off and/or input (e.g. signage, residents' handbook and website)
Corrective action	<ul style="list-style-type: none"> • If the relevant water quality guidelines are exceeded, or a trend of declining water quality develops over an extended period, it will be considered to indicate the need for reassessment of the appropriateness and effectiveness of existing water quality management controls • Erection of temporary signage if determined necessary
Monitoring	<ul style="list-style-type: none"> • Visual monitoring to be undertaken concurrent with routine inspections and/or maintenance schedules • Water quality sampling will be undertaken on a reactive basis if requested and determined necessary • Maintain customer service request records and incident/non-compliance register
Reporting	The results of monitoring will be made available to the public at council's discretion and by request only
Responsibility	SCC

7 Flood bypass management

During the design 100 year average recurrence interval flood event, the bypass channel conveys a peak discharge of 370m³/s. Maximum water levels in the lake are RL 2.7m AHD just upstream of Structure Z and RL 2.8m AHD just downstream of Structure Y. At the peak discharge the average flow velocity in the lake is 0.55m/s.

The minimum level of blocks are RL 3.3m AHD just upstream of Structure Z and RL 3.5m AHD just downstream of Structure Y.

In accordance with the Building Regulations for slab on ground the Finish Floor Level is 0.225m above natural ground level. The top of the revetment wall to residential properties is RL 0.9m AHD.

Table 4 provides an overview of management to ensure the lake continues to provide an effective flood bypass solution.

Table 4: Flood bypass management overview

Objective	The lake continues to function as an effective flood bypass channel
Performance standards	<ul style="list-style-type: none"> No flooding above Q100 level Compliance with design criteria for lake operation as a flood channel Effective operation and maintenance of tidal exchange system and weir Maintain lake to acceptable tolerances from design profile
Management controls	<ol style="list-style-type: none"> Adherence to maintenance procedures in Appendix E Adherence to asset management plans Asset inspections and maintenance schedules met
Corrective action	<ul style="list-style-type: none"> Undertake reactive inspection and maintenance of flood mitigation devices (salinity exchange system & weir) Review incident and where required review procedures to ensure effective measures are in place to meet performance standards
Monitoring	<ul style="list-style-type: none"> Visual monitoring undertaken during asset inspections and maintenance View CCTV at structure Z Maintain customer service request records
Reporting	<ul style="list-style-type: none"> Contractor maintenance reports Asset inspections logs
Responsibility	SCC and maintenance contractor

8 Incident, non-compliance and complaint management

Table 5: Incident, non-compliance and complaint management overview

Objective	To ensure prompt and efficient response to pollution, environmental incidents, complaints and non-compliance
Performance standards	<ul style="list-style-type: none"> • Prompt removal of pollution spillages from waterways with minimum risk to the public and the environment • All complaints and non-compliance are dealt with promptly and efficiently, in accordance with council's Compliance and Enforcement Policy 2018 • Appropriate investigations are undertaken to determine the source of pollution and the cause of environmental incidents (e.g. oil spills, fish kills and algal blooms)
Management controls	<ol style="list-style-type: none"> 1. Adherence to asset management plans 2. Asset inspections and routine maintenance schedules met 3. Adherence to water quality management procedures (refer section 6) 4. Sufficient signage to communicate prohibitions outlined in this management plan (refer 0)
Corrective action	<ul style="list-style-type: none"> • Pollution spill, fish kill or other environmental incident - report to the Department of Environment and Science to ensure that appropriate investigations and testing are undertaken • Address and/or rectify incident, complaint and/or non-compliance • Review customer service requests and incident/non-compliance register and implement improvement to processes and/or signage where deemed necessary
Monitoring	<ul style="list-style-type: none"> • Follow up monitoring to be undertaken in the event of an environmental incident • Maintain customer service request records and incident/non-compliance register
Reporting	Complete the appropriate incident report/debrief when required or requested
Responsibility	SCC

9 Maintenance

9.1 General

Maintenance of the lake and its assets are the responsibility of council and includes routine, planned and reactive maintenance work activities.

Maintenance work is managed through an asset management system and includes activities such as inspection, assessing condition, prioritising, scheduling, actioning the work and reporting what was done to develop a maintenance history and improve maintenance and service delivery performance.

Routine maintenance is performed on a regular cycle to upkeep visual amenity and/or replacement of components/sub-components of assets. This work generally falls below the capital threshold. Planned maintenance comprises larger scale repair work (below the capital threshold) or asset renewal (capital work). Reactive maintenance is unplanned repair work carried out in response to service requests and management/supervisory directions.

Types of maintenance may include:

- on-going maintenance of the navigation locks and inlet/outlet weirs;
- on-going maintenance of the salinity exchange system;
- removal of siltation from bed and banks of the lake, as required, to ensure that it does not become a constraint on the function of the lake;
- removal of debris, rubbish and undesirable marine organisms/weeds from the lake and public foreshore areas;
- maintaining the revetment walls where they front public lands;
- maintaining scour that supports all revetment walls; and
- maintaining navigation aids within the lake etc.

Refer Table 6 which outlines the entire maintenance framework and regimes.

9.2 Maintenance management

The following section provides an overview of the maintenance framework for lake features and assets to meet specific management plan objectives outlined in Table 1. Refer Appendix E to view associated weir and lock maintenance procedures.

Table 6: Maintenance framework overview

Feature / asset	Performance standard	Performance indicator	Comments / considerations	Inspection frequency	Routine maintenance frequency	Responsibility
Waterway feature						
Litter, debris etc.	Waterways are free of litter and debris that are impacting on amenity, health and/or safety	a) Inspection and maintenance schedules met b) Reactive works undertaken in a timely manner c) No complaints	<ul style="list-style-type: none"> Officers undertaking litter removal should ensure that appropriate precautions are taken against hazardous objects such as discarded hypodermic syringes Collected litter should be recorded in AMDI database and disposed of at council's refuse tip A public education programme should be considered by council if litter is a persistent problem If fishing equipment (e.g. crab pot or fish trap) is found either unmarked and/or in state of disrepair to a point of it being non-functional then it shall be removed as marine litter (report to DAFF for their agency to remove) 	Monthly	Monthly	SCC Waterways team
Undesirable marine organisms / weeds	Growth of undesirable marine organisms is absent or regulated	a) Inspection schedule met b) Reactive works undertaken in a timely manner c) No complaints	<ul style="list-style-type: none"> Any vegetation or plant material, living or dead, located below the level of the highest astronomical tide (approximately RL 1.05m AHD) is classified as "marine vegetation" under the Fisheries Act. Refer to relevant fisheries <i>accepted development requirements</i> before undertaking any works involving marine vegetation Although herbicides are a possible means of weed control, only herbicides registered for use in aquatic environments should be used All removed vegetation should be disposed of at council's refuse tip In the event of algal blooms, refer to Queensland Harmful Algal Bloom Response Plan 2014. Appropriate laboratory testing should be undertaken to determine the species present and likely cause of the outbreak. If testing indicates the presence of toxic species, specialist advice should be sought regarding any necessary health precautions. 	6 monthly	No routine maintenance. Any required works are determined based on inspection condition assessment	SCC Lakes and Wetlands team
Lake profile	Lake is maintained to acceptable tolerances from design profile	a) Survey completed as scheduled b) Maintenance is undertaken in a timely manner before degradation of waterway profile affects vessel movement or the stability of revetment walls c) No complaints	<ul style="list-style-type: none"> Appropriate geotechnical and chemical testing should be undertaken of material proposed to be dredged or excavated in maintenance operations Approvals to undertake dredging, or other excavation, within a waterway are required under the Planning Act 2016 (Tidal Works) and the Environmental Protection Act 1994 (ERA 16) (dependant on volume of material to be managed) 	7 yearly	No routine maintenance performed. Any required works are determined based on visual observation and 7 yearly lake survey	SCC Coast & Canals team
Constructed beaches	Accessible, safe and provides adequate amenity and visual quality	a) Open for use 90% of the time b) Clear of marine fouling and debris c) Safe d) Inspection schedule met e) Reactive works undertaken in a timely manner f) No complaints	<ul style="list-style-type: none"> Weeding is performed by physical / mechanical means, no herbicides to be used Sand profiles are maintained as designed 	6 monthly	No routine maintenance. Any required works are determined based on inspection condition assessment	SCC Coast & Canals team
Infrastructure						

Feature / asset	Performance standard	Performance indicator	Comments / considerations	Inspection frequency	Routine maintenance frequency	Responsibility
Tidal exchange system	The system is operating as designed and providing effective flood management and water flows	a) Water is turned over every 60 days b) Floods successfully mitigated c) Inlet and outlet structures are not impeded by marine growth or sedimentation d) Inspection and maintenance schedules met e) Reactive works undertaken in a timely manner f) No complaints	Underwater inspections of the structures are likely to be required. This applies particularly to the inlet structure. A qualified commercial diver should be employed for this work and the required safety measures implemented	Fortnightly	Annual	SCC Coast & Canals team
Lock	Provides effective and safe access for marine vessels transporting in and out of the lake system	a) Inspection and maintenance schedules met b) Reactive works undertaken in a timely manner c) No complaints from lock access card holders	Refer Appendix E for maintenance procedures. Refer Section 5.4.1 for more information on lock access and cards	Fortnightly	As per maintenance procedures	SCC Coast & Canals team Contractor
Weirs	The system is operating as designed and providing effective flood management	a) Floods successfully mitigated b) Inspection and maintenance schedules met c) Reactive works undertaken in a timely manner d) No complaints	Refer Appendix E for maintenance procedures	Fortnightly	As per maintenance procedures	SCC Coast & Canals team
Revetment wall	Revetments are maintained in a suitable condition to provide satisfactory protection to adjacent land and assets	a) Structure maintained to design b) Inspection schedules met c) Reactive works undertaken in a timely manner d) No complaints	<ul style="list-style-type: none"> The stability of revetment walls and other concrete structures is heavily reliant on the condition of the associated scour (see scour maintenance below) The maintenance of revetments is the responsibility of the abutting landowner (i.e. council for public land only). However, council are responsible for the associated scour and thus must ensure it is adequate to protect private landowners' revetment 	Annually	No routine maintenance. Any required works are determined based on inspection condition assessment	SCC Coast & Canals team
Scour	Scour are maintained in a suitable condition to provide satisfactory protection to revetment walls	a) Structure maintained to design b) Inspection schedules met c) Reactive works undertaken in a timely manner d) No complaints	<ul style="list-style-type: none"> The stability of revetment walls and other concrete structures can be rapidly compromised due to the loss of foundation support if the associated scour are not well maintained Council are responsible for maintaining all scour including those abutting private land 	Annually	No routine maintenance. Any required works are determined based on inspection condition assessment	SCC Coast & Canals team
Stormwater outlets	Provides effective drainage of stormwater run-off	a) Structure maintained to design standards b) Inspection and maintenance schedules met c) Reactive works undertaken in a timely manner d) No complaints	Piping failures, resulting in loss of support behind and beneath stormwater drainage outlet structures can result in rapid deterioration of these structures. This damage can quickly spread to adjacent revetment walls. It is important, for the longevity of these structures, to ensure that piping problems are promptly addressed	Annually	Annually	SCC Stormwater Services team
GPT's	Provides an effective pollutant trap to minimise litter, debris and sediment from entering the lake system	a) Structure maintained to design b) Inspection and maintenance schedules met	Refer to manufacturer for design standard details	Monthly	Annually	SCC Stormwater Services team

Feature / asset	Performance standard	Performance indicator	Comments / considerations	Inspection frequency	Routine maintenance frequency	Responsibility
		<ul style="list-style-type: none"> c) Reactive works undertaken in a timely manner d) No complaints e) Minimal litter, debris and sediment entering the lake directly from stormwater outlets 				
Viewing platform	Accessible and safe, providing additional enjoyment of the lake amenity	<ul style="list-style-type: none"> a) Structure maintained to design b) Open for use 90% of the time c) Inspection schedule met d) Reactive works undertaken in a timely manner e) No complaints 		6 monthly	No routine maintenance. Any required works are determined based on inspection condition assessment	SCC Transport Infrastructure team
Jetty/pontoon	Accessible, user-friendly and safe, providing additional access and enjoyment of the lake	<ul style="list-style-type: none"> a) Structure maintained to design b) Open for use 90% of the time c) Clear of marine fouling and debris d) Inspection schedule met e) Reactive works undertaken in a timely manner f) No complaints 		Annually	No routine maintenance. Any required works are determined based on inspection condition assessment	SCC Coast & Canals team
Waterway accesses (including portages)	Accessible, user-friendly and safe, providing additional access and enjoyment of the lake	<ul style="list-style-type: none"> a) Structure maintained to design b) Open for use 90% of the time c) Clear of marine fouling and debris d) Inspection schedule met e) Reactive works undertaken in a timely manner f) No complaints 		Annually	No routine maintenance. Any required works are determined based on inspection condition assessment	SCC Coast & Canals team
Signs	Signs are reader-friendly, clearly visible, safe, and do not impact on the visual qualities of the lake	<ul style="list-style-type: none"> a) Structure maintained to design b) Inspection schedule met c) Reactive works undertaken in a timely manner d) Vessel operators are compliant with marine safety laws e) No complaints 	If non-compliance and/or complaints register indicate a growing trend of users whom are not complying with regulations, assess suitability of all forms of public education, including signage. Implement any improvements where determined necessary (see more section 8)	Annually	No routine maintenance. Any required works are determined based on inspection condition assessment	SCC Coast & Canals team
Beacons, piles and channel markers	Effectively assist vessel operators to safely navigate the lake, without negatively impacting on vessel traffic or amenity	<ul style="list-style-type: none"> a) Structure maintained to design b) Inspection schedule met c) Reactive works undertaken in a timely manner d) No complaints or on-water incidents 		Annually	No routine maintenance. Any required works are determined based on inspection condition assessment	SCC Coast & Canals team

9.3 Standards and specifications

Maintenance work is carried out in accordance with the following standards and specifications.

1. Building Code of Australia
 - a) BCA Vol 2 Part 3.1.2.0 – Drainage (AS 3500.3.2)
 - b) BCA Vol 2 Part 3.1.2.2 (d) – Excavation and Piling near Sewers and Drains
 - c) BCA Vol 2 Part 3.1.1 – Earthworks
2. Australian Standards
 - a) AS 1141: Methods for sampling and testing aggregates
 - b) AS 1428: Design for Access and Mobility
 - c) AS 1604: Treatment of piles
 - d) AS 1664.1: Aluminium Structures Code
 - e) AS 1665: Welding
 - f) AS 1170.1 and 1170.2: Loading Codes
 - g) AS 1650 Galvanising
 - h) AS 1720: Timber Structures Code
 - i) AS 2159: Piling Code
 - j) AS 2239: Galvanic (Sacrificial) Anodes for Cathodic protection
 - k) AS 2312 Two Pack Epoxy Paints
 - l) AS 2832.3 Guide to the Cathodic protection of metals-fixed immersed structures.
 - m) AS 3500: Part 3.2, Stormwater Drainage – Acceptable Solutions
 - n) AS 3600: Concrete Structures Code
 - o) AS 3700: Masonry Structures Code
 - p) AS 3706: Geotextiles Methods of test
 - q) AS/NZ 3004: Marinas and Recreational Boats
 - r) ANZECC: Guidelines for fresh and Marine Water Quality
 - s) AS 3962: Guidelines for Design of Marinas Code
 - t) AS 4110: Steel Structures Code
 - u) AS 4133: Methods of testing rocks for engineering purposes
 - v) AS 4997: Guidelines for the design of maritime structures
3. SEQ Restoration Framework, Guideline & Manual
4. Healthy Waterways – Water sensitive Urban Design – Technical Design Guidelines for SEQ
5. Healthy Waterways – Water by Design Construction and Establishment Guidelines
6. Any other relevant regulations, policies, codes and/or guidelines that fall under the Acts listed in section 3.5.


10 Contacts

Entity	Contact details	Enquiry type
Sunshine Coast Council - Customer Service	(07) 5475 7272 1300 007 272	All
Maritime Safety Queensland	(07) 5373 2310 A/H (07) 3305 1700	Marine safety and marine pollution, including oil spills
Mooloolaba Coast Guard	Radio: 88-90, 16-67-21-73-80 (07) 5444 3222	Marine safety
Sunshine Coast District Water Police	(07) 5457 6711 A/H 0438 200 705	Search and rescue, on-water criminal matters and marine safety complaints
Queensland Boating and Fisheries Patrol	(07) 5444 4599 (Mooloolaba)	Marine safety and fisheries complaints
Department of Environment & Science	1300 130 372	Involving pollution, environmental harm, fish kills and marine strandings
Department of Agriculture and Fisheries	(07) 3404 6999	Involving marine plants
RSPCA QLD	1300 ANIMAL (1300 264 625)	Involving injured wildlife. Will likely be attended by Queensland Parks and Wildlife Service (QPWS)

11 Review

This document may be reviewed and updated as determined necessary by council in response to new information, challenges in implementation or changing external factors such as technology, land use, the environment, legislation and community values.


Appendix A: Structure Y Design Drawings

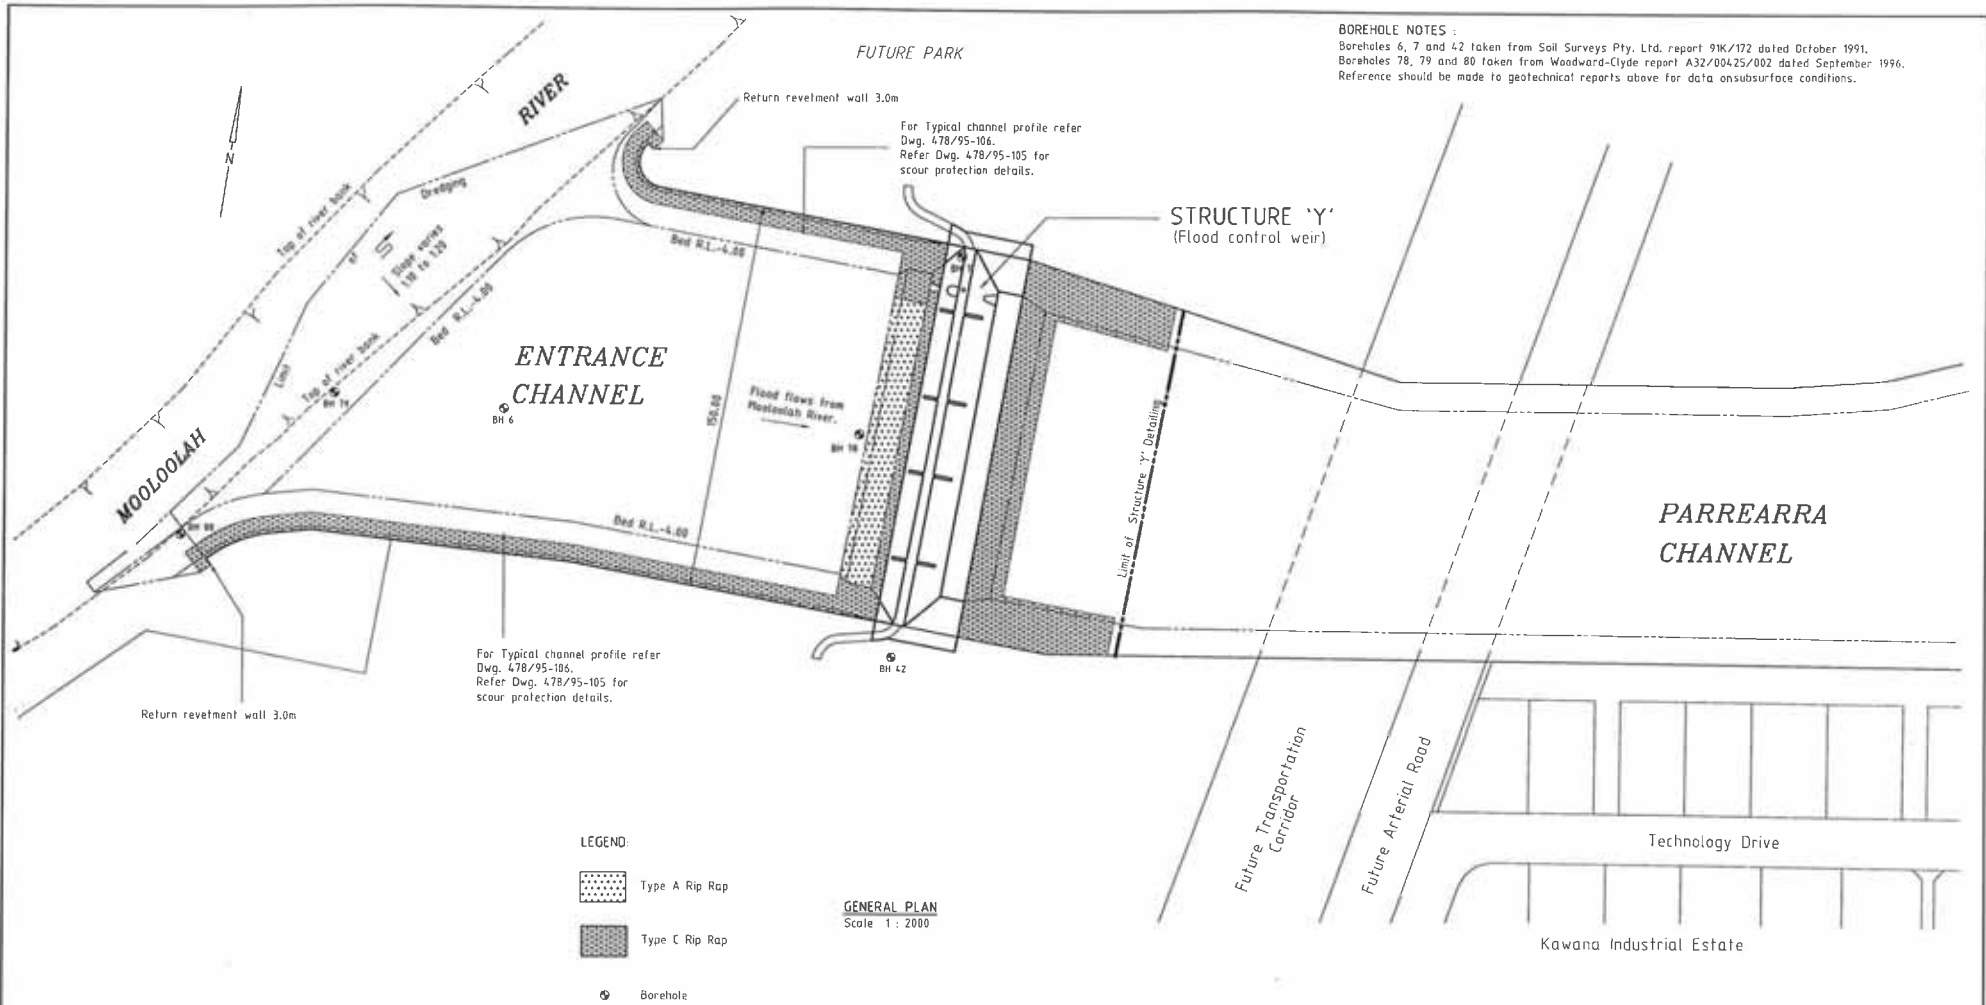

BOREHOLE NOTES :
 Boreholes 6, 7 and 42 taken from Soil Surveys Pty. Ltd. report 91K/172 dated October 1991.
 Boreholes 78, 79 and 80 taken from Woodward-Clyde report A32/00425/002 dated September 1996.
 Reference should be made to geotechnical reports above for data on subsurface conditions.

- LEGEND**
-  Type A Rip Rap
 -  Type C Rip Rap
 -  Borehole

GENERAL PLAN
 Scale 1 : 2000

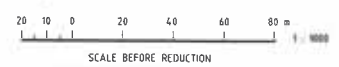


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Proposed Access path
Refer Dwg. 478/95-122

24.50



ENTRANCE CHANNEL

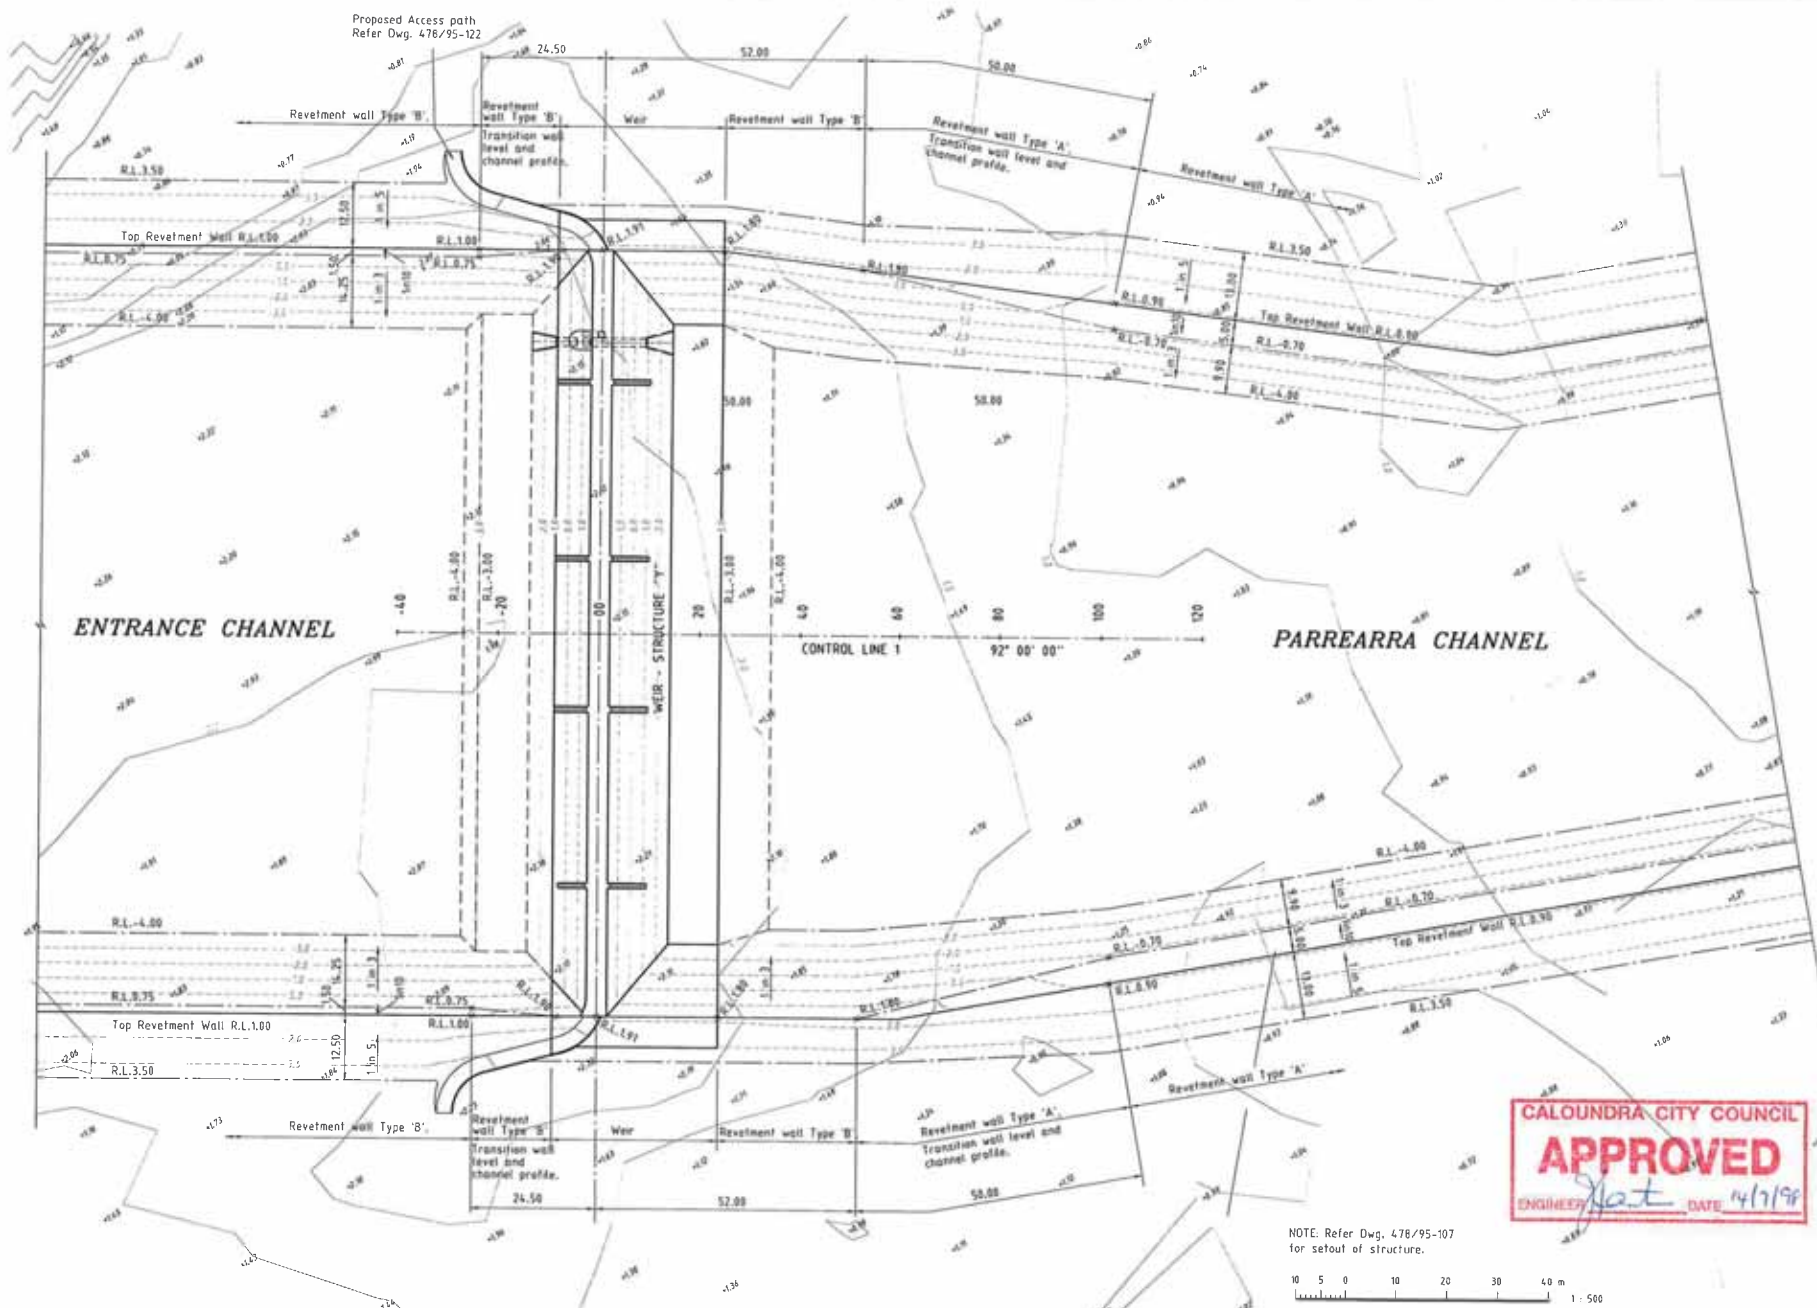PARREARRA CHANNEL

CONTROL LINE 1 92' 00' 00"

CALOUNDRA CITY COUNCIL
APPROVED
ENGINEER *Joel* DATE 14/7/98

NOTE: Refer Dwg. 478/95-107
for setout of structure.




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DATE: 1-10-1997 TPC 547 PH

REVISIONS NO. DATE BY 1 10-03-98 General revision 2 14-07-98	DRAWN C.D. Davies CHECKED C.S. 34 ENGINEER C.S. 34	A1 A.H.D. CONSULTING ENGINEERS	Cardno & Davies Queensland Pty. Ltd. 401, 81 St. St. Consulting Engineers	OFFICE TELEPHONE: Brisbane 017 554 9122 Gold Coast 017 554 9122 Ipswich 017 554 9122 Mackay 017 554 9122 Mount Isa 017 554 9122 Townsville 017 554 9122 Cairns 017 554 9122 Hervey Bay 017 554 9122 Port Moresby 017 554 9122	KAWANA ESTATES PTY. LTD. PARREARRA DEVELOPMENT STRUCTURE 'Y' EARTHWORKS AND EXISTING LEVELS PLAN	DATE 21-01-1997
						DRAWING NO. 478/95-102


DATUM R.L. -7.00

EARTHWORK QUANTITIES (In Cubic Metres)	FILL CUT	
	DEPTH (m)	HEIGHT (m)
CUT (Depth of)	6.30	
FILL (Height of)		5.10
EXCAVATION LEVELS		
SURFACE LEVELS		
PEGGED DISTANCE		

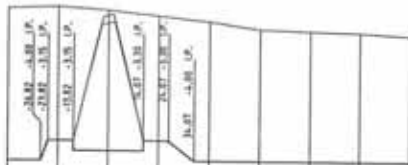


LONGITUDINAL SECTION

HOR. 1 : 1000
VERT. 1 : 100

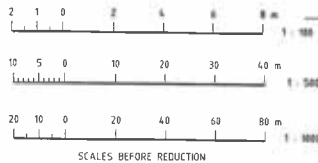

SCALES BEFORE REDUCTION

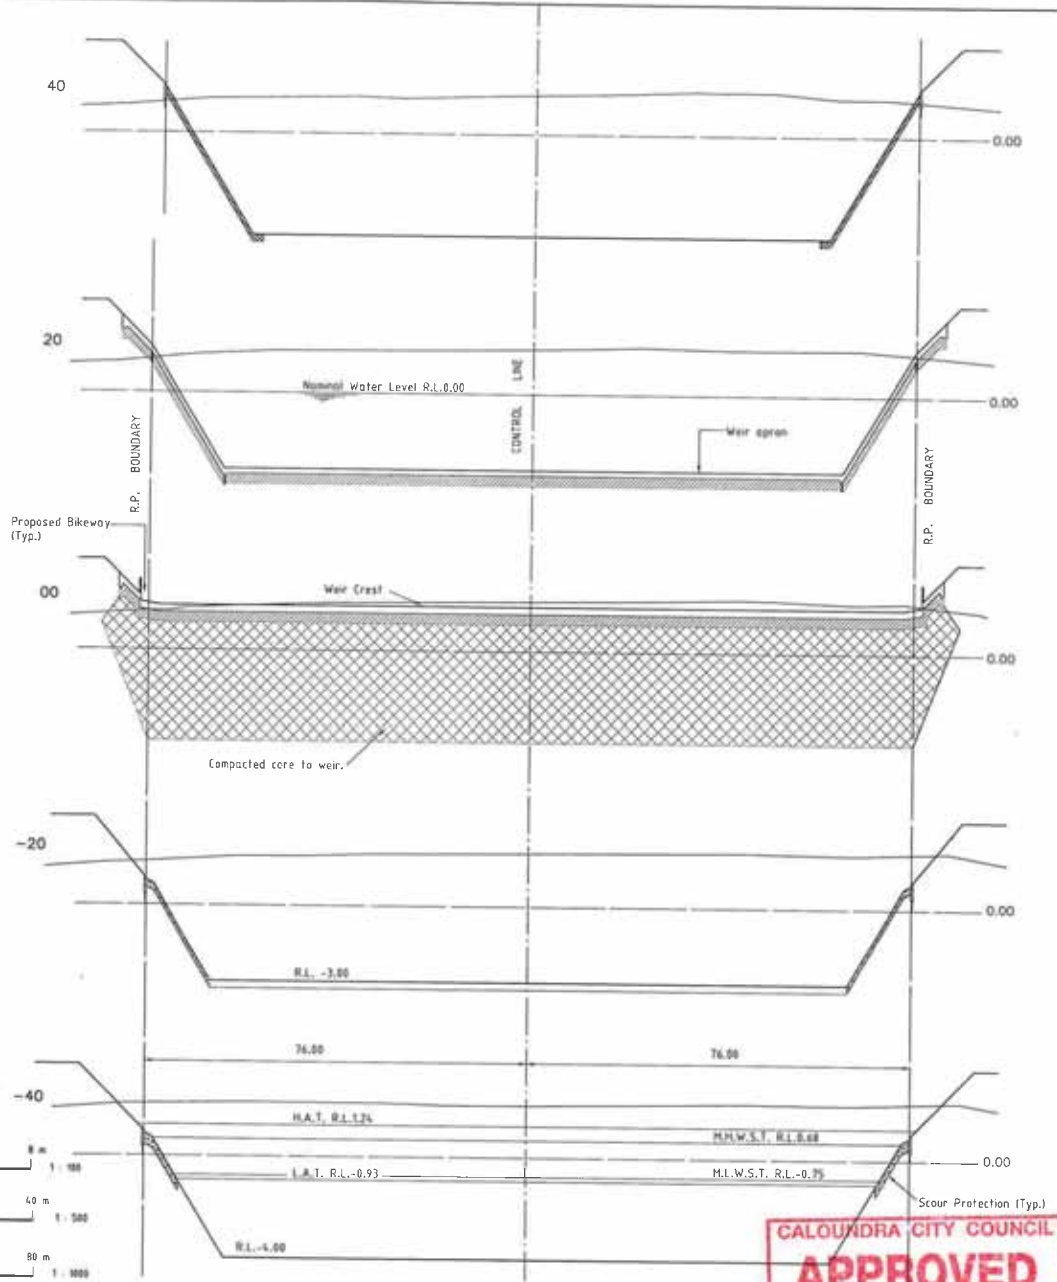






CROSS SECTIONS

HOR. 1 : 500
VERT. 1 : 100

CALOUNDRA CITY COUNCIL
APPROVED
ENGINEER *glat* DATE 14/7/95

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DATE : 11/07/95 TIME : 12:05 PM

SEARCHED DRAWN CHECKED APPROVED DATE	A.I. A.H.D. 	 Cardno & Davies Queensland Pty. Ltd. CONSULTING ENGINEERS	PROJECT NO. JOB NO. DRAWING NO. DATE	KAWANA ESTATES PTY. LTD. PARREARRA DEVELOPMENT STRUCTURE 'Y' CONTROL LINE 1 LONGITUDINAL SECTION AND CROSS SECTIONS	SHEET NO. TOTAL SHEETS DATE: 21.07.1995 DRAWING NO.: 478/95-103
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ROCK GRADING TABLE

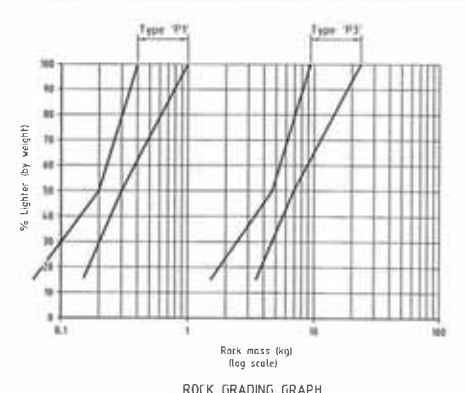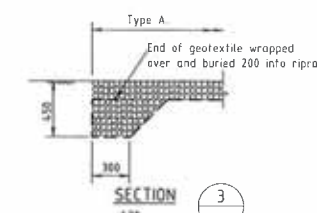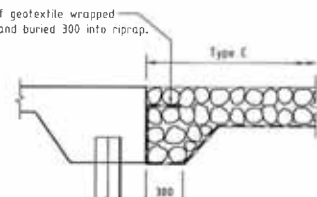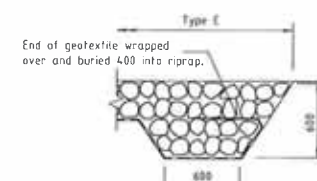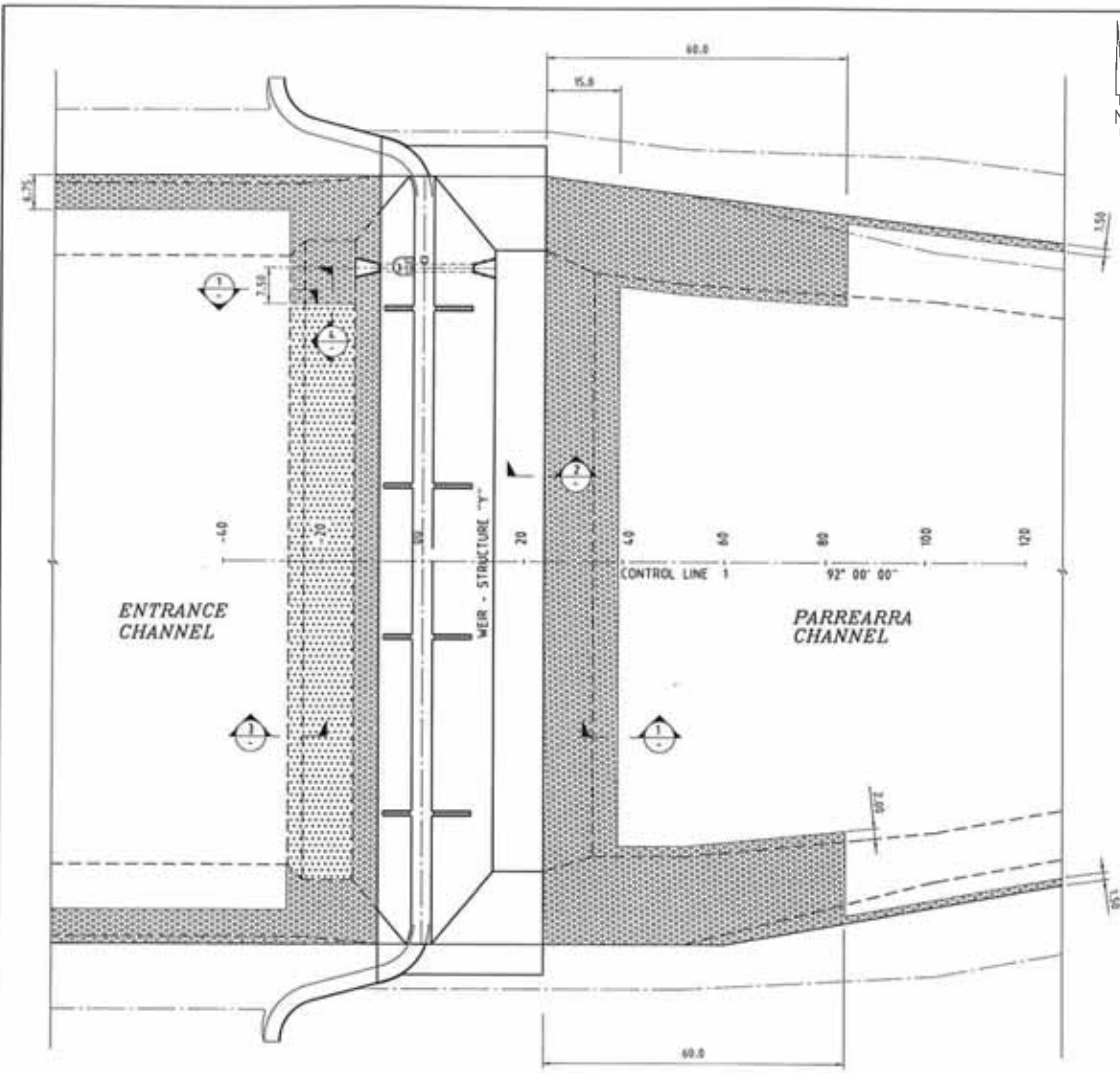SIZE	PARAMETER RANGE	ROCK TYPE	
		P1	P3
W ₁₅	min.	0.06	1.50
	max.	0.35	3.50
W ₅₀	min.	0.20	4.70
	max.	0.30	7.00
W ₁₀₀	min.	0.40	9.40
	max.	1.00	24.00

All gradings given in dry mass (kg.)


GEOTEXTILE SPECIFICATION TABLE

Property	Test	Geotextile Class B
Minimum grab tensile strength (N)	AS2001.2.3	1600
Minimum G Rating	Austrroads	3000
Minimum trapezoidal tear strength (N)	AS3706.3	400
Maximum pore size (EOS μm)	AS3706.7	200
Minimum permittivity (s ⁻¹)	AS3706.9	0.5


Refer Note No.8

NOTES


1. A representative sample of rock shall be obtained from the quarry in accordance with AS114.1.3.
2. The dry density of the rock shall not be less than 2500 kg/m³ in accordance with AS4133.2.1.2.
3. The ratio of maximum to minimum dimensions of any rock shall not exceed three.
4. The Los Angeles value of the rock shall not exceed 20 in accordance with AS114.1.2.3.
5. The maximum permissible loss for each fraction shall be 12% in accordance with AS114.1.2.4.
6. Geotextile fabric shall be topped 1000mm minimum and shall be keyed at the edges to the satisfaction of the Superintendent.
7. Rock of larger size may be substituted if approved by the Superintendent. If larger rock is used, specified layer thicknesses must be increased whilst maintaining nominated finished levels and profiles.
8. Geotextiles shall be non-woven, needle punched fabrics consisting of polyester or polypropylene polymers.

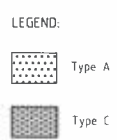


PLAN
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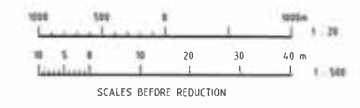
TYPE A RIP RAP SECTION
Scale 1 : 20

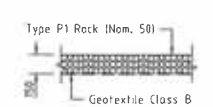

TYPE C RIP RAP SECTION
Scale 1 : 20

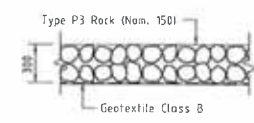


SECTION 4
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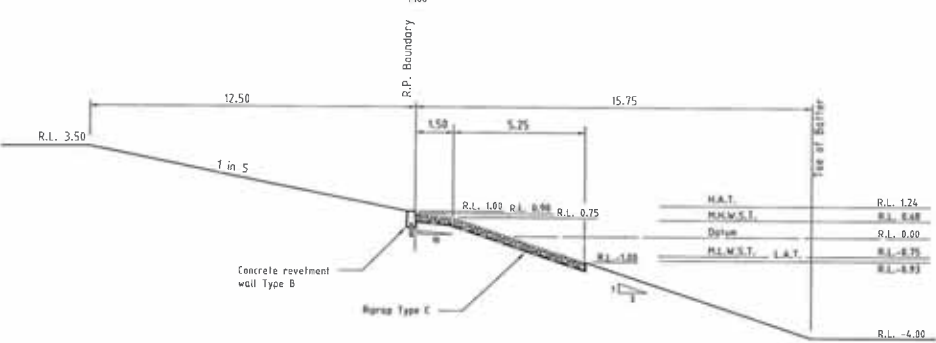

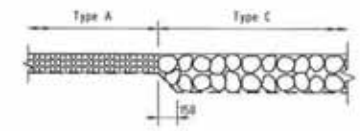
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<p>A1 A.H.D.</p> <p>CARDNO & DAVIES Queensland Pty. Ltd. CONSULTING ENGINEERS</p>					<p>KAWANA ESTATES PTY. LTD. PARREARRA DEVELOPMENT STRUCTURE 'Y'</p>
<p>SCOUR PROTECTION PLAN</p>					<p>478/95-105</p>




TYPICAL PARREARRA CHANNEL PROFILE

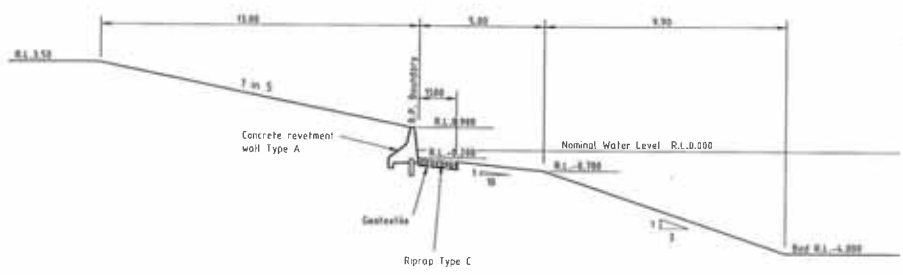


TYPICAL ENTRANCE CHANNEL PROFILE

- NOTES:**
- All concrete quality and construction procedures shall be in accordance with A.S.3600
 - Concrete shall be Class S40 as specified.
 - Concrete to be sprayed with approved curing membrane at the application rate specified by the manufacturer. Apply within 1 hour of concrete pour or as directed by the Superintendent.
 - All exposed edges shall be chamfered 25mm.
 - Construction joints to revetment walls to be at 6.00m centres.
 - A 3.00m return wall shall be constructed at the end of each stage of construction and backfilled to the specified standards.
 - 'Terrafix' drainmat to be continuously sealed with approved sealant. Lap in accordance with manufacturer's specifications.


- LEGEND:**
- BC 2 Coat Bitumen Paint before pouring second concrete
 - 10.F 10 Joint Filter (fixed to one face with 30 long copper nails at 200 centres)
 - 10S Sealant 10x10 with bond breaker and backing strip
 - CJ Construction Joint

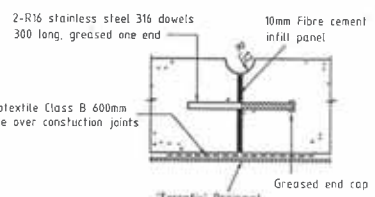


CONSTRUCTION JOINT (C.J.)

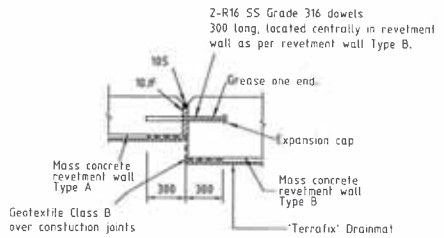


CONSTRUCTION JOINT
REVESTMENT WALL TYPE A TO TYPE B

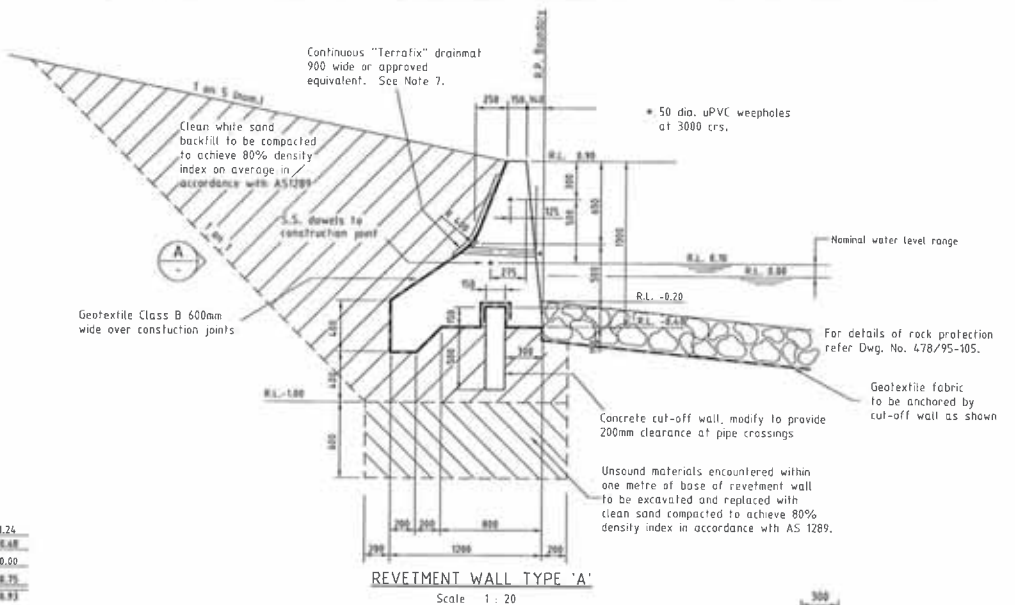


REVESTMENT WALL TYPE 'A'

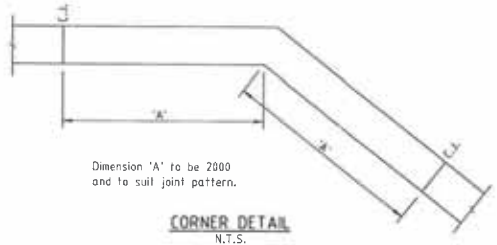


CORNER DETAIL
N.T.S.

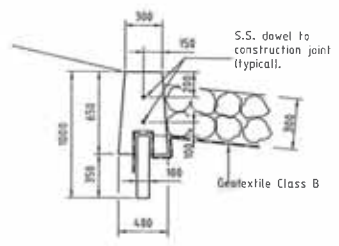


REVESTMENT WALL TYPE 'B'

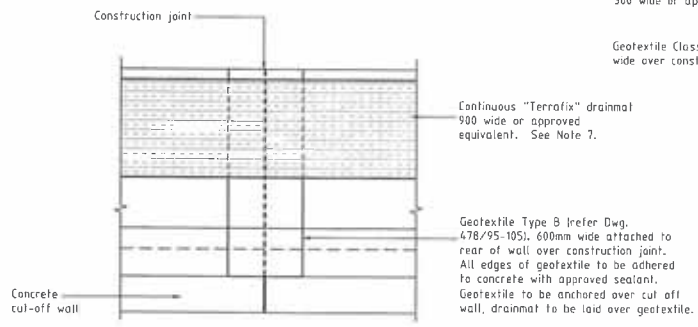

VIEW A
1:20

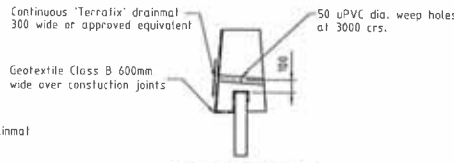

WEEPHOLE DETAIL
Scale 1:20

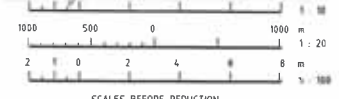

SCALES BEFORE REDUCTION

AUTOCAD 12.05 FILE NAME: 478-106.DWG
DATE: 6-20-95 TIME: 4:30 PM



NO.	REVISION	DATE	BY	CHECKED	APPROVED

C&D Cardno & Davies
Queensland Pty. Ltd.
Consulting Engineers


ADDRESS: 101/238 9272
GPO Box 1111
Brisbane QLD 4001
TELEPHONE: 07 3241 2200
FACSIMILE: 07 3241 2200
POSTAL ADDRESS: PO Box 152
Brisbane, Queensland, 4001

KAWANA ESTATES PTY. LTD.
PARREARRA DEVELOPMENT
STRUCTURE 'Y'

DATE: 17-11-1999
DRAWING NO: 478/95-106
TYPICAL REVESTMENT AND BANK PROFILES

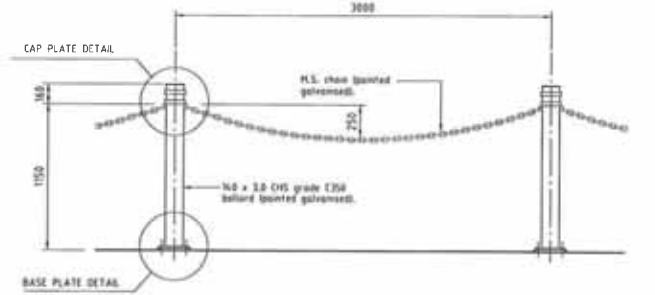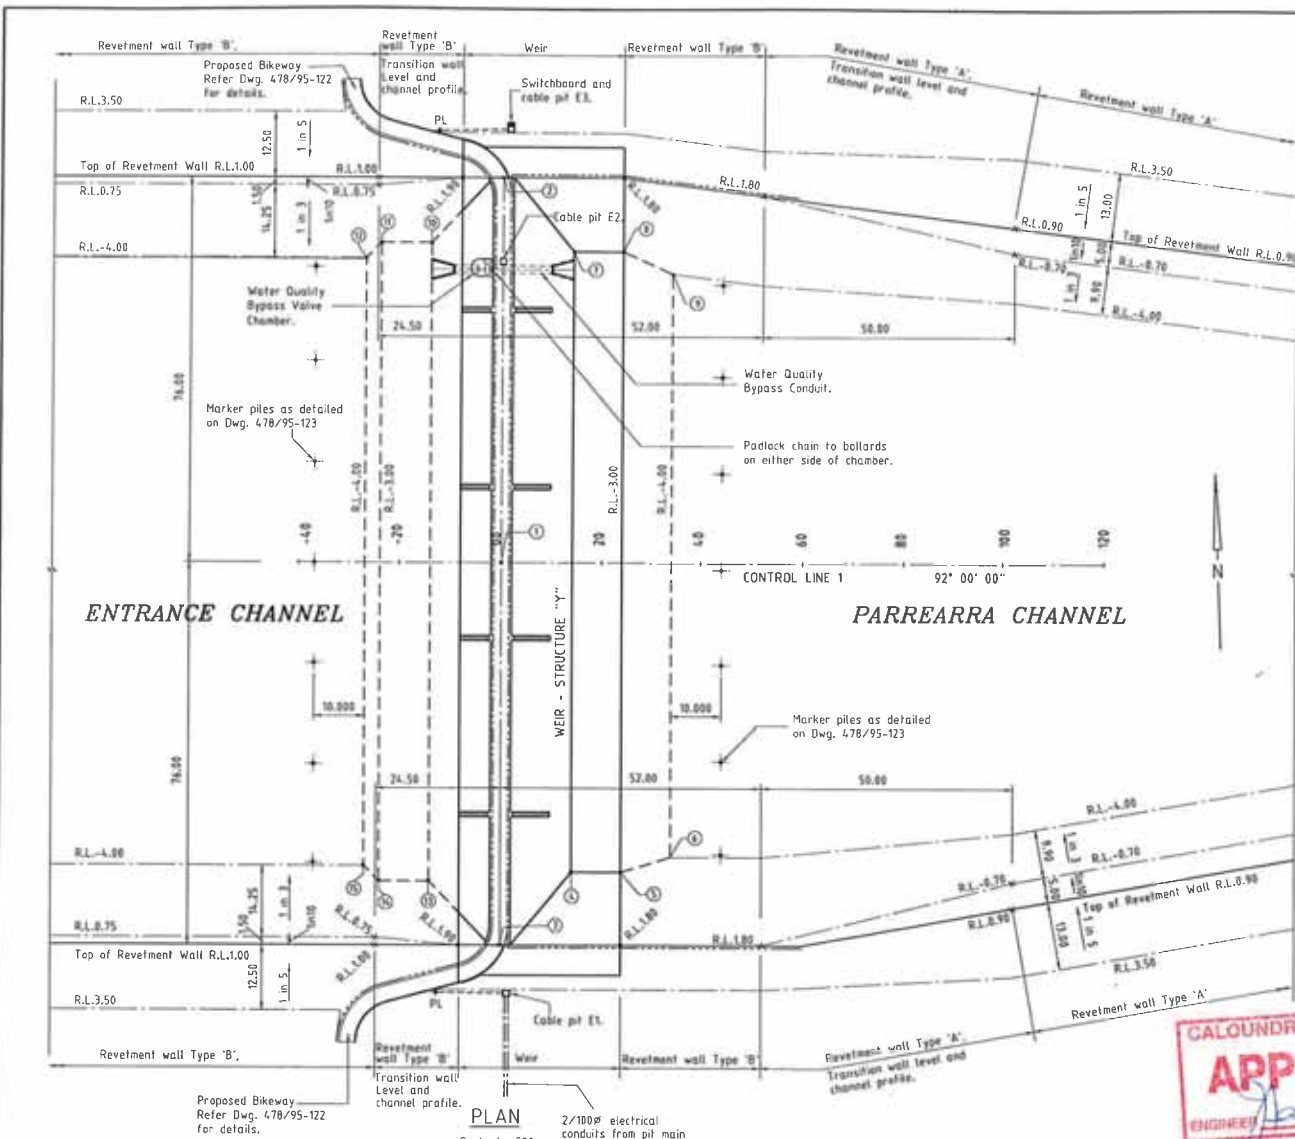


TYPICAL ELEVATION
120

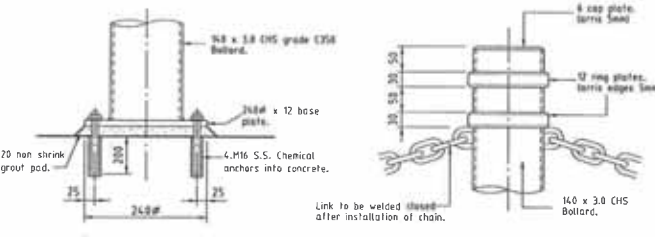

Base Plate Detail
15


Cap Plate Detail
15

BOLLARD AND CHAIN BARRIER

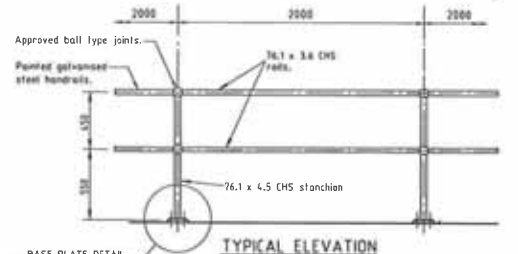

BASE PLATE DETAIL
120

TYPICAL ELEVATION
120

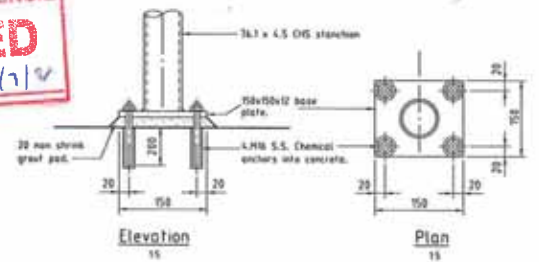

Elevation
15

Plan
15

BASE PLATE DETAIL

TUBULAR HANDRAIL




PLAN
Scale 1 : 500

WEIR SET-OUT DATA

Point No	E	N	RL	Point No	E	N	RL
1	190.529	370.560	1.790	9	226.576	426.461	+4.000
2	193.181	446.514	1.910	10	178.919	434.254	+3.000
3	187.876	294.686	1.910	11	168.925	434.603	+3.000
4	202.448	308.556	+3.000	12	165.823	431.710	+4.000
5	212.442	308.247	+3.000	13	174.505	307.831	+3.000
6	222.541	310.897	+4.000	14	164.511	308.180	+3.000
7	206.742	431.541	+3.000	15	161.617	311.283	+4.000
8	216.736	431.192	+3.000				

Conduits through weir between Cable pits E1, E2 and E3 are detailed on Dwg. 478/95-108.

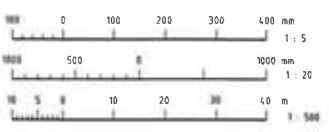


SCALES BEFORE REDUCTION

LEGEND:

- PL Pole Light
- Bollard and Chain Barrier
- Tubular Handrail
- 100mm UPVC conduit.
- 50mm UPVC conduit.

AUTOCAD R14 FILENAME: 478-107.DWG
DATE: 14-01-2008 TIME: 9:42 AM


DRAWING NO: 478/95-107 DATE: 17-05-98 PROJECT: Bollard barrier gates, Minor crossings.	DESIGNER: C.D. Davies CHECKED: C.D. Davies RECOMMENDED: R. J. Newman PROJ. MAN.	DATUM: A1 A.H.D.	Cardno & Davies Queensland Pty. Ltd. Consulting Engineers	SHEET NO: 17 of 17 SHEET TITLE: WEIR STRUCTURE 'Y' GENERAL ARRANGEMENT PLAN	CLIENT: KAWANA ESTATES PTY. LTD. PROJECT: PARREARRA DEVELOPMENT WEIR STRUCTURE 'Y' GENERAL ARRANGEMENT PLAN
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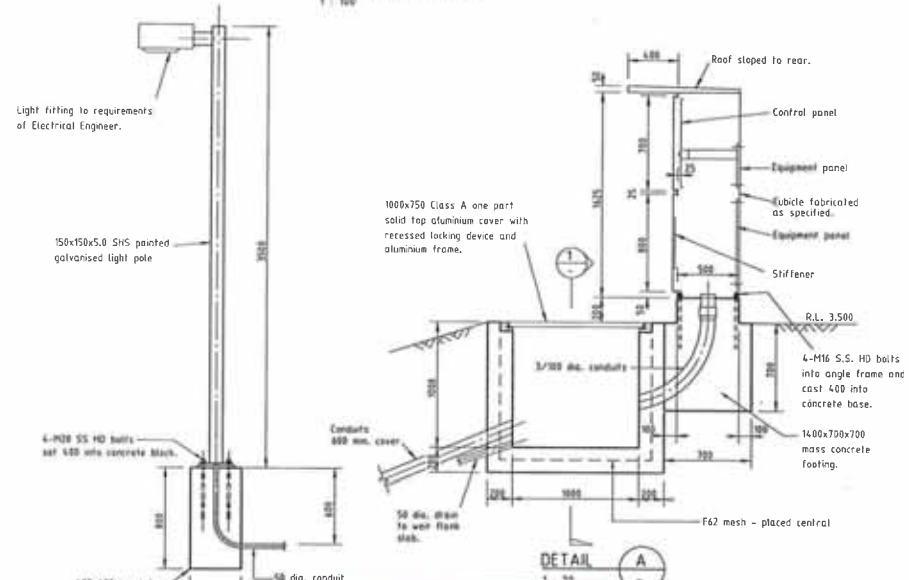
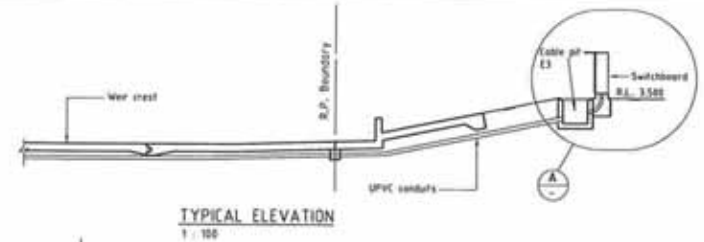
- LEGEND**
- 100 dia. UPVC Conduit
 - 80 dia. UPVC Conduit
 - 50 dia. UPVC Conduit
 - PL Pole Light
 - VA Valve Actuator
 - WLS Water Level Sensor

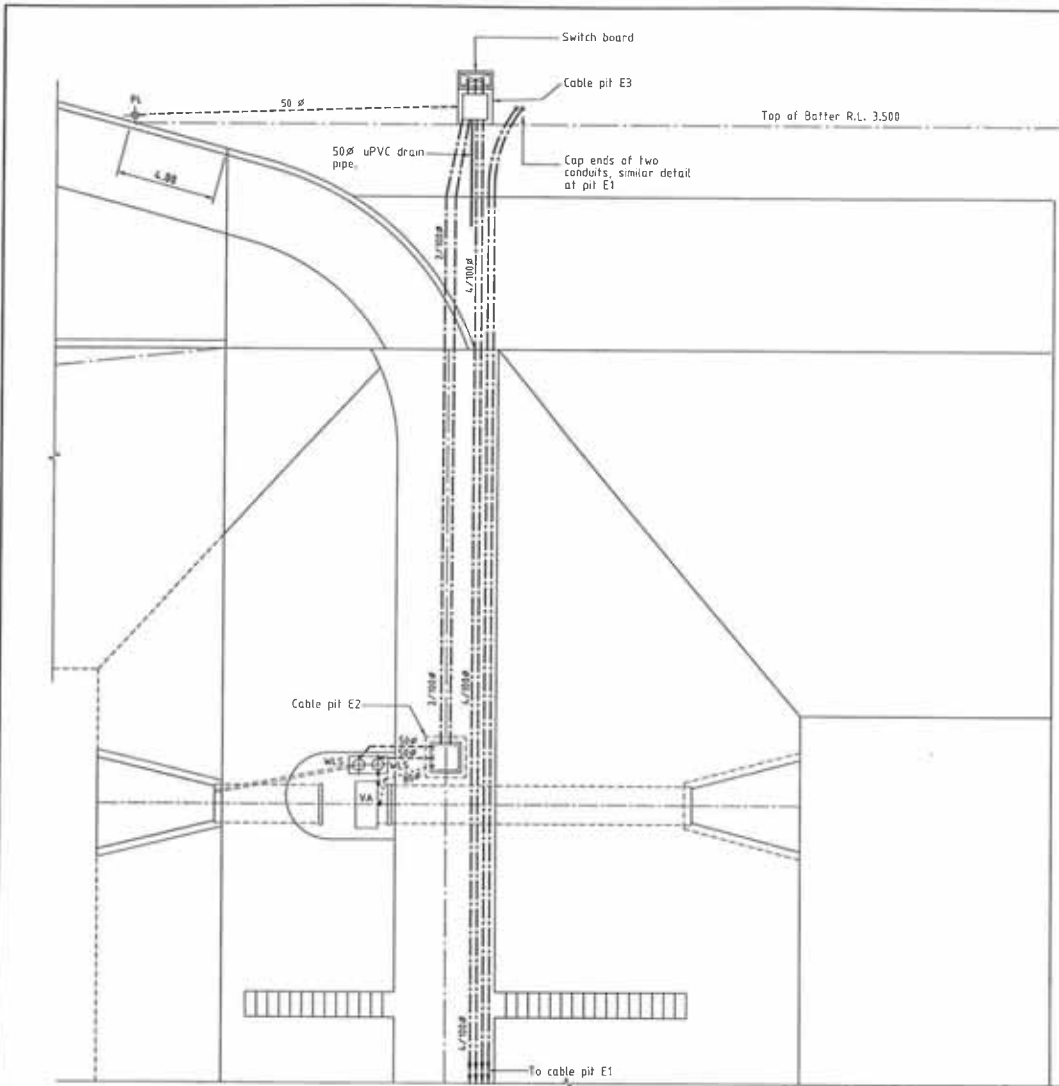PLAN
1:100



- NOTE:**
- Concrete to in-ground pits (except for weir cable pit E2) foundations and slabs shall be Class N25.
 - All conduits entering cable pit E2 and valve chamber to be sealed with 2 strips of S50220 Hydratite pipe seal or approved equivalent.




AUTOCAD R12 PLANNING - RPS-KAD.DWG
DATE: 1-12-1997 TIME: 5:33 PM

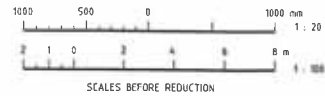

CALOUNDRA CITY COUNCIL
APPROVED
ENGINEER *flat* DATE 14/7/98

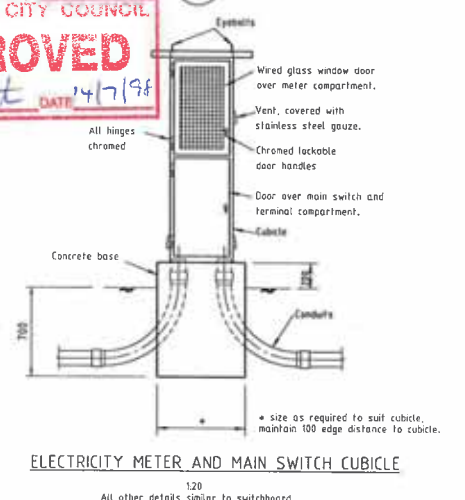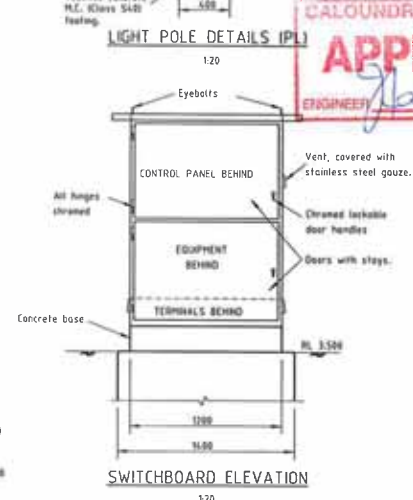

REVISIONS NO. DATE BY 1 12/12/97 C.D.		DRAWN A1 J.A.H.D.		C&D Cardno & Davies Queensland Pty. Ltd. CONSULTING ENGINEERS		OFFICES: Brisbane 071 234 4412 Gold Coast 071 234 4412 Ipswich 071 234 4412 Mackay 071 234 4412 Maryborough 071 234 4412 Rockhampton 071 234 4412 Townsville 071 234 4412 Cairns 071 234 4412 Port Moresby 071 234 4412 Honiara 071 234 4412		KAWANA ESTATES PTY. LTD. PARRIARRA DEVELOPMENT STRUCTURE 'Y' WEIR STRUCTURE CONDUIT PLAN AND DETAILS		DATE: 18-12-1997 DRAWING NO: 478/95-108	
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CALOUNDRA CITY COUNCIL
APPROVED
ENGINEER *flat* DATE 11/7/18

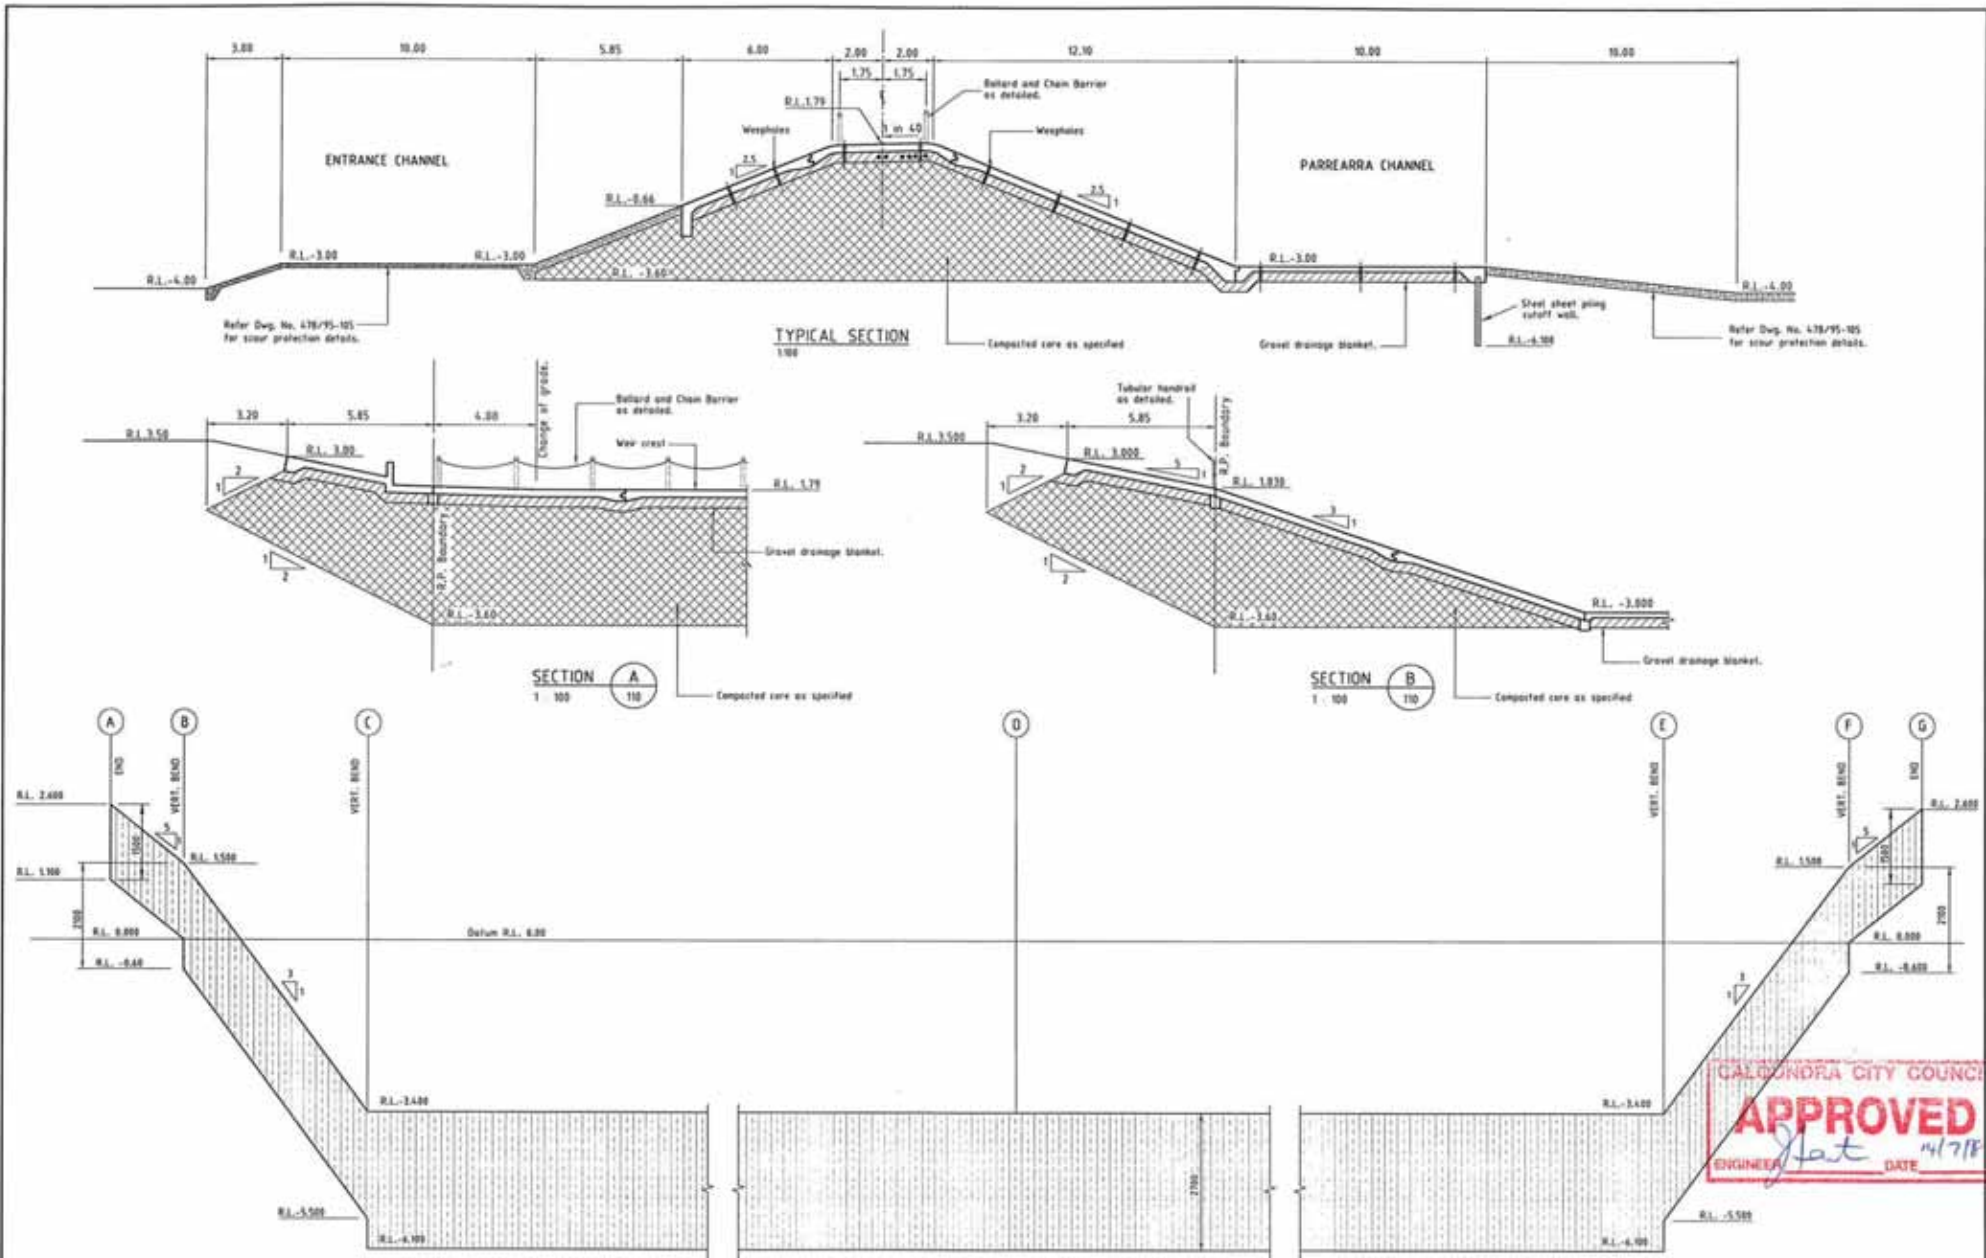ASTM A 572 GR 50
A572 - 98

NO.	REV.	DATE	BY	CHKD.
1				
2				
3				
4				
5				
6				
7				
8				
9				
10				

DESIGNED: *C.D. Davies*
DRAWN: *C.D. Davies*
CHECKED: *C.D. Davies*
APPROVED: *C.D. Davies*
DATE: 10/11/17


C&D **Cardno & Davies**
Queensland Pty. Ltd.
Consulting Engineers

PROJECT: *PARREARRA DEVELOPMENT*
DRAWING NO: *478/95-109*
DATE: *10/11/17*

KAWANA ESTATES PTY. LTD.
PARREARRA DEVELOPMENT
STRUCTURE 'Y'
WEIR STRUCTURE
STEEL SHEET PILING AND WEIR FILL PROFILES

SCALE: 10:1
DATE: 10/11/17
478/95-109

Refer Dwg. 478/95-122 for finished slab levels in this area.

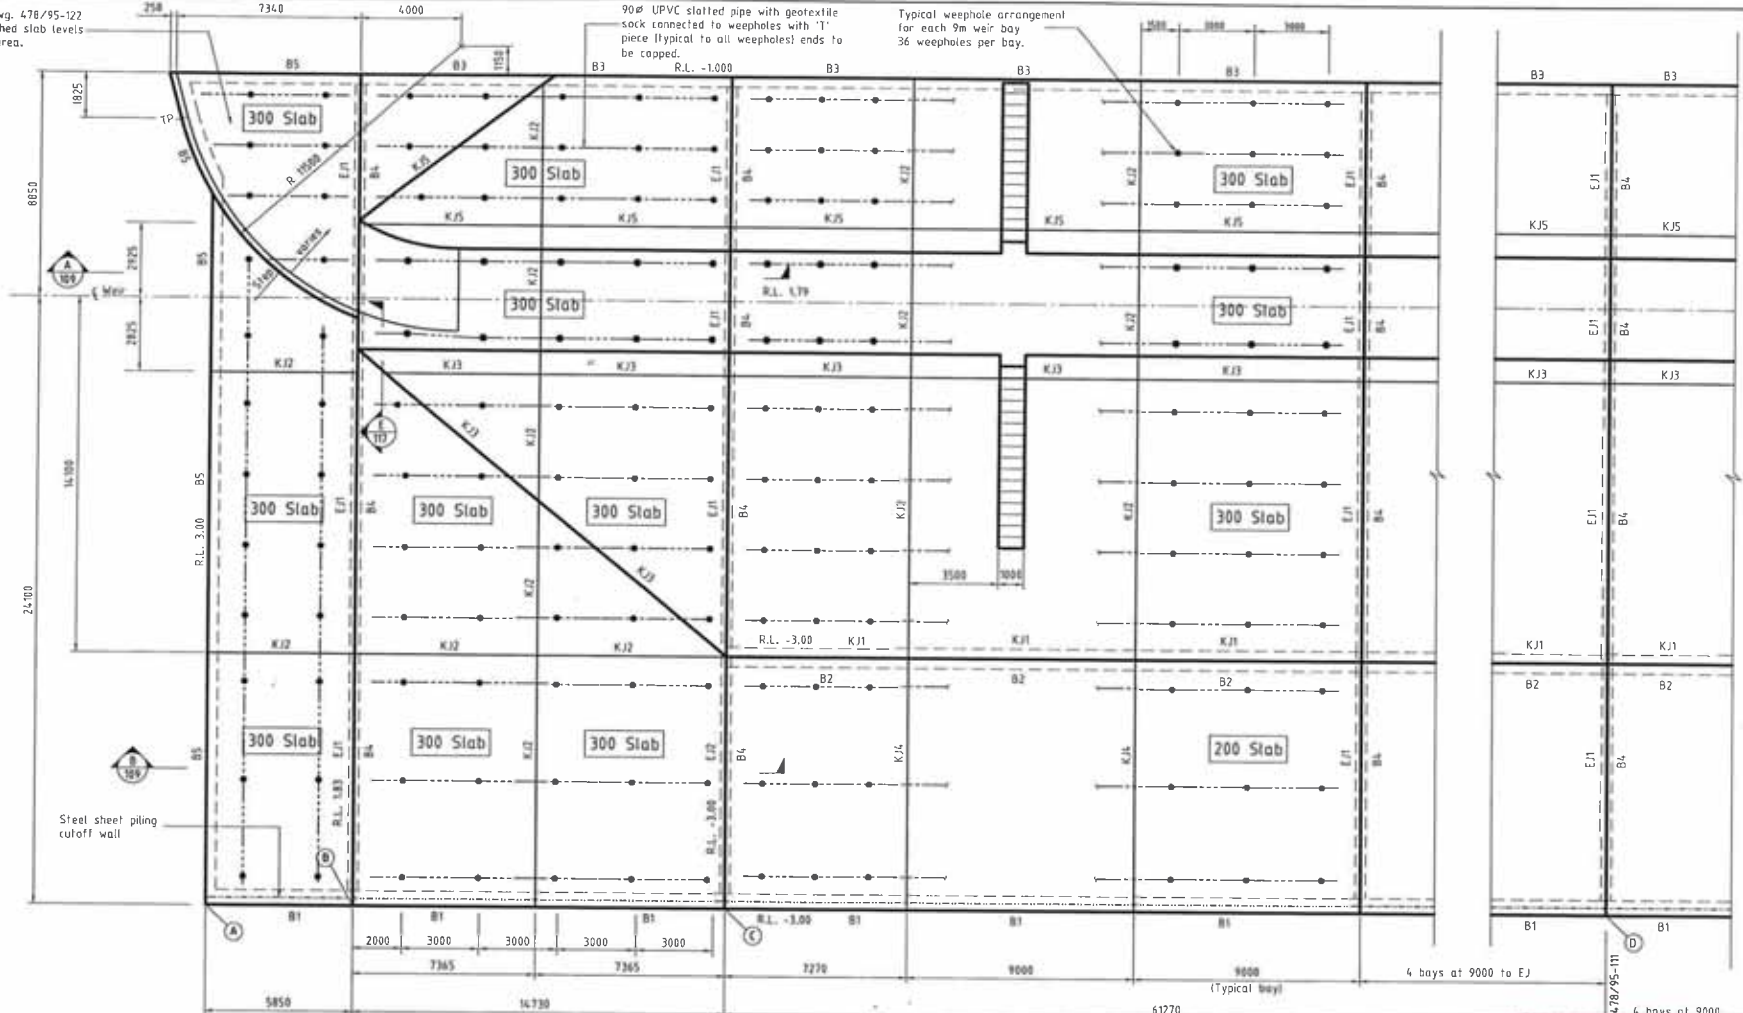

Typical weephole arrangement for each 9m weir bay. 36 weepholes per bay.

90mm UPVC slotted pipe with geotextile sock connected to weepholes with 1" piece (typical to all weepholes) ends to be capped.
R.L. -1.000

LEGEND

- KJ Contraction Joint
- EJ Expansion Joint
- BC 2 Coat Bitumen Paint before pouring second concrete
- B Beam
- Steel sheet piling cut off wall.
- 90mm UPVC Slotted pipe with geotextile sock.
- Weephole as detailed
- 10 JF 10 Joint Filler (fixed to one face with 30 long copper nails at 200 centres)
- 15S Sealant 15x15 with bond breaker and backing strip.


BEAM JOINT SCHEDULE

BEAM No.	Location					
	KJ1	KJ2	KJ3	KJ4	KJ5	EJ2
B1						
B2		BJ1		BJ1		BJ2
B3		BJ3				BJ4
B4	BJ5	BJ5	BJ5	BJ5		
B5		BJ1				



PART PLAN Note: Refer Dwg. 478/95-113, 114, 115, 116 & 117 for reinforcement details.

CALOUNDRA CITY COUNCIL
APPROVED
ENGINEER: [Signature]
DATE: 14/7/84

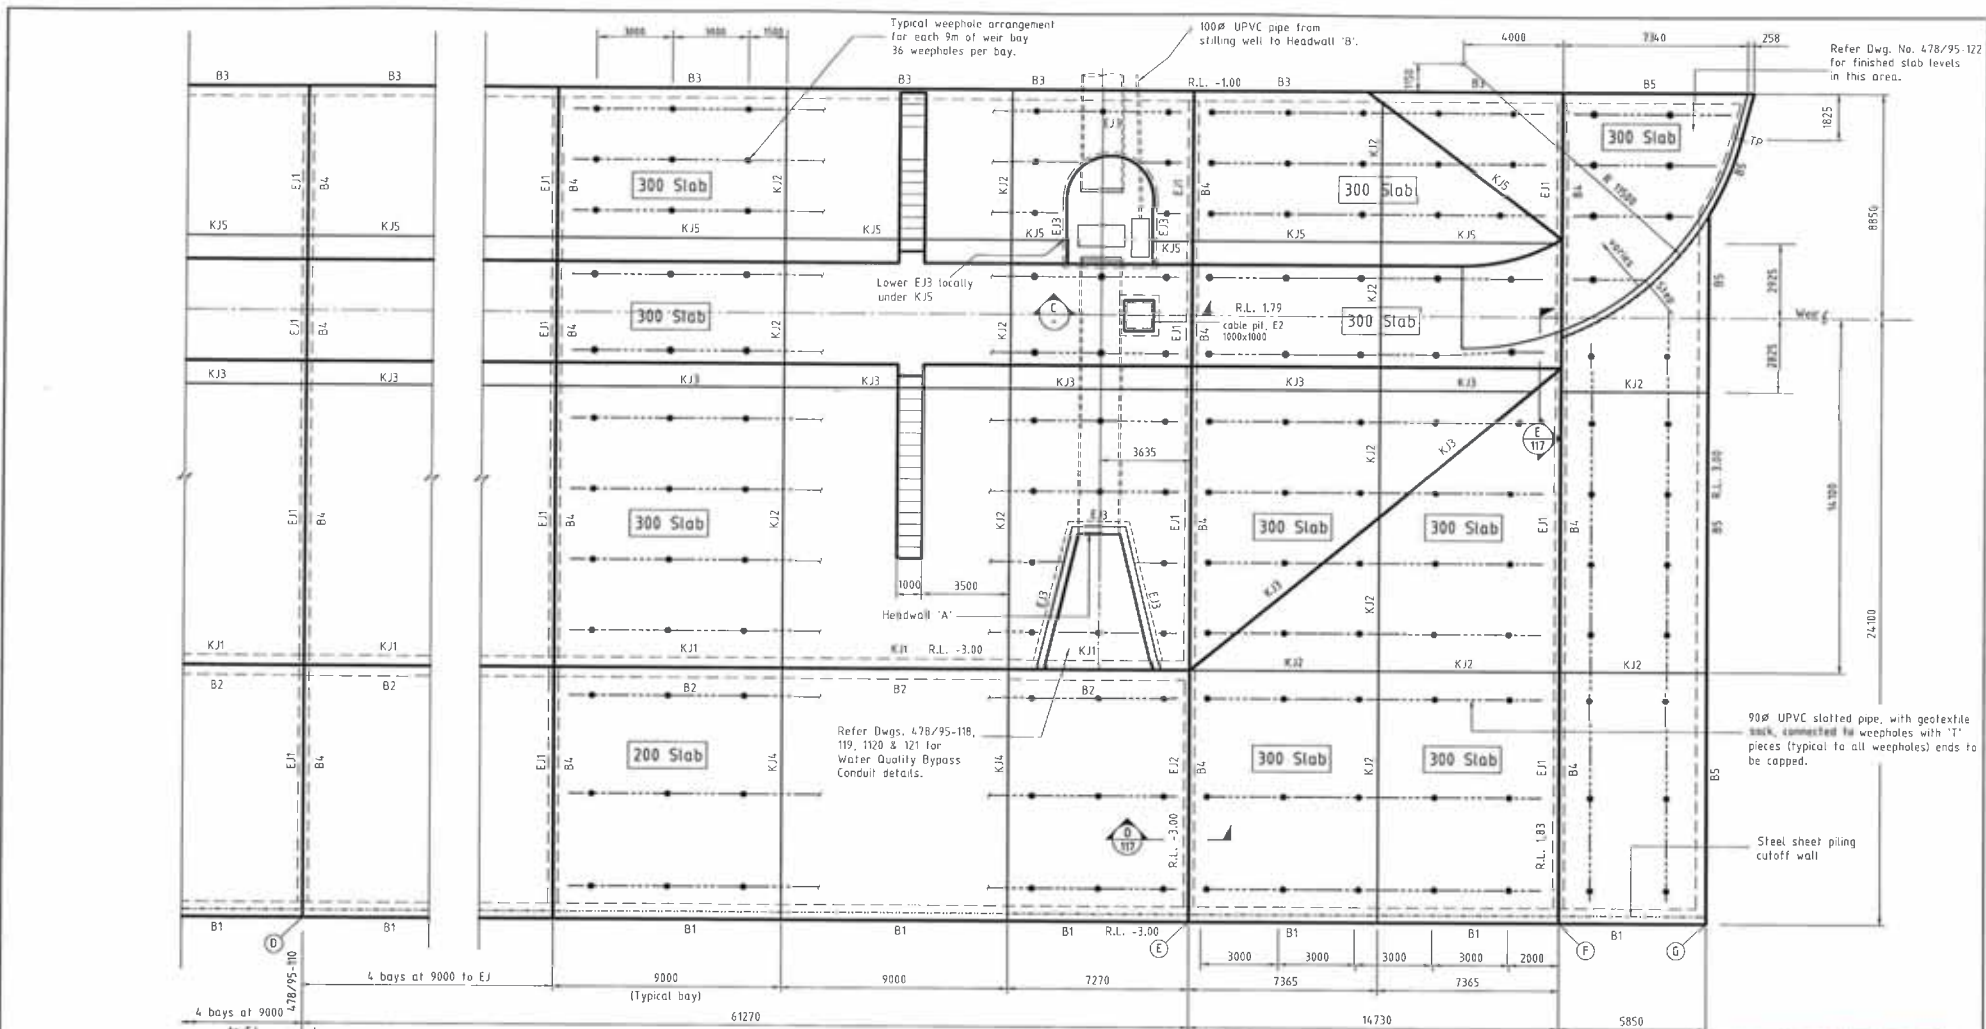

Refer Dwg. No. 478/95-122 for finished slab levels in this area.

Refer Dwg. 478/95-118, 119, 120 & 121 for Water Quality Bypass Conduit details.


90Ø UPVC slotted pipe, with geotextile sock, connected for weepholes with 'T' pieces (typical to all weepholes) ends to be capped.

Steel sheet piling cutoff wall


LEGEND :

- KJ Contraction Joint
- EJ Expansion Joint
- BC 2 Coat Bitumen Paint before pouring second concrete
- B Beam
- C Construction Joint
- Geotextile Type A
- Polyethylene Sheet
- Steel sheet piling cut off wall.
- 90Ø UPVC slotted pipe with geotextile sock.
- Gravel Drainage Blanket


- 10JF 10 Joint Filter (fixed to one face with 30 long copper nails at 200 centres)
- 15S Sealant 15x15 with bond breaker and backing strip.
- Weephole as detailed

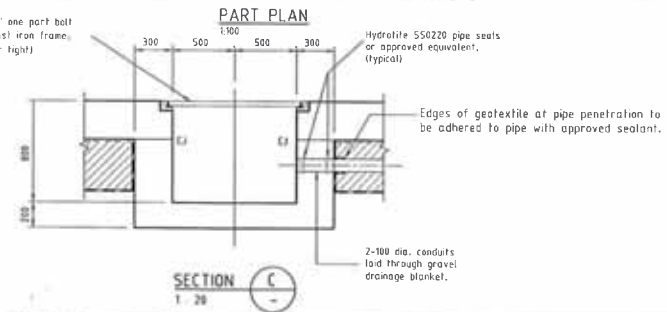



Note: Refer Dwg. 478/95-113, 114, 115, 116 & 117 for reinforcement details.

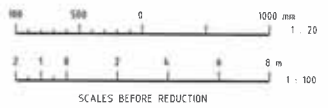

<p>DATE: 2/11/95 P.M. 1:31 AM</p> <p>AWACAD 4.0 PLTWARE 1.05.10.DWG</p>		<p>PROJECT: PARREARRA DEVELOPMENT</p> <p>STRUCTURE: WEIR STRUCTURE</p> <p>DRAWING NO.: 478/95-111</p>	<p>CLIENT: KAWANA ESTATES PTY. LTD.</p> <p>ENGINEER: CARDNO & DAVIES</p>
<p>DESIGNED BY: [Signature]</p> <p>CHECKED BY: [Signature]</p> <p>DATE: 2/11/95</p>	<p>DATE: 2/11/95</p> <p>A.H.D.</p>	<p>CARDNO & DAVIES</p> <p>Consulting Engineers</p>	<p>AWACAD 4.0 PLTWARE 1.05.10.DWG</p> <p>DATE: 2/11/95 P.M. 1:31 AM</p>

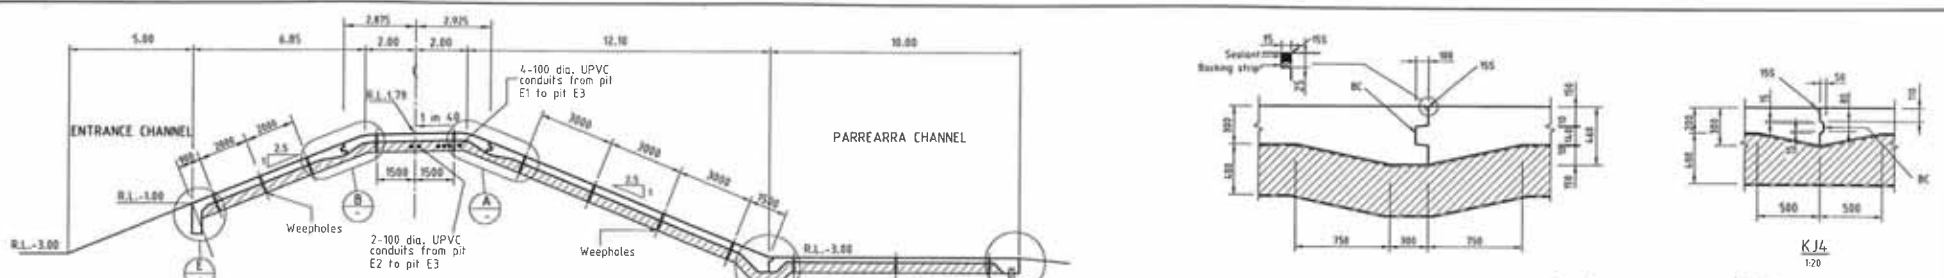


TYPICAL SECTION - CONCRETE PROFILE
1:100
(Note: Finish to weir shall be Broom Finish)

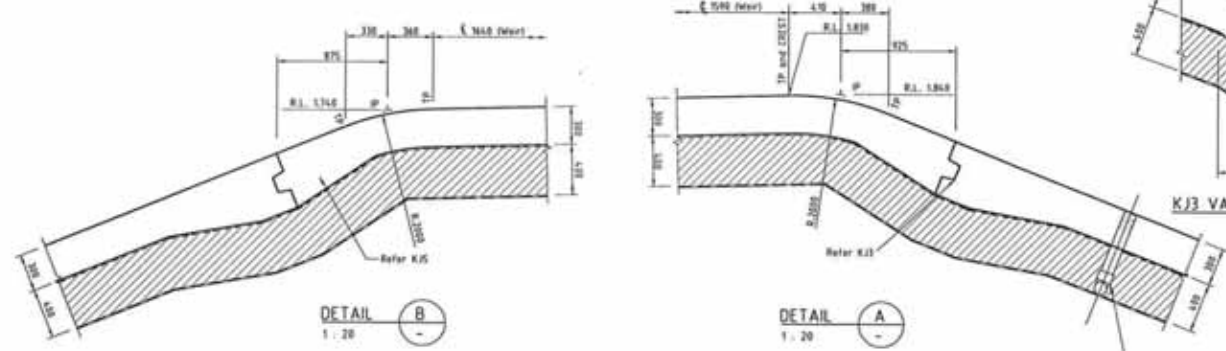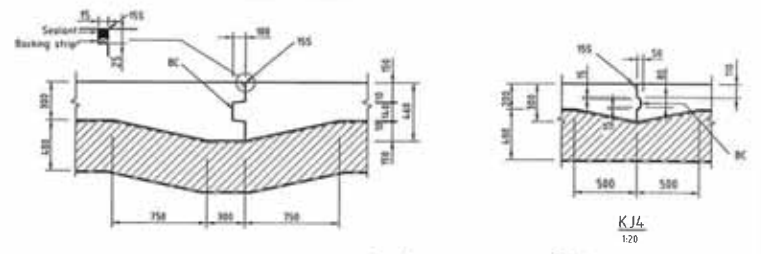

DETAIL B
1:20


DETAIL A
1:20

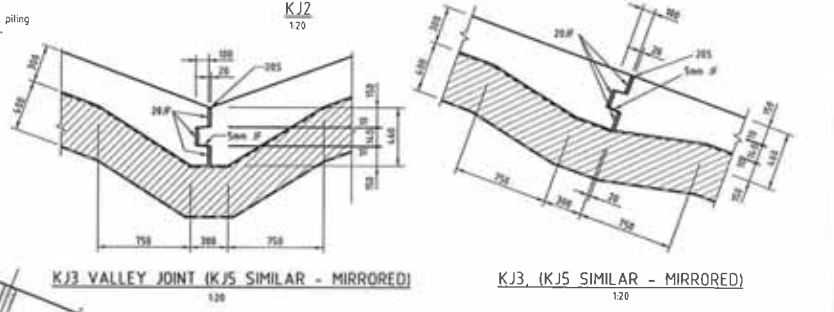

KJ3 VALLEY JOINT (KJ5 SIMILAR - MIRRORED)
1:20

KJ4 (KJ5 SIMILAR - MIRRORED)
1:20

CONTRACTION JOINTS (KJ)

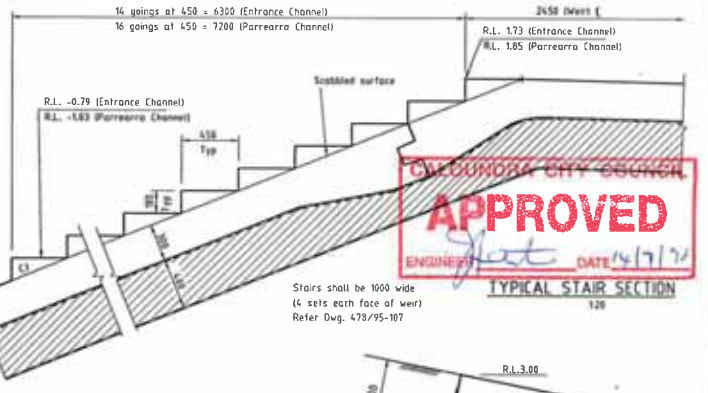

QUEENSLAND CITY COUNCIL
APPROVED
ENGINEER: [Signature] DATE: 14/7/20


Stairs shall be 1000 wide
(4 sets each face of weir)
Refer Dwg. 478/95-107

TYPICAL STAIR SECTION
1:20


- LEGEND:**
- ST Steel Trowelled Surface
 - BC 2 Coat Bitumen Paint before pouring second concrete
 - Geotextile Type A
 - Polyethylene Sheet
 - Gravel Drainage Blanket
 - 10JF 10 Joint Filter (fixed to one face with 30 long copper nails at 200 centres)
 - 15S Sealant 15x15 with bond breaker and backing strip.

- Mass concrete
- Reinforced concrete


- NOTES**
- Weepholes shall be 90 dia. slotted UPVC pipe with geotextile sock, 400 long in 200 thick slabs and 300 long in 300 thick slab, with 7" pieces connected to horizontal slotted pipe.
 - Weepholes to be filled with 150 long "no fines" concrete plug consisting of drainage blanket gravel in cementitious grout matrix. Weepholes above a level of R.L. -1.00 AHD to be topped with additional 50mm of 10mm "no fines" mix.
 - All chamfers shall be 20x20 unless shown otherwise.
 - All hot dip galvanised reinforcement shall be passivated

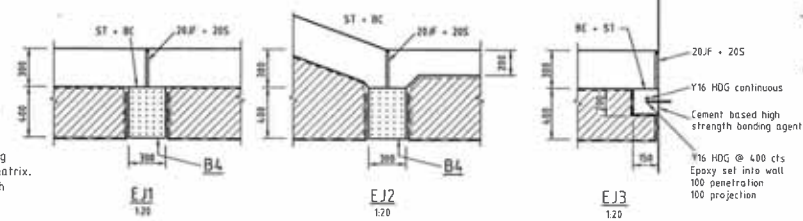

EXPANSION JOINTS (EJ)

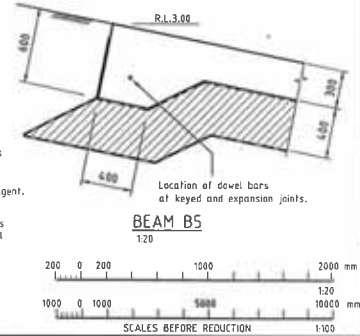


BEAM B5
1:20

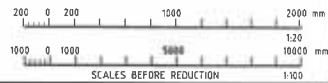

AUTOCAD R12 FREEMAN, K95-12.DWG
DATE: 2-12-1997 TIME: 1:50 PM

REVISIONS	REVISIONS A 18-03-98 Minor revisions.	DRAWN: C.G. Day CHECKED: [Signature] RECOMMENDED: [Signature] TITLE: [Blank]	DATUM: A.H.D.	Cardno & Davies Queensland Pty. Ltd. ADV. 931 811 917 CONSULTING ENGINEERS	PROJECT NO: 478/95-112 SHEET NO: 11 OF 12	KAWANA ESTATES PTY. LTD. PARREARRA DEVELOPMENT STRUCTURE 'Y' WEIR STRUCTURE JOINTING SECTIONS AND DETAILS	DATE: 16-11-1997 DRAWING NO: 478/95-112
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Reinforcement as per typical bay Reinforcement as per typical bay Reinforcement as per typical bay Typical bay reinforcement

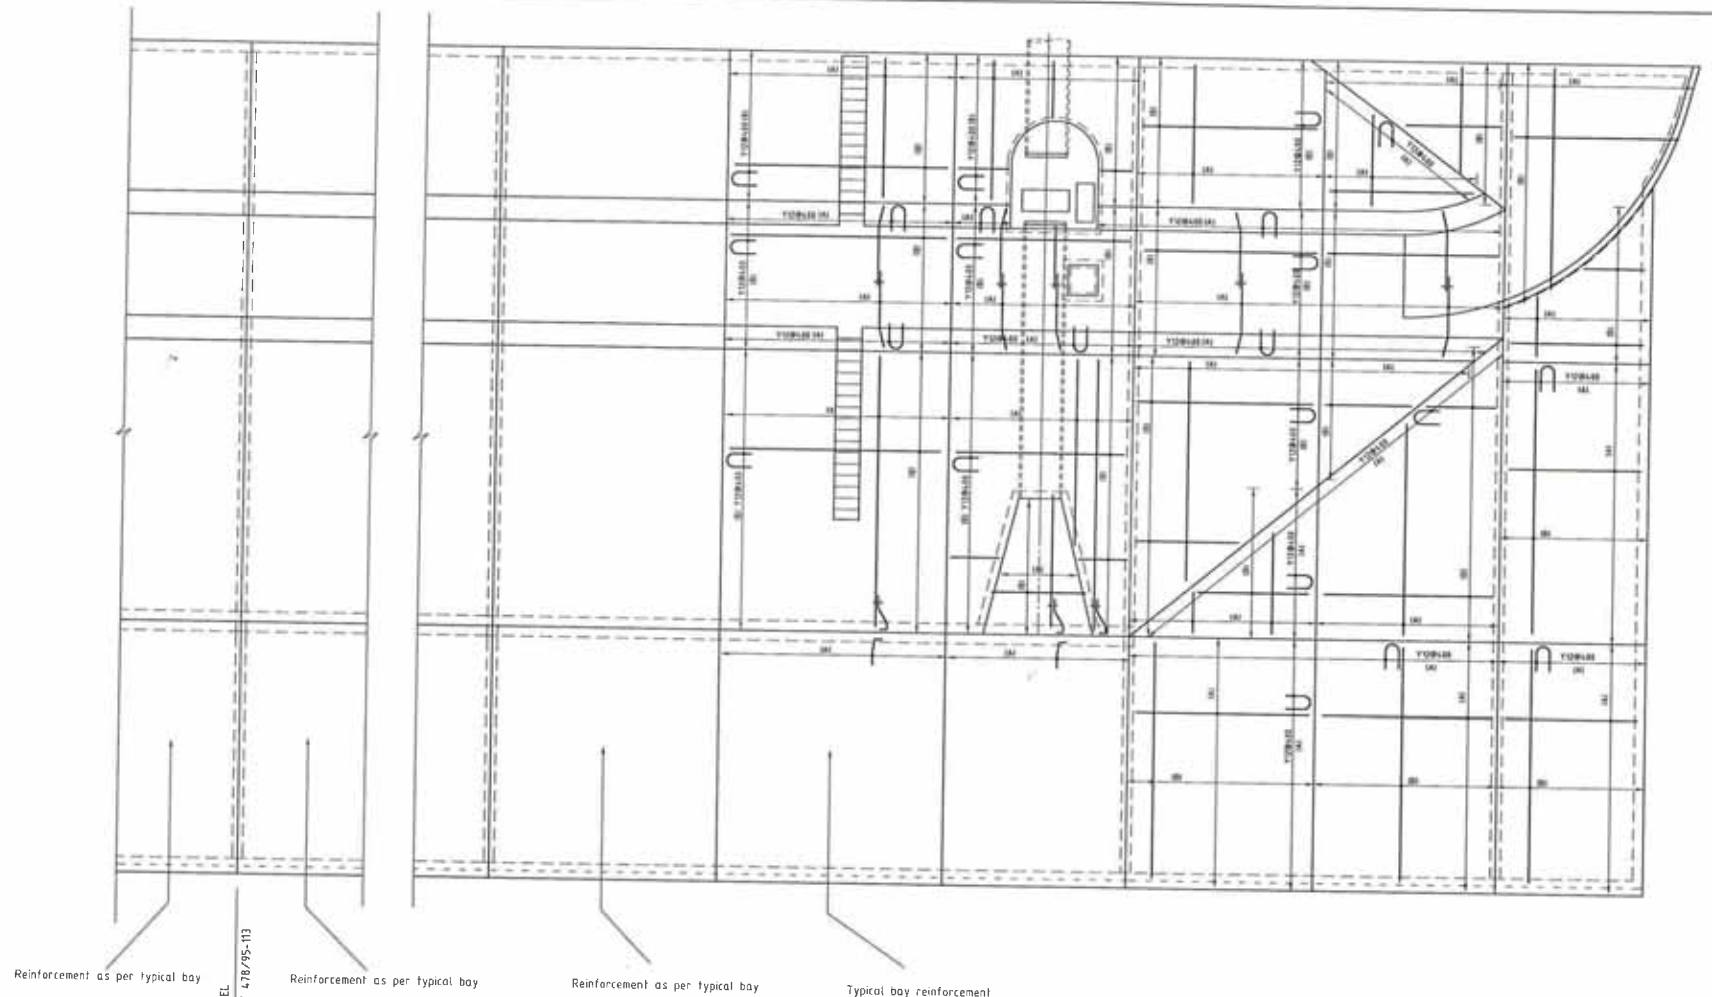1 OF CHANNEL
JOINS SHEET 478/95-113

PART PLAN
1:100

All reinforcement to be Y16@200 E.W. U.N.O.
Maintain 70 mm. cover to reinforcement.


Reinforcement into keys not shown for clarity.



SCALE BEFORE REDUCTION 1:100

AUTOCAD R12 PLOTNAME KPS-TN.DWG
DATE: 2-10-1993 TIME: 2:42 PM

REVISIONS NO. DATE BY DESCRIPTION		DESIGNED: <i>C.P. Hogg</i> DRAWN: <i>A.H.D.</i> CHECKED: <i>A.F. Hogg</i> APPROVED: <i>[Signature]</i>		A1 A.H.D.		Cardno & Davies Queensland Pty. Ltd. 424 95 874 972 CONSULTING ENGINEERS		1021 1022 1023 1611 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1812 1813 1814 1815 2211 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2412 2413 2414 2415 2611 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3012 3013 3014 3015 3329 3	
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Reinforcement as per typical bay

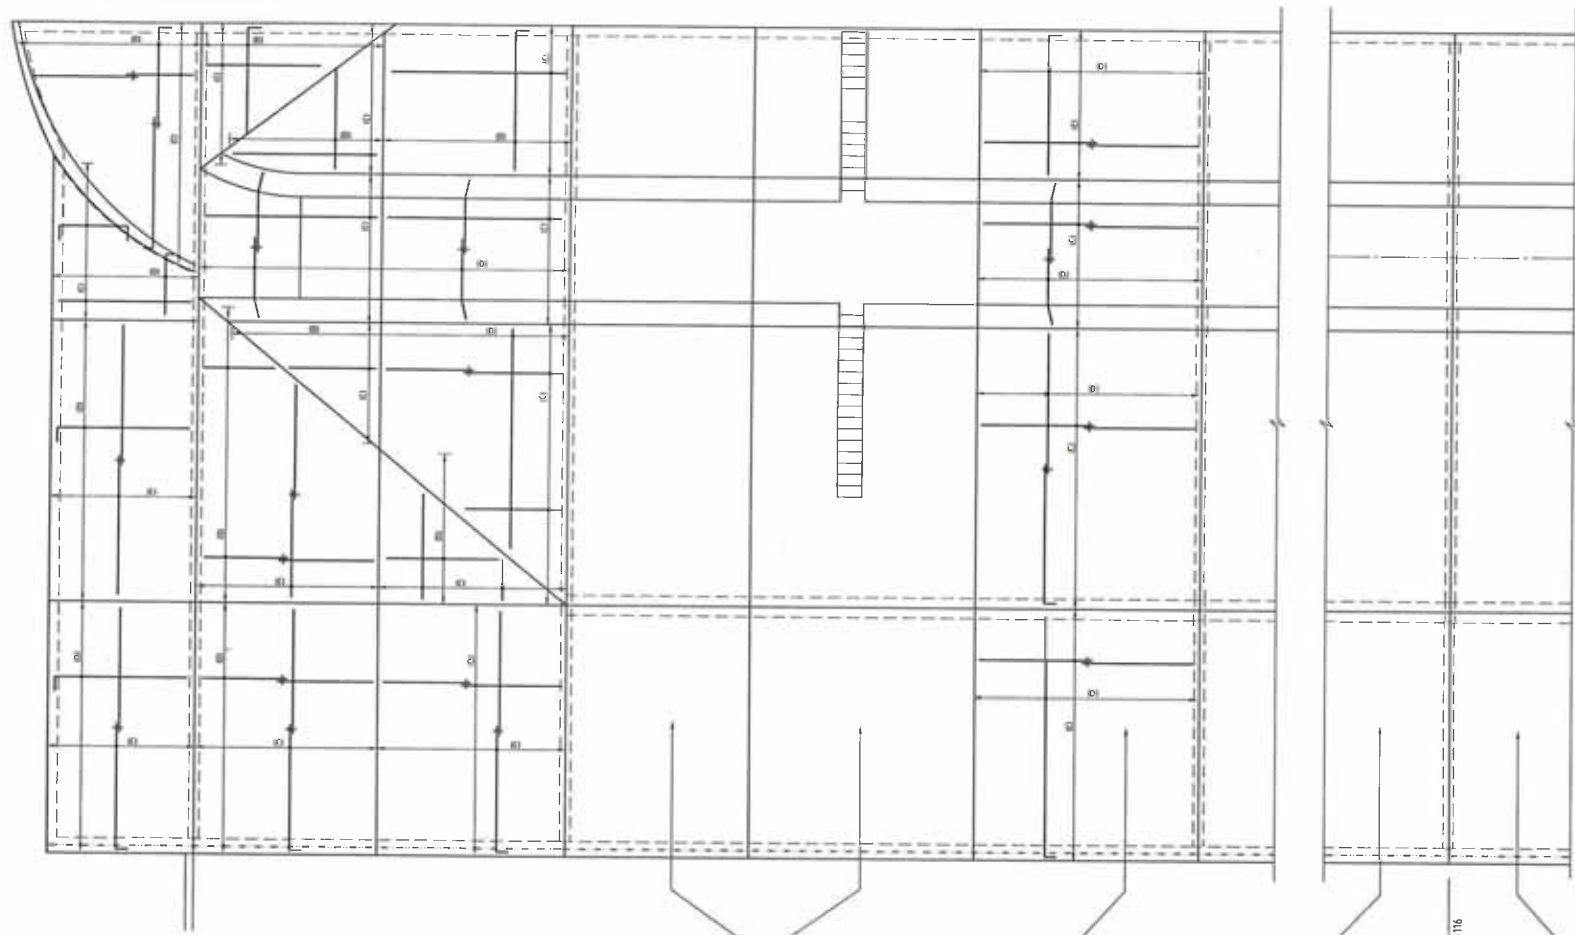Typical bay reinforcement

Reinforcement as per typical bay

Reinforcement as per typical bay


PART PLAN
1:100

E OF CHANNEL
JOINS SHEET 478/95-116








All reinforcement to be Y16@200 E.W. U.N.O.
Maintain 70 min. cover to reinforcement.

Reinforcement into keys not shown for clarity.

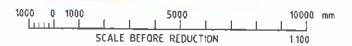


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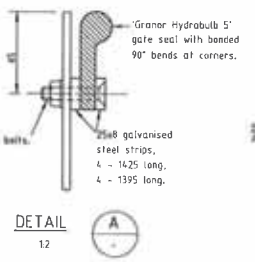
REVISIONS NO. DATE BY 1 14-03-98 [Signature]		DESIGNED: [Signature] CHECKED: [Signature] APPROVED: [Signature]		A1 A.H.D.		Cardno & Davies Queensland Pty. Ltd. CONSULTING ENGINEERS		KAWANA ESTATES PTY. LTD. PARRARRA DEVELOPMENT STRUCTURE 'Y' WEIR STRUCTURE TOP REINFORCEMENT - SHEET 1		SHEET: 18 OF 197 DRAWING NO: 478/95 - 115	
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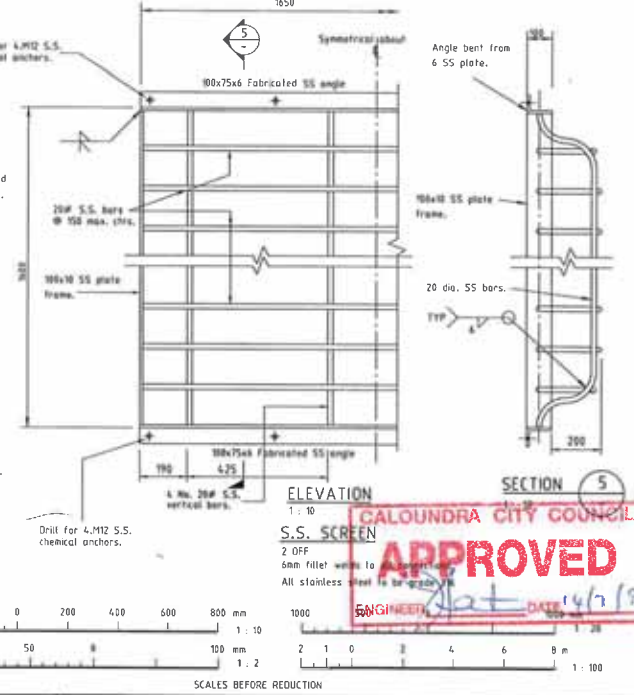
COVER TO BULKHEAD OPENING
E10
Cover to be 10mm marine grade aluminium chequer plate.

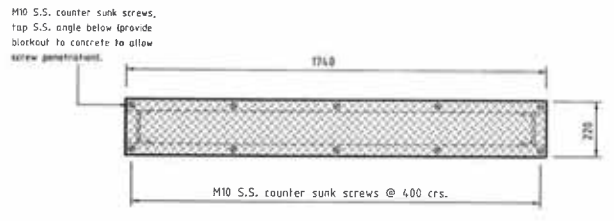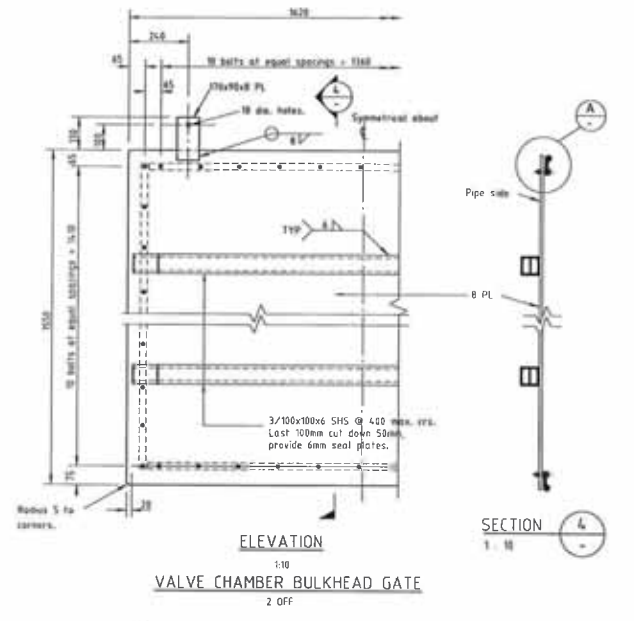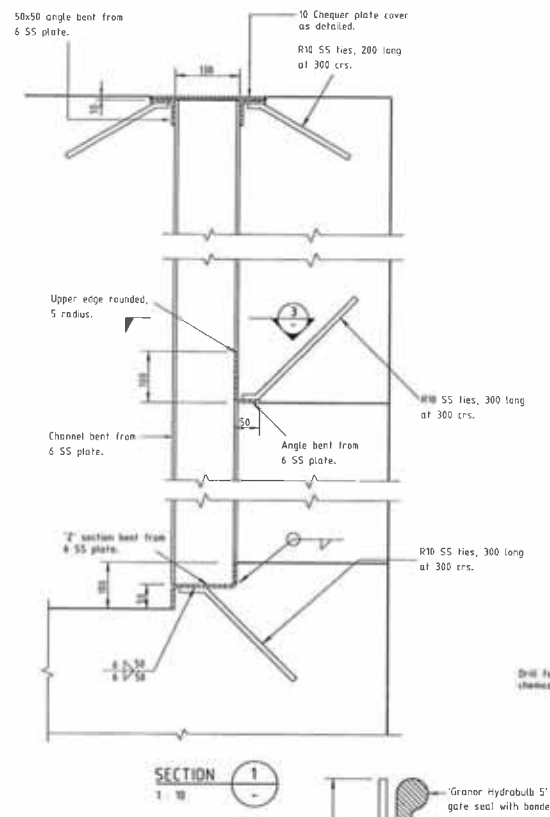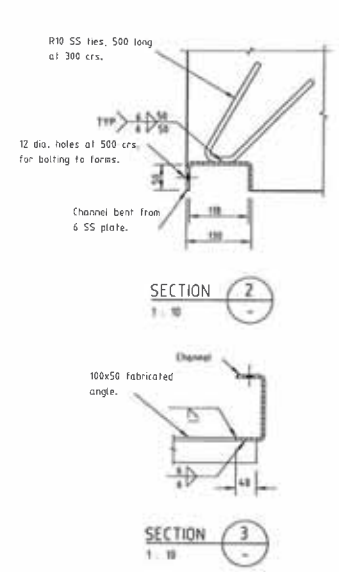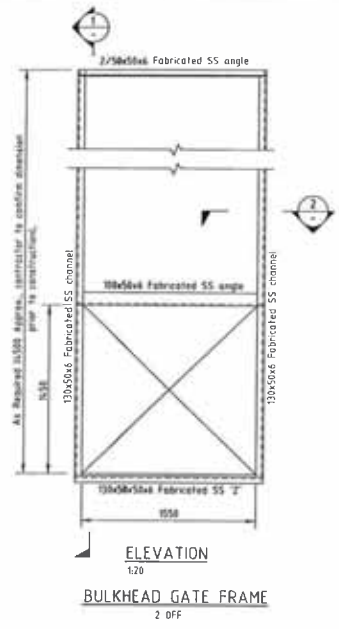


BYPASS CONDUIT TYPICAL SECTION
1:100

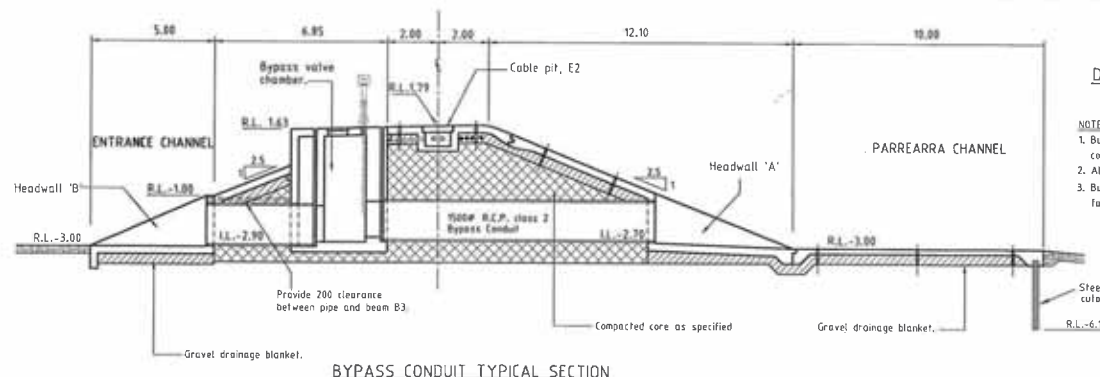

- NOTES:**
1. Bulkhead gate frame shall be constructed from Grade 316 stainless steel.
 2. All welds to be continuous fillet welds U.M.O.
 3. Bulkhead gate to be hot dip galvanized after fabrication (vent closed sections).




APPROVED
CALOUNDRA CITY COUNCIL
ENGINEER: [Signature]
DATE: 14/7/19

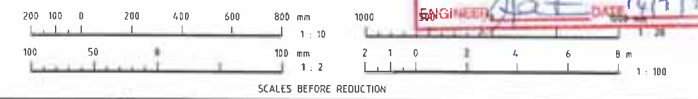


AUTOCAD R17 FRESHMAN K95-18.DWG
DATE: 12-10-1997 12W 3:55 PM

REVISIONS NO. DATE BY 1 11-03-99 [Signature] 2 14-07-19 [Signature]	DRAWN: [Signature] CHECKED: [Signature] A.H.D.	C&D Cardno & Davies Queensland Pty. Ltd. Consulting Engineers	PROJECT: PARREARRA DEVELOPMENT DRAWING NO: 478/95-118 DATE: 18.10.1997
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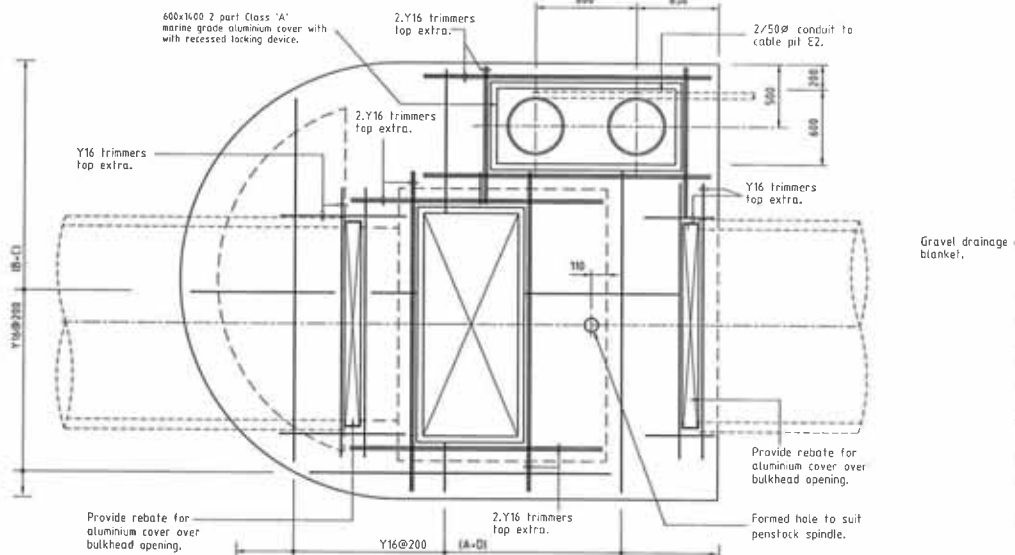


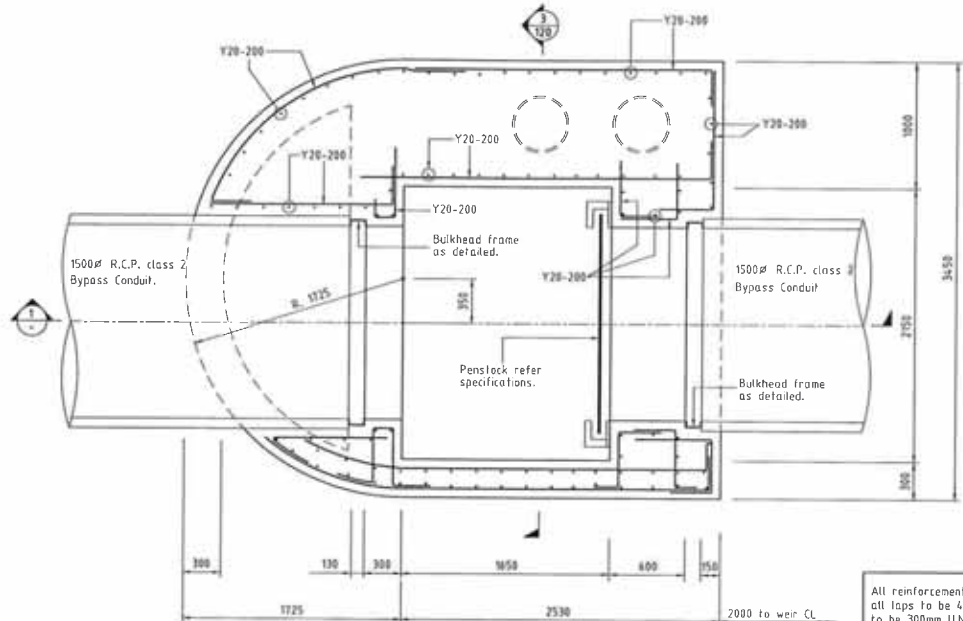BYPASS VALVE CHAMBER
120

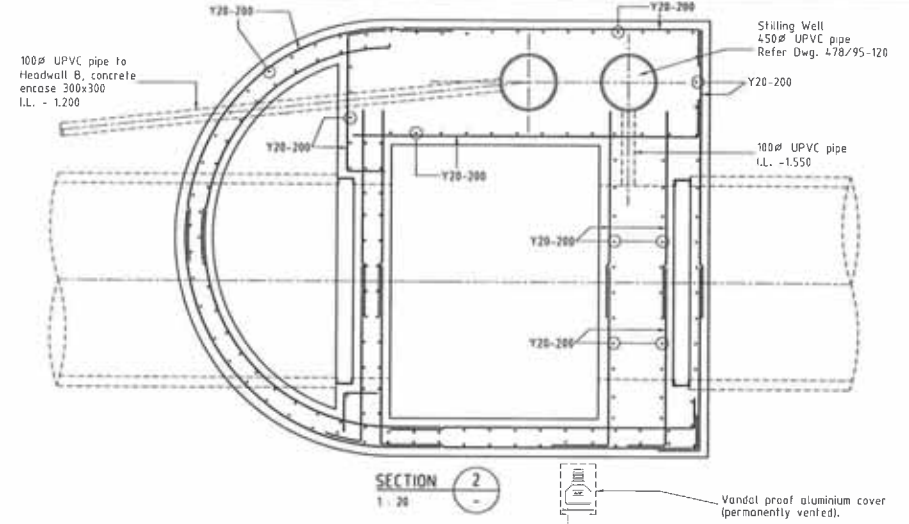

SECTION 2
1:20


All reinforcement to be Y16@200, all laps to be 400mm and caps to be 300mm U.N.O., 70mm min. cover to all reinforcement. Provide starter bars to match vertical reinforcement, lap 500.



BYPASS VALVE CHAMBER COVER SLAB (300 thick)
120

- (A) Bars laid first
- (B) Bars laid second
- (C) Bars laid third
- (D) Bars laid last

SCALE BEFORE REDUCTION
1:20

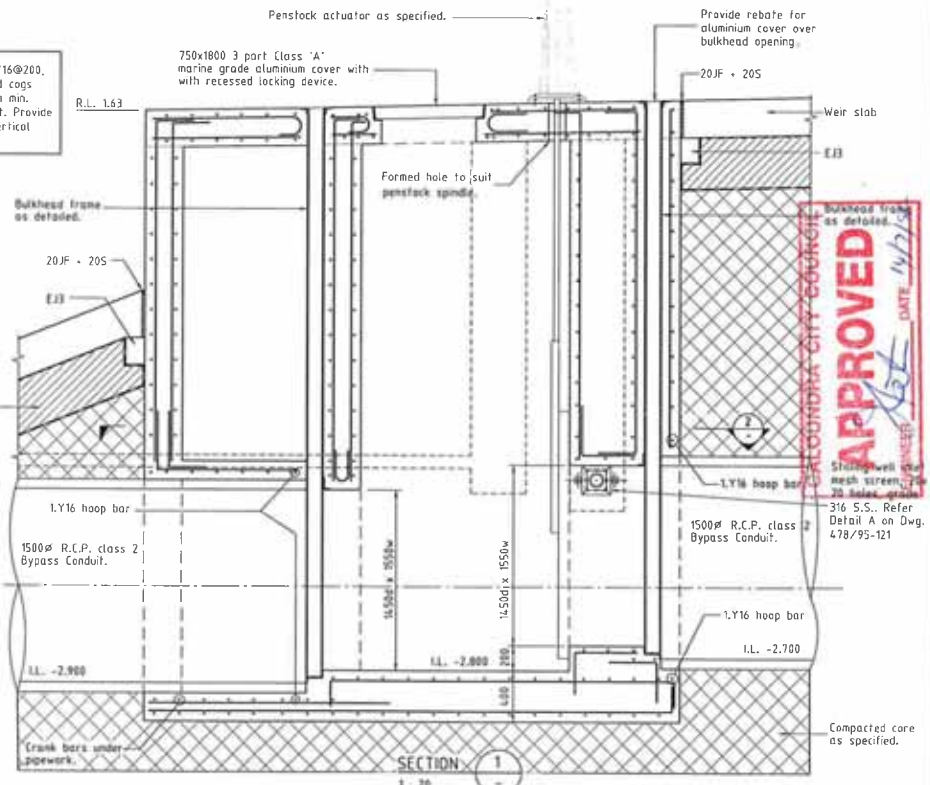

SECTION 1
1:20

APPROVED
 AUCKLAND CITY COUNCIL
 DATE 14/7/11
 316 S.S. Refer Detail A on Dwg. 478/95-121

AUTOCAD FILE: FNAME: 478-119.DWG
DATE: 3-0-1997 TIME: 8:28 AM


NO.	DATE	REVISION	BY	CHECKED

C&D Cardno & Davies
Queensland Pty. Ltd.
Consulting Engineers

PROJECT	DATE	NO.

KAWANA ESTATES PTY. LTD.
PARREARRA DEVELOPMENT
STRUCTURE "Y"
WATER QUALITY BYPASS CONDUIT
VALVE CHAMBER PLAN AND SECTIONS

DATE: 18-11-1997
DRAWING NO: **478/95-119**

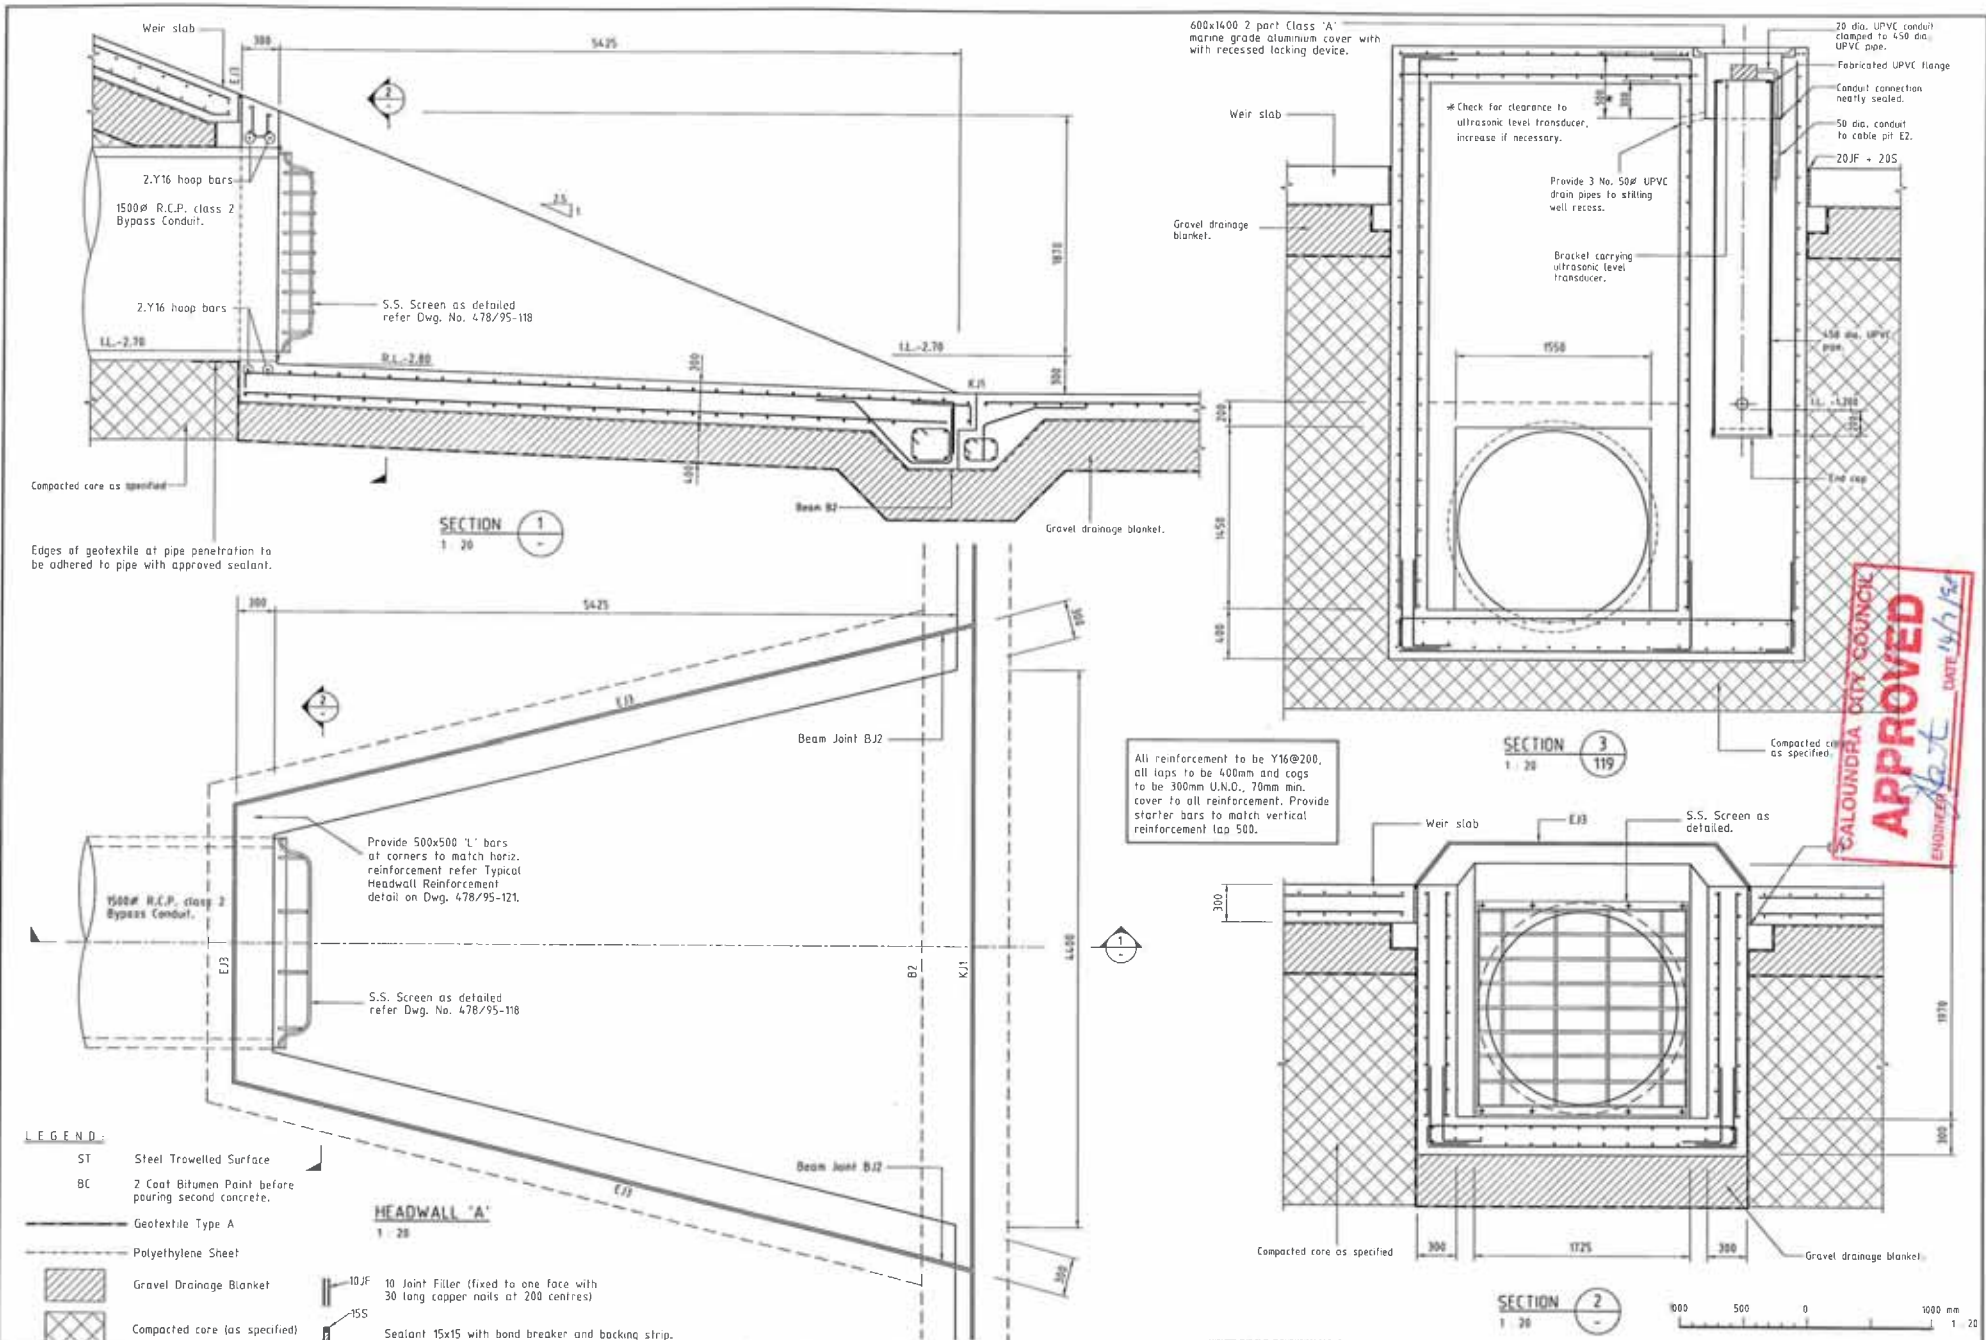

Edges of geotextile at pipe penetration to be adhered to pipe with approved sealant.

LEGEND:

- ST Steel Trowelled Surface
- BC 2 Coat Bitumen Paint before pouring second concrete.
- Geotextile Type A
- Polyethylene Sheet
- Gravel Drainage Blanket
- Compacted core (as specified)
- 10JF 10 Joint Filter (fixed to one face with 30 long copper nails at 200 centres)
- 15S Sealant 15x15 with bond breaker and backing strip.

All reinforcement to be Y16@200, all laps to be 400mm and cogs to be 300mm U.N.D., 70mm min. cover to all reinforcement. Provide starter bars to match vertical reinforcement lap 500.




REVISIONS 1. 11-03-94 New revision.		DRAWN: A.I. CHECKED: J.A.H.D. APPROVED: J.A.H.D.	PROJECT: PARREARRA DEVELOPMENT DRAWING NO: 478/95-120
PROJECT: PARREARRA DEVELOPMENT DRAWING NO: 478/95-120		CONTRACTOR: KAWANA ESTATES PTY. LTD. STRUCTURE: WATER QUALITY BYPASS CONDUIT HEADWALL 'A' AND SECTIONS	DATE: 3-12-1993 TIME: 11:38 AM SCALE: BEFORE REDUCTION

C&D Cardno & Davies
 Queensland Pty. Ltd.
 Consulting Engineers

KAWANA ESTATES PTY. LTD.
 PARREARRA DEVELOPMENT
 STRUCTURE: WATER QUALITY BYPASS CONDUIT HEADWALL 'A' AND SECTIONS

DATE: 11-03-94
 DRAWING NO: 478/95-120

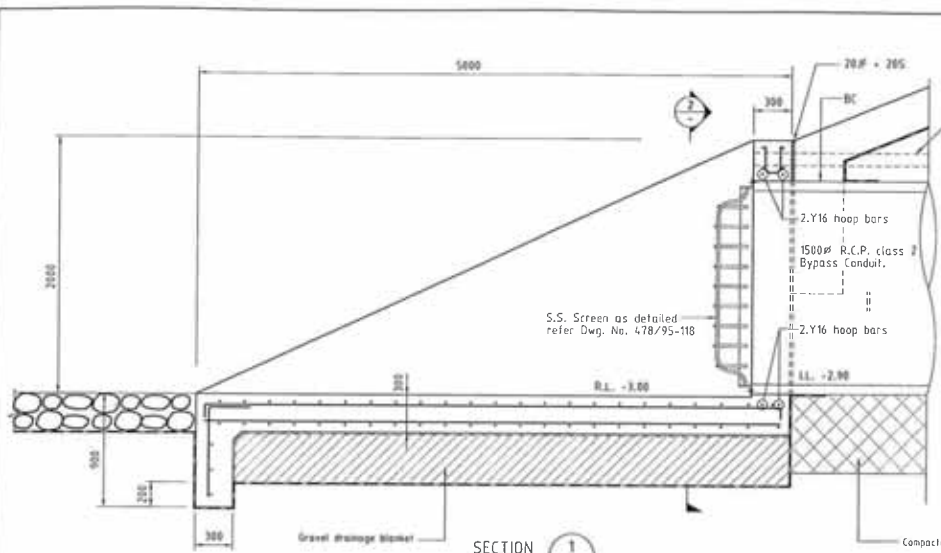

100 ϕ uPVC pipe to slating well (concrete encase, 300x300)

Stilling well inlet mesh screen, 20x20 holes, grade 316 S.S., Refer Detail A.

Refer Dwg. No. 478/95-105 for scour protection details.


S.S. Screen as detailed.

Lap geotextile as required.

Compacted core as specified


Gravel drainage blanket

SECTION 1
1:20

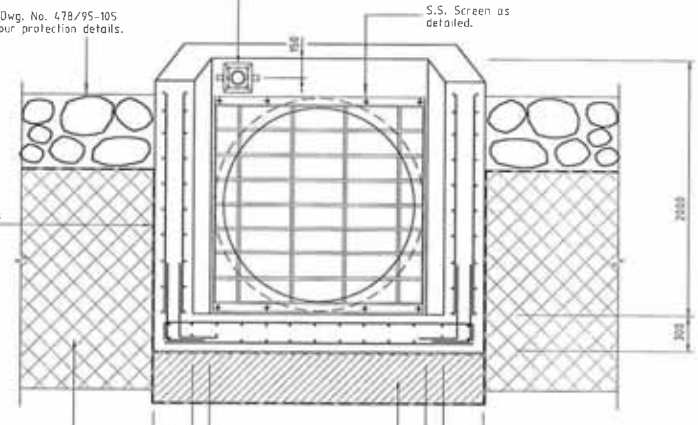

SECTION 2
1:20


All reinforcement to be Y16@200, all lags to be 400mm and cogs to be 300mm U.N.D., 70mm min. cover to all reinforcement. Provide starter bars to match vertical reinforcement lap 500.

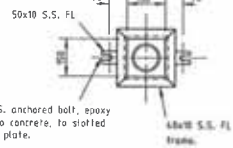

DETAIL A
1:10

100 ϕ uPVC pipe to Headwall 'B' only.


Y16 'U' bars @ 200 cfs.

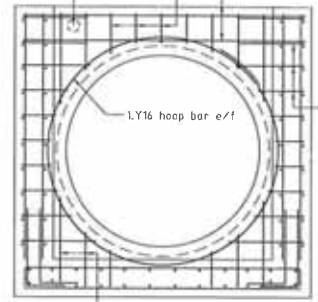

Y16 corner bars (500x500) @ 200 cfs. Cut bars back to accommodate RCP as required.

TYPICAL HEADWALL REINFORCEMENT
1:20

CALOUNDRA CITY COUNCIL
APPROVED
4/7/95

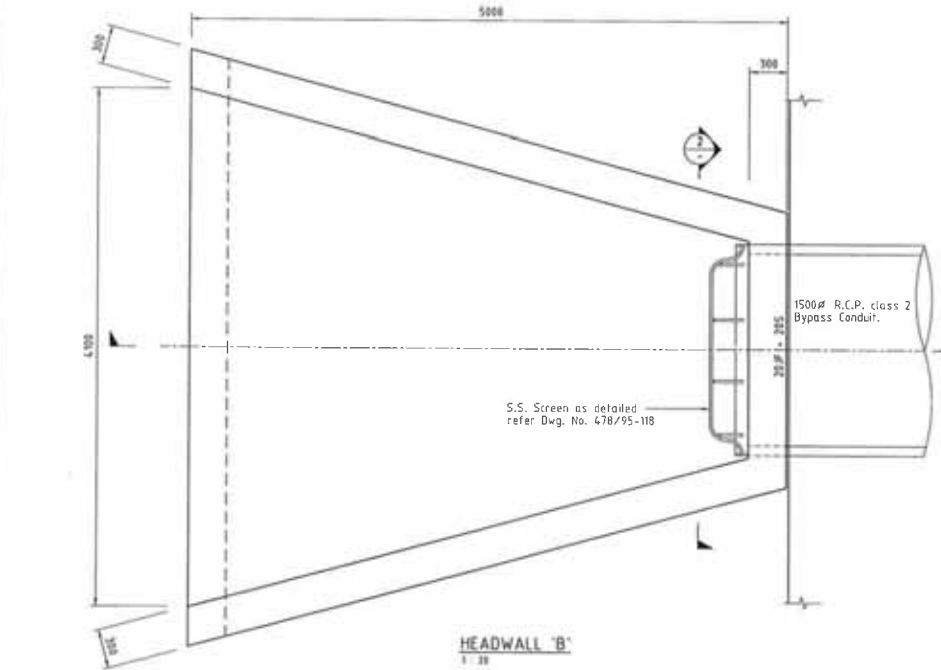

HEADWALL 'B'
1:20

LEGEND:

- ST Steel Trowelled Surface
- BC 2 Coat Bitumen Paint before pouring second concrete.
- Geotextile Type A
- Polyethylene Sheet
- Gravel Drainage Blanket
- Compacted core as specified


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DATE 16-12-94 TIME 7:53 AM

NO.	REV.	DESCRIPTION	DATE	BY	CHECKED	APPROVED	DATE

DESIGNED	<i>E.P. Wong</i>	DRAWN	<i>E.P. Wong</i>
CHECKED	<i>A.J. Smith</i>	APPROVED	<i>A.J. Smith</i>
DATE	16-12-94	SCALE	AS SHOWN

REVISIONS	NO.	DESCRIPTION

PROJECT	PARREARRA DEVELOPMENT
CLIENT	KAWANA ESTATES PTY. LTD.
DATE	16-12-94
DRAWING NO.	478/95-121

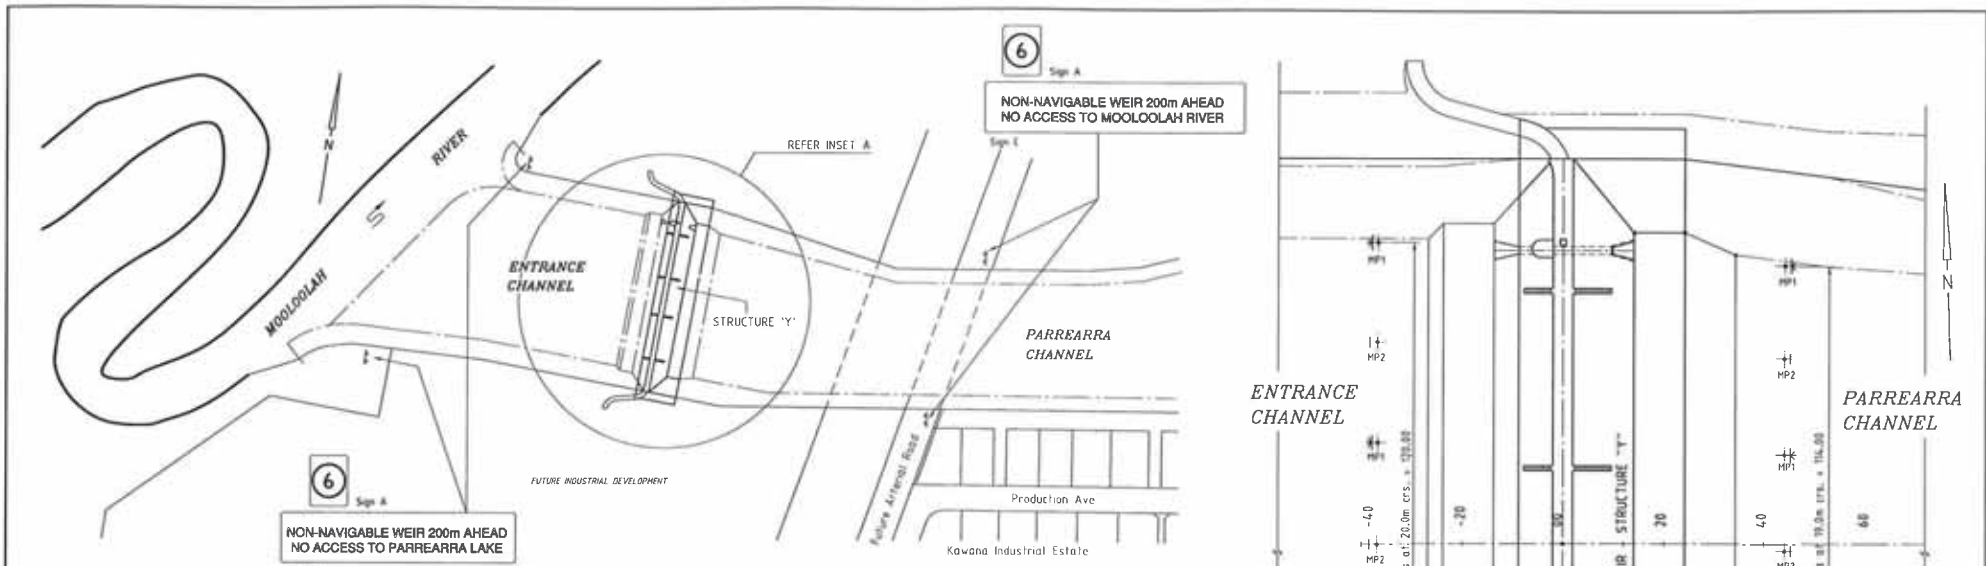


LOCALITY PLAN
Scale 1 : 2000


Top of pile to be cut off at specified level, coated with bitumen emulsion, fitted with galvanised steel capping ring, formed from 200 PL PL.



MARKER PILE DETAIL
Scale 1 : 50

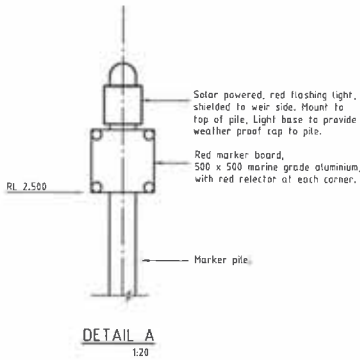

DETAIL A
Scale 1 : 20

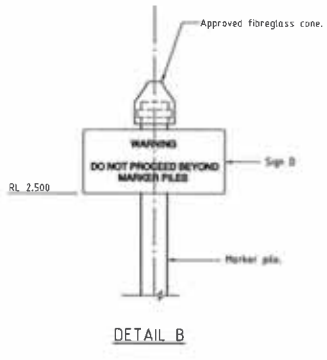


DETAIL B
Scale 1 : 20


SIGN SPECIFICATION

SIGN	LETTERING SIZE(mm) SERIES	COLOUR	SIZE (mm)	QUANTITY (No.)
A	50 EH	Black & red on white	450 x 600	4
B	50 EH	Black on yellow	1500 x 300 approx	2
C	50 EH	Black on yellow	1500 x 300 approx	2
D	75 EH	Black on yellow	1200 x 500 approx	6

- NOTES :
- 1) All signs are relettered.
 - 2) All signs shall meet the requirements of Queensland Transport - Marine Operations.
 - 3) Actual sign sizes to be confirmed by lettering requirements.
 - 4) Ground clearance to underside of signs shall be 2.0m minimum.
 - 5) All signs to be marine grade aluminium with stainless steel or marine grade aluminium fixings.
 - 6) Refer Std Dwg No 515/4-5 for post and footing details for signs A, B & C.

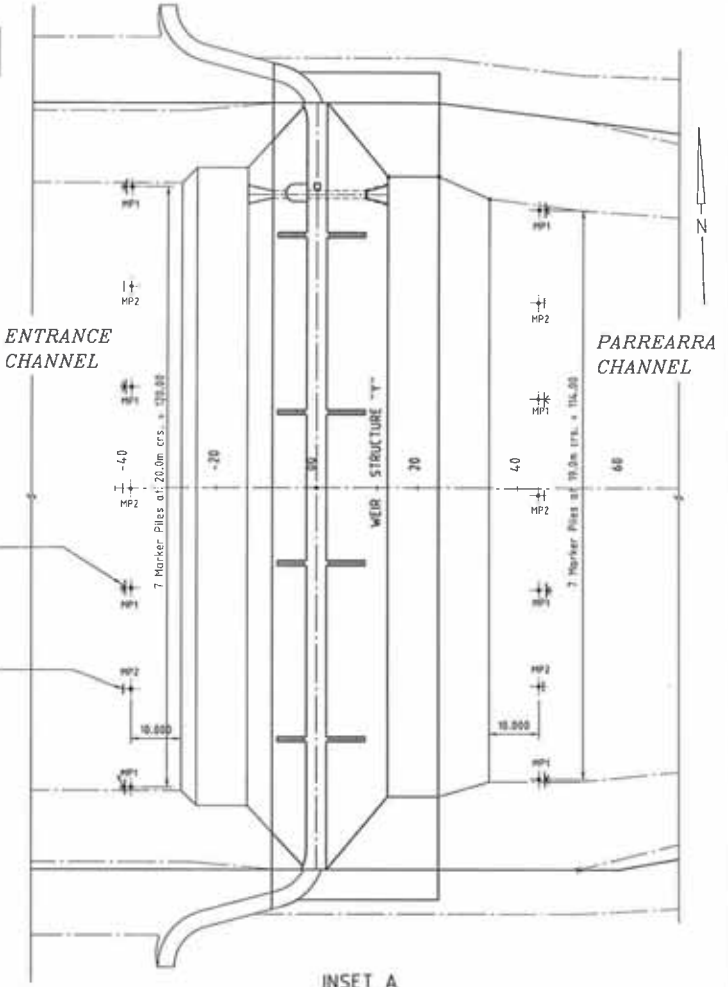

INSET A
Scale 1 : 500

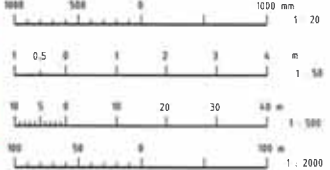


SCALES BEFORE REDUCTION

DESIGNED: <i>C.D.</i> DRAWN: <i>C.D.</i> CHECKED: <i>C.D.</i> RECOMMENDED: <i>C.D.</i> PROJ. MAN: <i>C.D.</i> REG. NO. <i>13-03-18</i>	DATUM: A1 A.H.D.	Cardno & Davies Queensland Pty. Ltd. Consulting Engineers	KAWANA ESTATES PTY. LTD. PARREARRA DEVELOPMENT STRUCTURE 'Y' NAVIGATION AIDS	DATE: 10-12-1997 478/95-123
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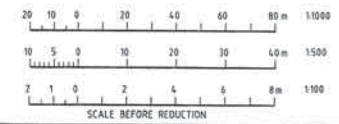
Appendix B: Structure Z Design Drawings

LIMIT OF STRUCTURE 'Z'		QUANTITIES									
D.A.T.U.M. R.L. -10.0											
EARTHWORKS QUANTITIES	FILL CUT	740	4827	5974	5499	4807	5353	6588	7285	4464	
CUT		1,621	1,707	2,805	1,178	1,869	1,706	2,561	2,863	2,620	
FILL											
EXCAVATION LEVELS		-1.000	-4.000	-4.000	-4.000	-3.000	-3.000	-4.000	-4.000	-4.000	
SURFACE LEVELS		-2.648	-2.574	-2.724	-1.794	-1.823	-1.735	-1.735	-1.866	-1.837	-1.381
CHAINAGE		00.00	06.00	16.00	26.00	30.00	36.00	46.00	60.00	75.00	

CONTROL LINE 1
LONGITUDINAL SECTION
 HOR. 1:1000
 VERT. 1:100

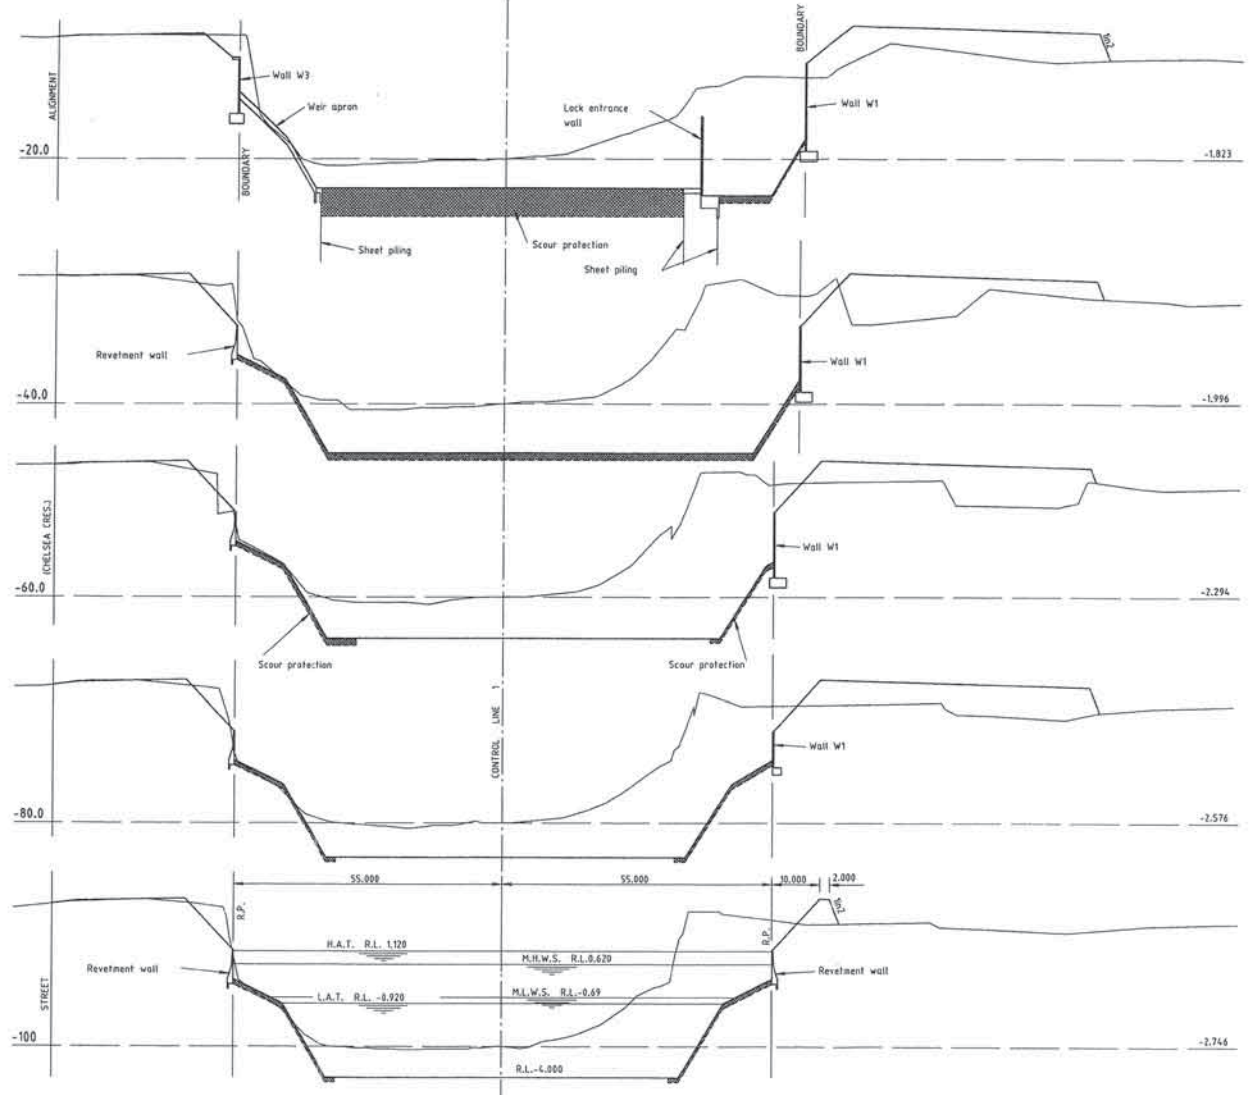

CROSS SECTIONS
 HOR. 1:500
 VERT. 1:100



AUTOCAD NAME: K95-4.DWG
 08/17/95 11:41:00 110.20

NO.	DATE	REVISIONS	REC.	APPR.	BY	DATE

DESIGNED: *[Signature]*
 DRAWN: *[Signature]*
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 RECOMMENDED: *[Signature]*
 PROJ. MGR: *[Signature]*


DATUM: A1
 A.H.D.
 APPROVED: *[Signature]*
 PROJ. ENG: *[Signature]*

C&D Cardno & Davies
 Queensland Pty. Ltd.
 68 Staveley Avenue, Moorookina
 Consulting Engineers

OFFICES:
 Brisbane 071 234 8888
 Gold Coast 071 234 8333
 Sunshine Coast 071 234 1555
 Hervey Bay 071 234 1655
 Maryborough 071 234 1555
 Port Macquarie 071 234 1555
 DISTRICT OFFICE:
 68 Staveley Avenue, Moorookina
 Postal Address: PO Box 155
 Moorookina, Queensland 4208


KAWANA ESTATES PTY. LTD.
 PARREARRA DEVELOPMENT
 STRUCTURE Z
 CONTROL LINE 1
 LONGITUDINAL AND CROSS SECTIONS

DATE: 11-12-1996
 DRAWING NO: 478/95-4

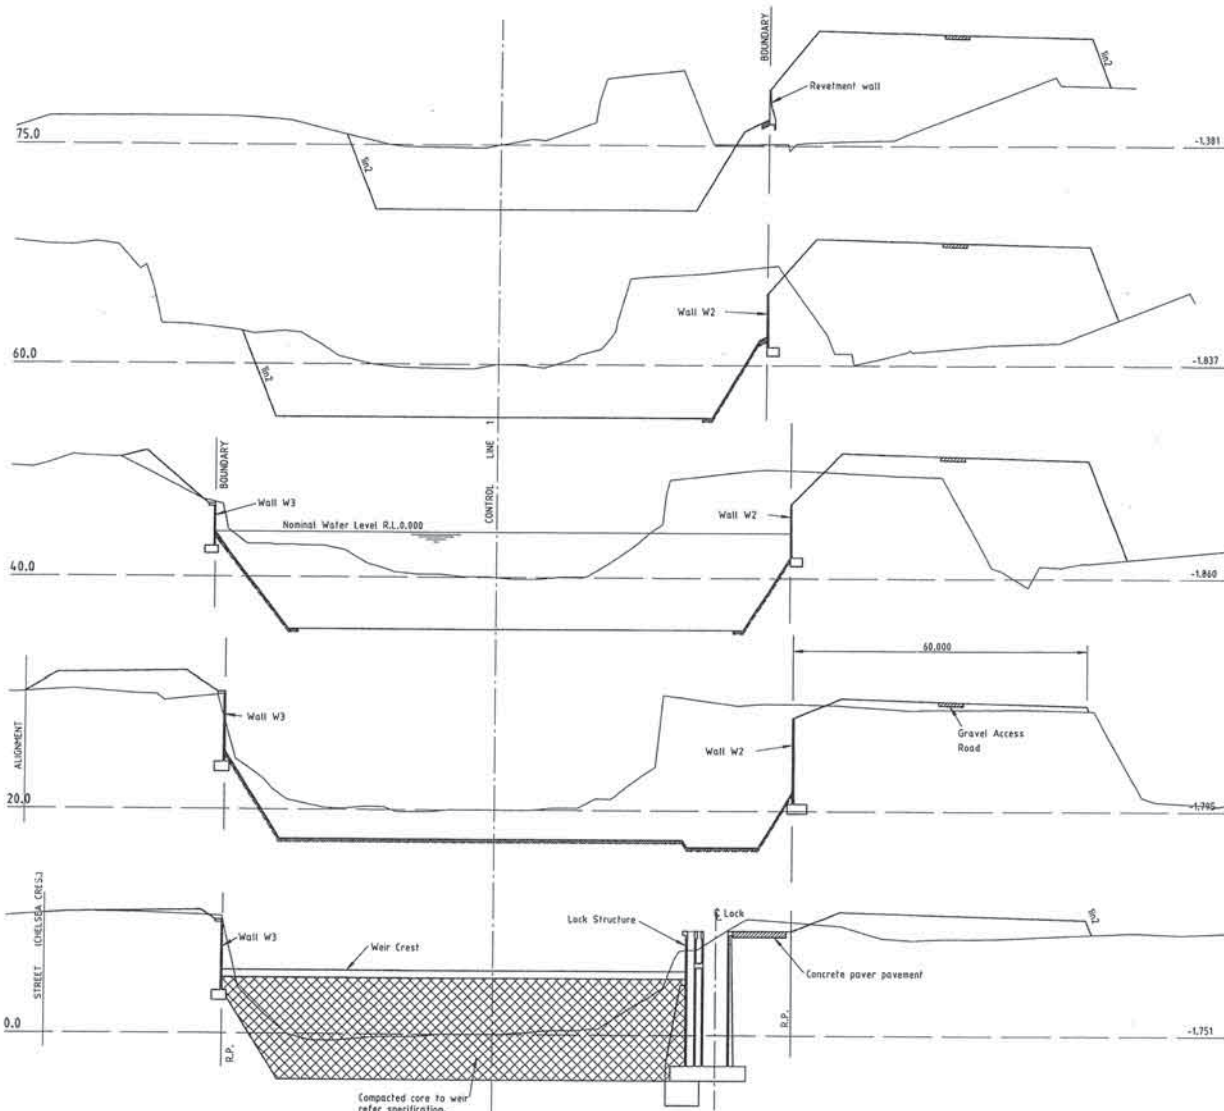

CROSS SECTIONS

HOR. 1:500
VERT. 1:100

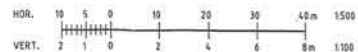

SCALE BEFORE REDUCTION

NOTES: KAWANA ESTATES PTY. LTD.
DATE: 11-12-1998



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DATE: 11-12-97	BY: <i>[Signature]</i>	DATE: 11-12-97	DATE: 11-12-97	DATE: 11-12-97
REVISIONS:				
NO.	DATE	REVISIONS	REC. APPR.	DATE
1	11-12-97	By-pass port removed from lock (CH. 0.0)	<i>[Signature]</i>	
2	11-12-97	General Revisions	<i>[Signature]</i>	

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Queensland Pty. Ltd.
CONSULTING ENGINEERS



OFFICE: Brisbane 071 234 8811
Gold Coast 071 234 8811
Cairns 071 234 8811
Townsville 071 234 8811
Port Moresby 071 234 8811
Sydney 02 9333 1111
Melbourne 03 9333 1111
Perth 08 9333 1111
Auckland 09 333 1111

KAWANA ESTATES PTY. LTD.
PARREARRA DEVELOPMENT
STRUCTURE Z
CONTROL LINE 1
CROSS SECTIONS

DATE: 11-12-1998
DRAWING NO: **478/95 - 5**

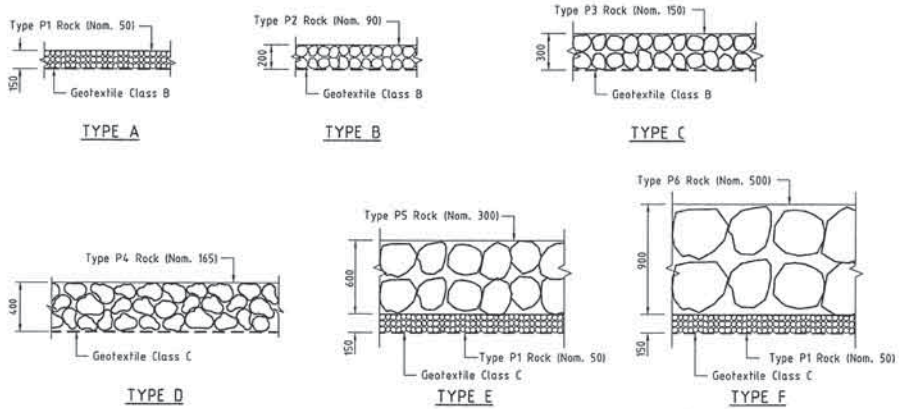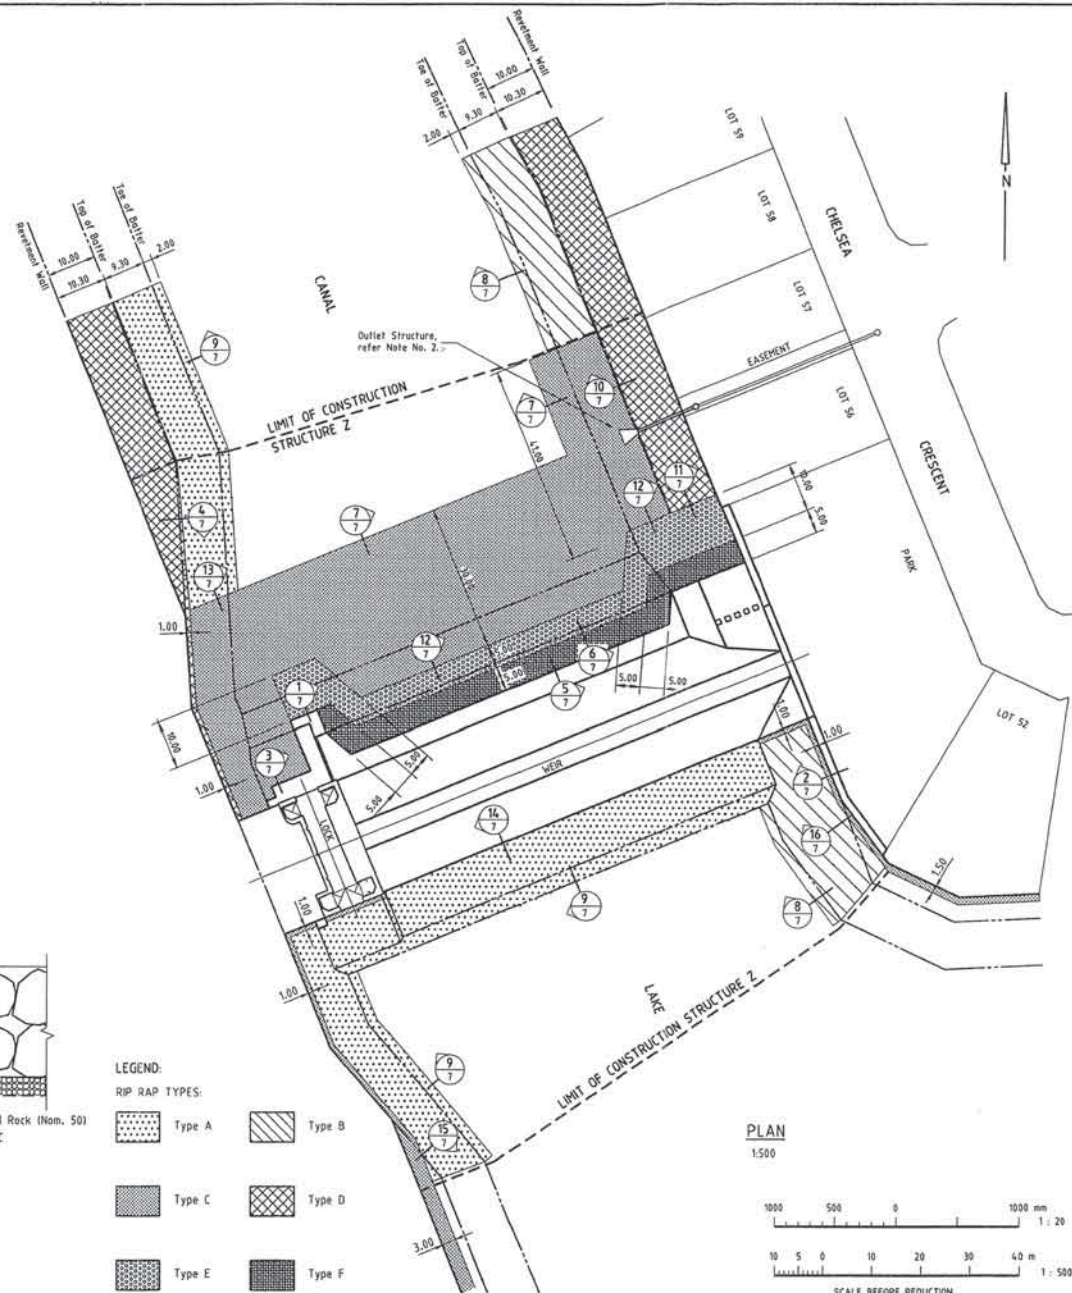

RIP RAP TYPE SECTIONS
Scale 1 : 20

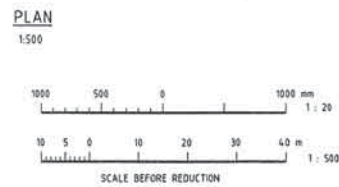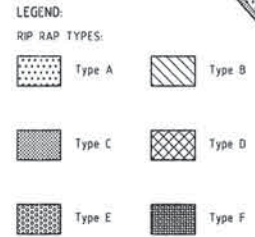

NOTES:
1) Refer to Dwg. No. 478/95-7 for rock specifications.
2) Outlet structure approved under Canals Act, not included in application for Section 86 approval.

AUTOCAD NAME: RYS.LDW
DATE: 21-6-1997 TIME: 10:40 AM

NO.	DATE	REVISIONS	REC. APPR. No.	DATE	PROJ. APPR.
1	13-11-97	Rip rap layout revised			
2	23-09-97	Butter width revised.			
3	24-06-97	Note No. 2 added.			
4	11-06-97	General Revisions			
5	31-05-97	Rip rap types and extents amended			

DESIGNED: <i>[Signature]</i>	DATUM:
CHECKED: <i>[Signature]</i>	A.H.D.
REVISIONS:	
PROJ. APPR. <i>[Signature]</i>	

C&D **Cardno & Davies**
Queensland Pty. Ltd.
Consulting Engineers






OFFICE: Brisbane, Gold Coast, Mackay, Townsville, Cairns, Port Moresby, Darwin, Perth, Sydney, Melbourne, Adelaide, Hobart, Auckland, Christchurch, Dunedin, Wellington, Auckland, Christchurch, Dunedin, Wellington.

TELEPHONE: 07 551 2000, 07 551 2001, 07 551 2002, 07 551 2003, 07 551 2004, 07 551 2005, 07 551 2006, 07 551 2007, 07 551 2008, 07 551 2009, 07 551 2010, 07 551 2011, 07 551 2012, 07 551 2013, 07 551 2014, 07 551 2015, 07 551 2016, 07 551 2017, 07 551 2018, 07 551 2019, 07 551 2020.




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SHIPPING COAST OFFICE: 48 Dandenong Avenue, Queensland
Postal Address: PO Box 153, Mackay, Queensland, Australia 4740

KAWANA ESTATES PTY. LTD.		DATE: 11-12-1995
PARREARRA DEVELOPMENT		DRAWING No:
STRUCTURE Z		478/95 - 6
SCOUR PROTECTION PLAN		

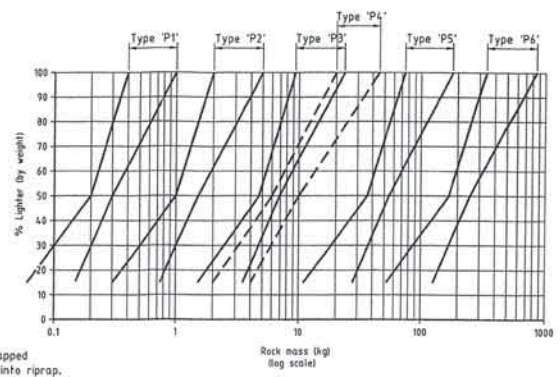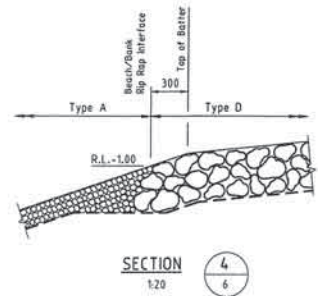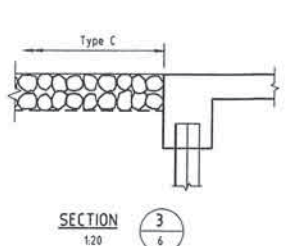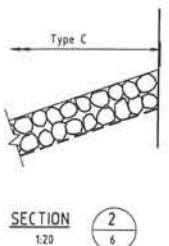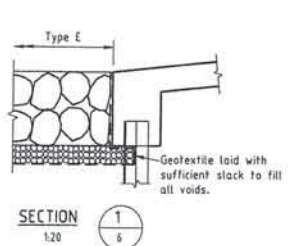





ROCK GRADING GRAPH
Refer drawing 478/96-13 for explanation of gradings chart.

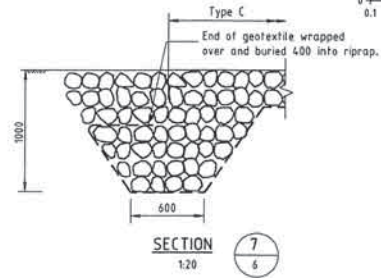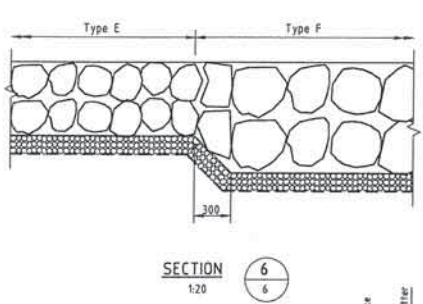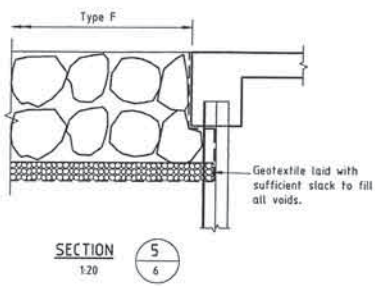

ROCK GRADING TABLE:

PARAMETER	RANGE	ROCK TYPE					
		P1 (Nom. 50)	P2 (Nom. 90)	P3 (Nom. 150)	P4* (Nom. 165)	P5 (Nom. 300)	P6 (Nom. 500)
W ₁₅	min.	0.06	0.30	1.50	2.00	11	53
	max.	0.15	0.75	3.50	4.00	28	128
W ₅₀	min.	0.20	1.00	4.70	6.00	37	170
	max.	0.30	1.50	7.00	10.00	56	255
W ₁₀₀	min.	0.40	2.00	9.40	20.00	75	340
	max.	1.00	5.00	24.00	45.70	187	850




All gradings given in dry mass (kg.)

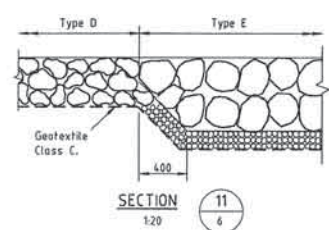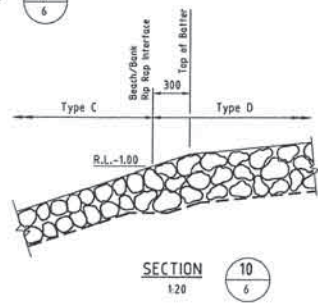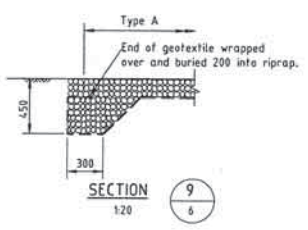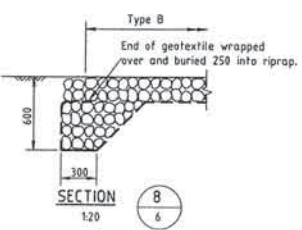

GEOTEXTILE SPECIFICATION TABLE:


Property	Test	Geotextile Class	
		B	C
Minimum grab tensile strength (N)	AS2091.2.3	1000	1800
Minimum G Rating	Austroroads	2500	4700
Minimum trapezoidal tear strength (N)	AS3786.3	600	600
Maximum pore size (E05 μm)	AS3786.7	200	200
Minimum permittivity (s ⁻¹)	AS3786.9	0.5	0.5

Refer Note No.8

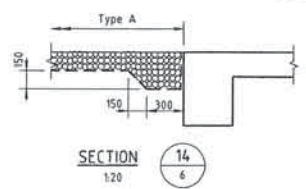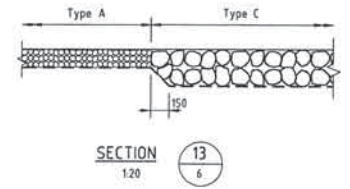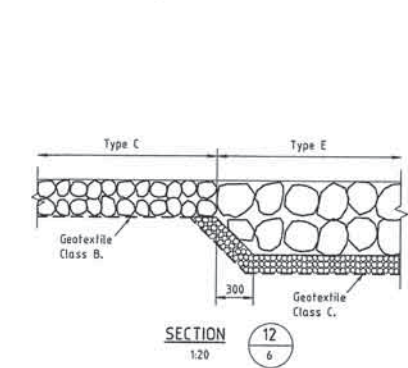

NOTES:

1. A representative sample of rock shall be obtained from the quarry in accordance with AS114.1.3.
2. The dry density of the rock shall not be less than 2500 kg/m³ in accordance with AS4133.2.1.2.
3. The ratio of maximum to minimum dimensions of any rock shall not exceed three.
4. The Los Angeles value of the rock shall not exceed 20 in accordance with AS114.1.2.3.
5. The maximum permissible loss for each fraction shall be 12% in accordance with AS114.1.2.4.
6. Geotextile fabric shall be lapped 100mm minimum and shall be keyed at the edges to the satisfaction of the Superintendent.
7. Rock of larger size may be substituted if approved by the Superintendent. If larger rock is used, specified layer thicknesses must be increased whilst maintaining nominated finished levels and profiles.
8. Geotextiles shall be non-woven, needle punched fabrics consisting of polyester or polypropylene polymers.

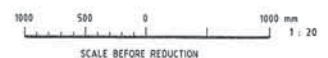


ADFCAS MADE K95-7.246
DATE: 10-11-97 TIME: 3:51 PM

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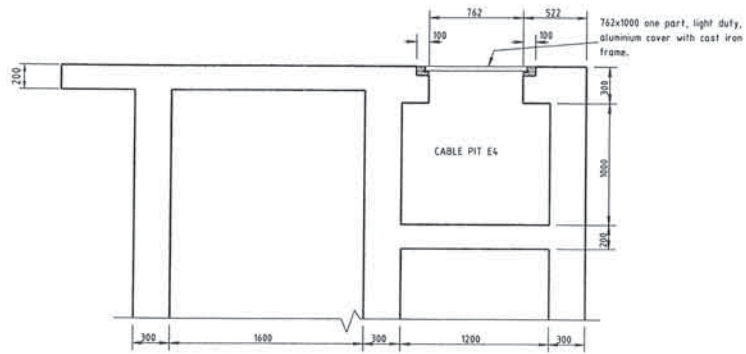
C&D Cardno & Davies
Queensland Pty. Ltd.
Consulting Engineers

KAWANA ESTATES PTY. LTD.
PARREARRA DEVELOPMENT
STRUCTURE 2
SCOUR PROTECTION SECTIONS AND DETAILS


DATE: 05-06-1994
DRAWING NO: 478/95 - 7

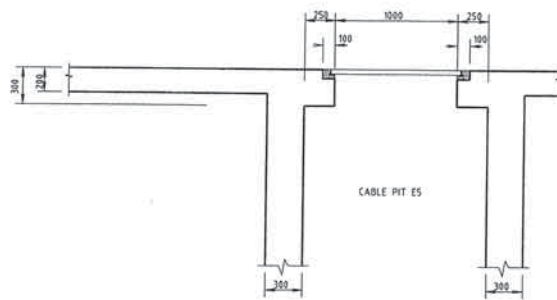


SECTION 11
120 10




SECTION 12
120 10

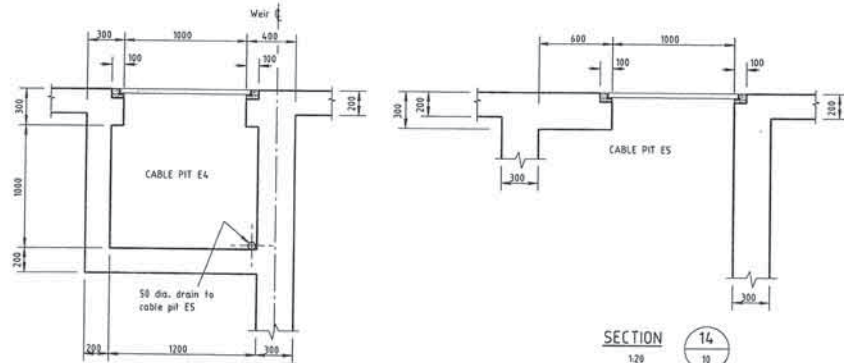

SECTION 13
120 10

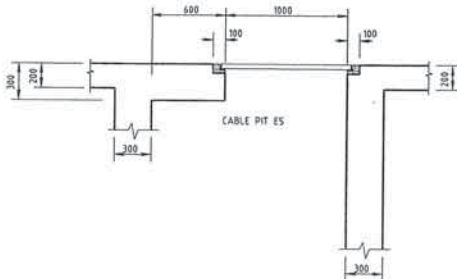


SECTION 14
120 10

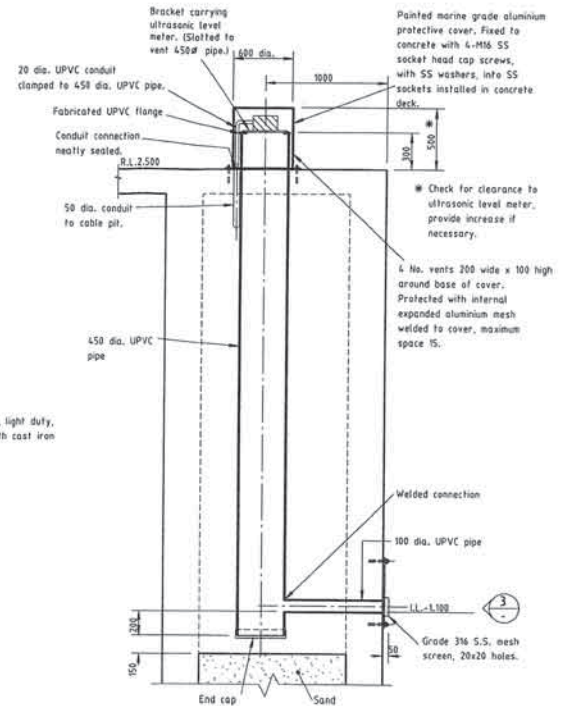


SECTION 15
120 10

STILLING WELL






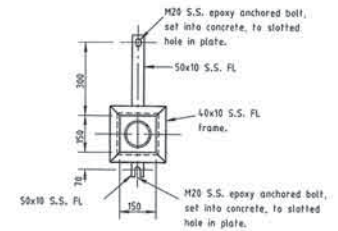


ELEVATION 3
1:10

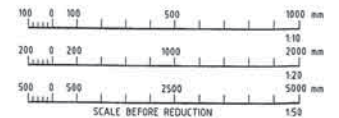

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DATE: 11-4-1995 TIME: 3:56 PM

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						E 1/8-01-95				A1	A.H.D.		Cardno & Davies	081 134 9111	081 134 9112	PARREARRA DEVELOPMENT		11-12-1995		
						D 15-01-97							Queensland Pty. Ltd.	081 134 9111	081 134 9112	STRUCTURE 2			478/95 - 11	
						C 23-09-97							Cardno & Davies	081 134 9111	081 134 9112	LOCK STRUCTURE				
						B 06-05-97							Cardno & Davies	081 134 9111	081 134 9112	CONCRETE PROFILES - SHEET No. 2				
						A 11-01-97							Cardno & Davies	081 134 9111	081 134 9112					
													Cardno & Davies	081 134 9111	081 134 9112					

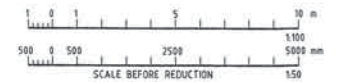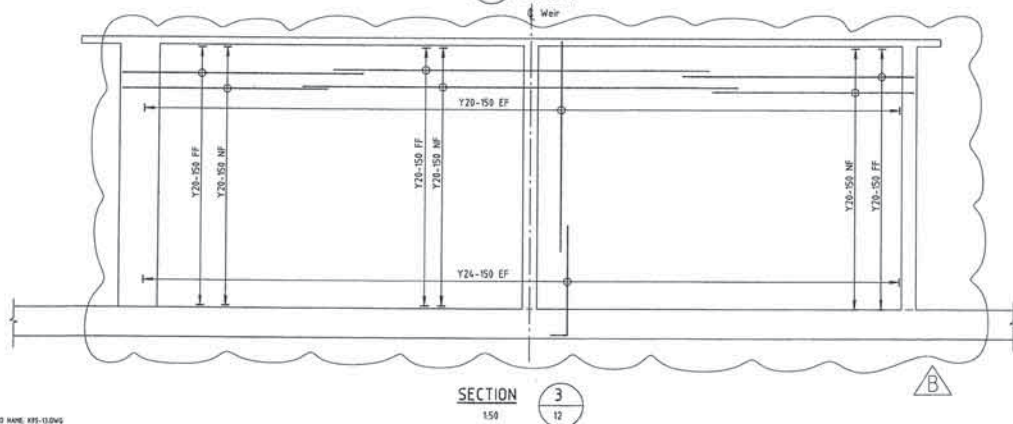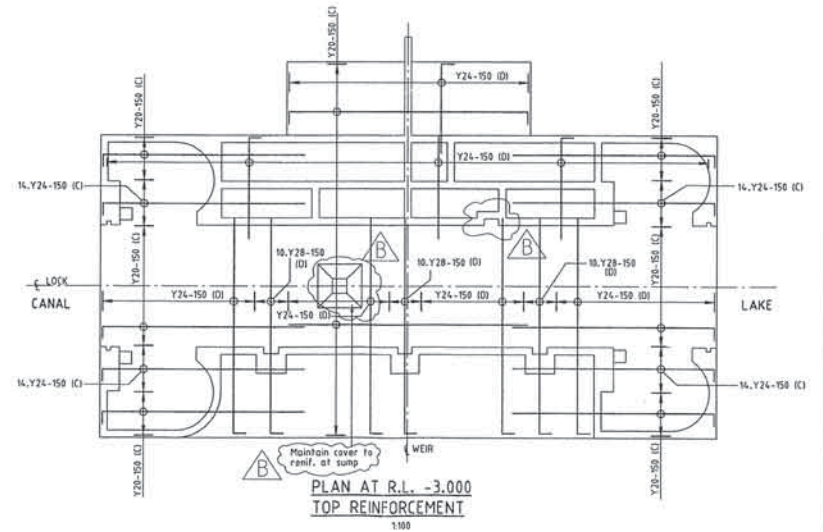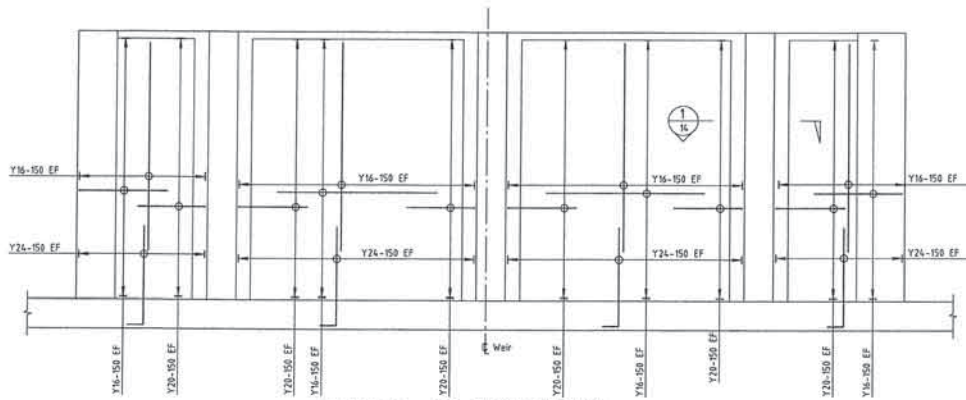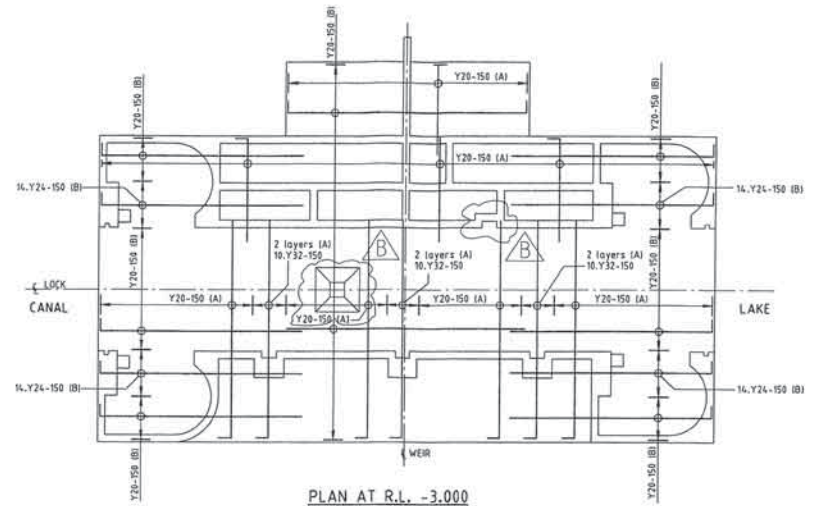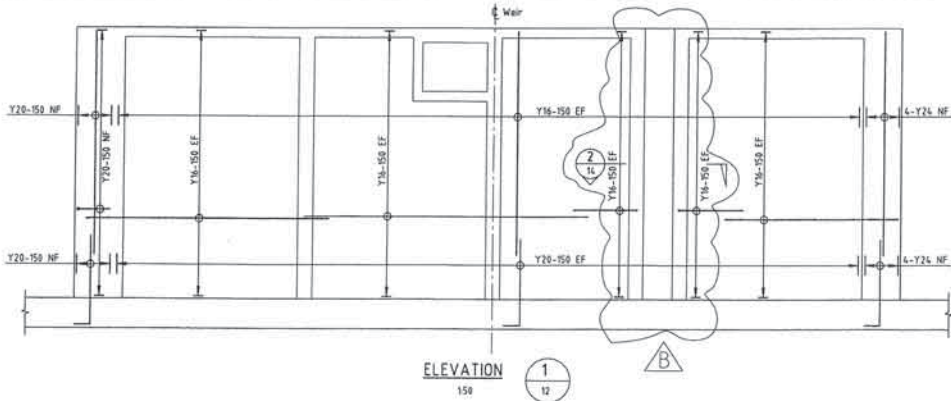

AUTOCAD NAME: KRS-13.DWG
DATE: 24-11-1995 3:04 PM

NO.	DATE	REVISIONS	REC. APPROV.	DATE
C	23-09-97	Cable pit ES added.		
B	06-05-97	Bypass channel removed, ladder recess added		
A	11-04-97	General Revisions		





DESIGNED: PKM
DRAWN: C.P. Han
CHECKED: SDC
RECOMMENDED: [Signature]
PROJ. NAME: [Signature]
APPV. [Signature]
DATE: [Signature]

C&D Cardno & Davies
Queensland Pty. Ltd.
CONSULTING ENGINEERS

OFFICE: Brisbane
Gold Coast
Townsville
Cairns
Mackay
Rockhampton
Palmerston North
Wellington
AUCKLAND

KAWANA ESTATES PTY. LTD.
PARREARRA DEVELOPMENT
STRUCTURE 2
LOCK STRUCTURE
REINFORCEMENT DETAILS - SHEET No.2

DATE: 11-12-1995
DRAWING NO: 478/95 - 13

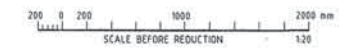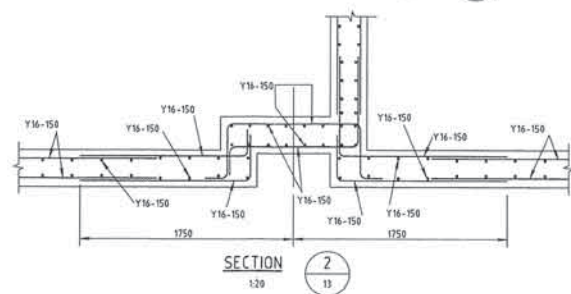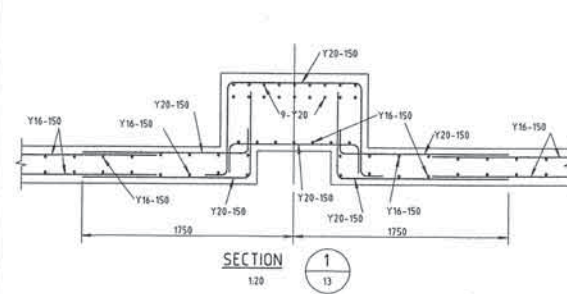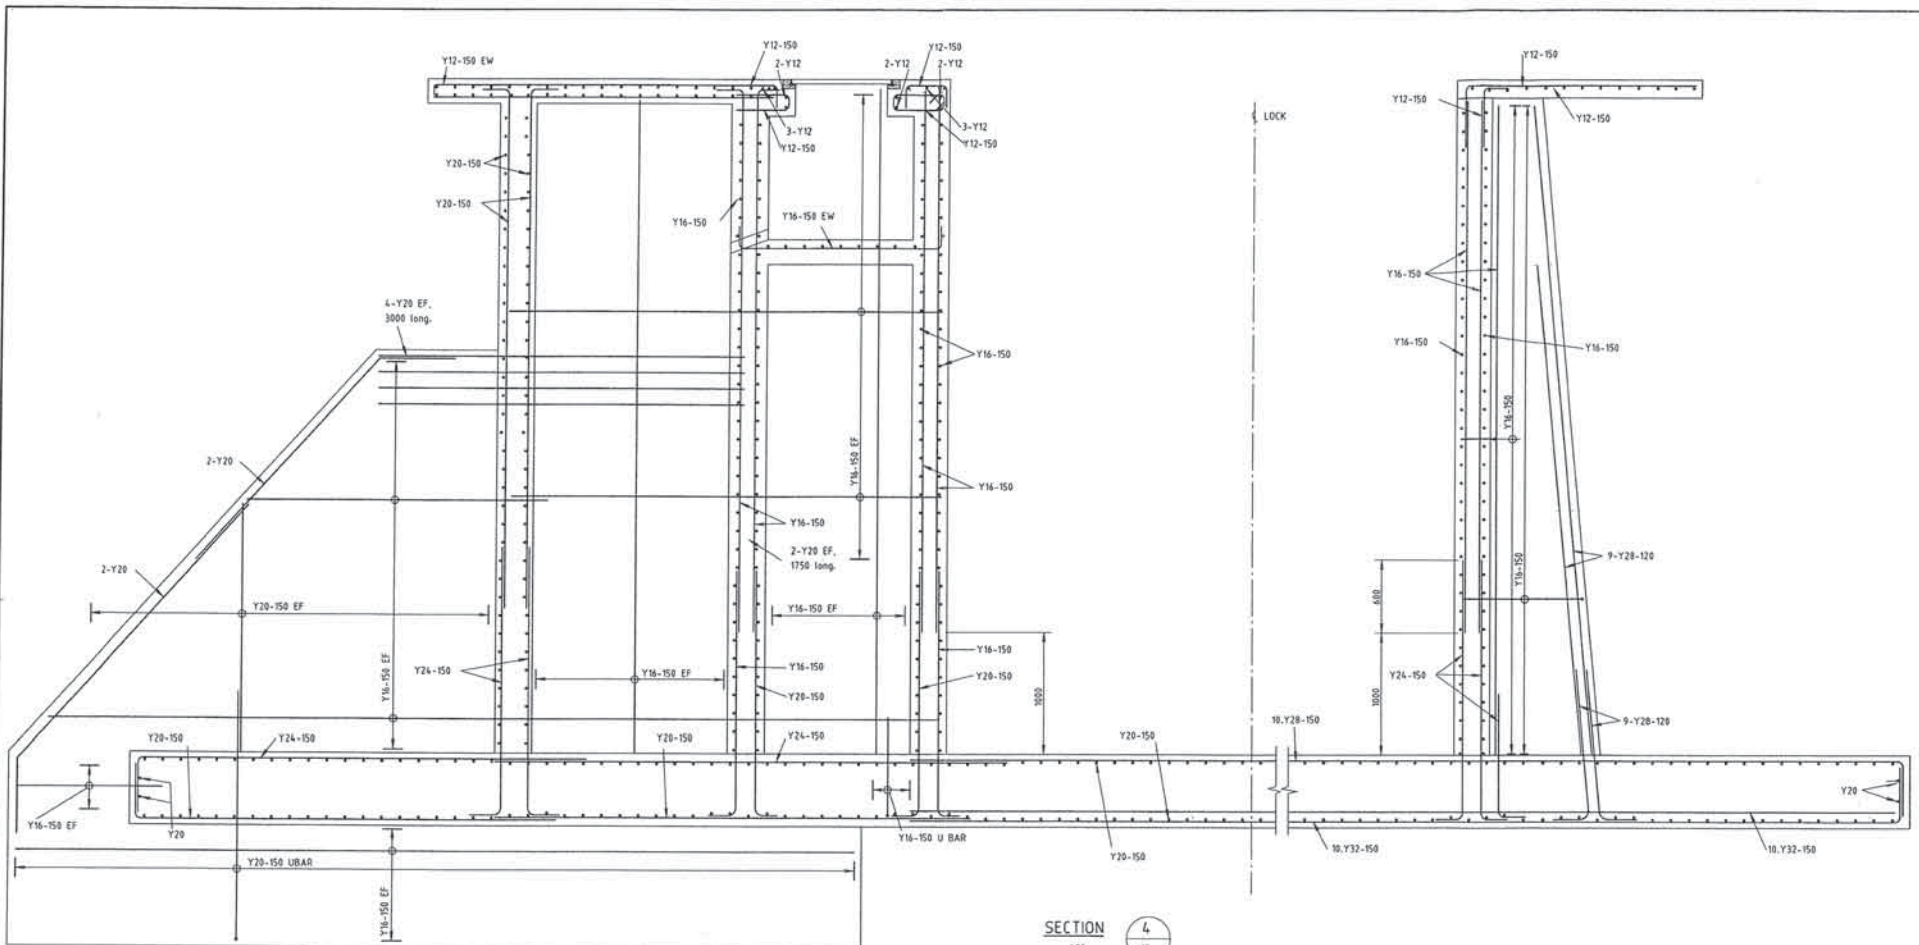


AUTOCAD DRAWN: KSI-11/96
DATE: 11-12-1996

NO.	DATE	REVISIONS	REC.	APPROV.	DATE
E	24-02-98	Top slab revised, opposite to weir side of lock.			
D	28-01-98	Slab edge at RL 2.500 at weir changed to 200 thick.			
C	08-10-97	Notes to refer to section 4/10 revised.			
B	16-05-97	Spigot channel removed. Ladder recess added.			
A	11-04-97	General Revisions			

DESIGNED: *[Signature]*
 DRAWN: *[Signature]*
 CHECKED: *[Signature]*
 RECOMMENDED:
 PROJ. MAN:
 APPROV. *[Signature]*
 DATE: 11/12/96

DATUM: A.H.D.
C&D **Cardno & Davies**
 Queensland Pty. Ltd.
 204 ROYAL HWY
 CONSULTING ENGINEERS
 OFFICE: 25 GARDNER AVENUE, BRISBANE QLD 4000
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 FAX: (07) 3254 1112
 BRISBANE: (07) 3254 1111
 GOLD COAST: (07) 5441 1111
 MACKAY: (07) 4931 1111
 TULLOCH: (07) 4931 1111
 SARAH GARDNER: (07) 3254 1111
 SARAH GARDNER: (07) 3254 1111

KAWANA ESTATES PTY. LTD.
 PARREARRA DEVELOPMENT
 STRUCTURE Z
 LOCK STRUCTURE
 REINFORCEMENT DETAILS - SHEET No.3
 DATE: 11-12-1996
 DRAWING NO: **478/95 - 14**

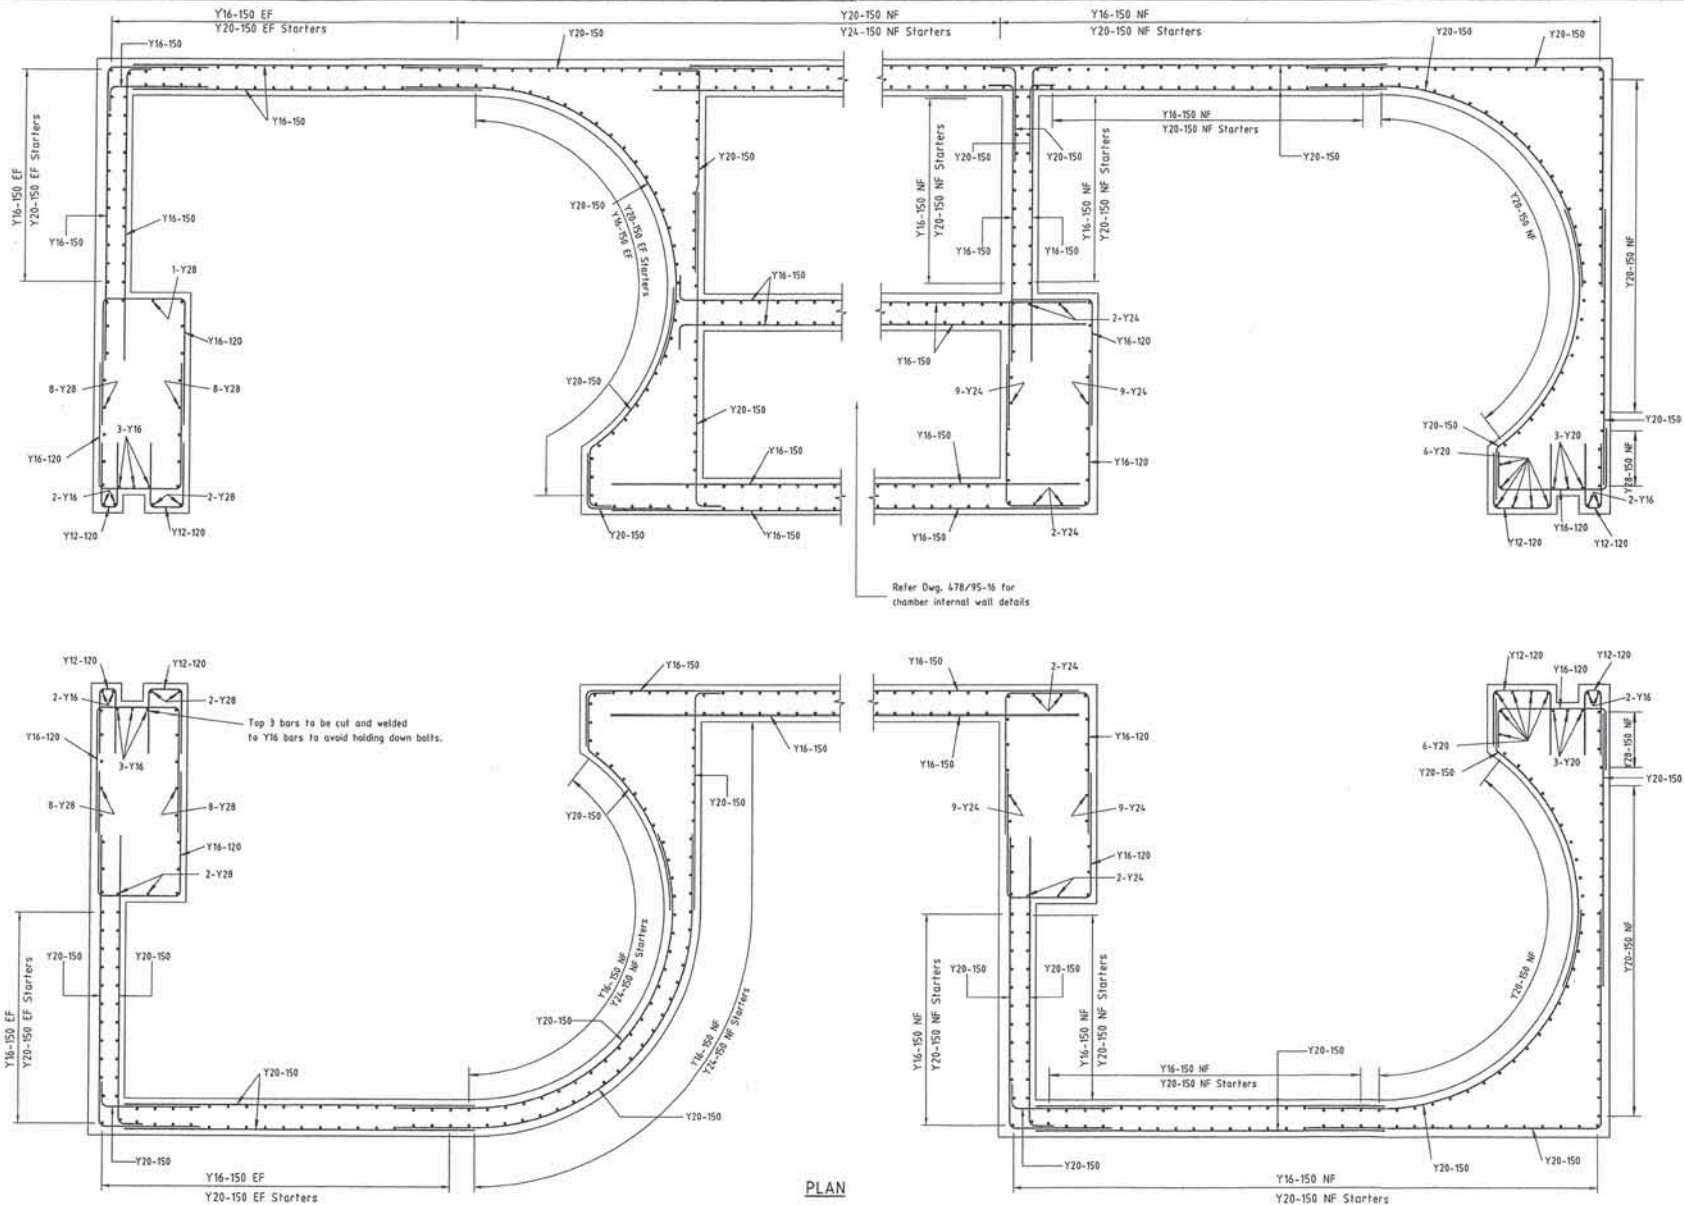

PLAN
1:20

REINFORCEMENT TO WALLS AT GATE RECESSES

(TOP SLAB NOT SHOWN FOR CLARITY)

NOTE:
Provide starter bars to match vertical wall reinforcement U.N.D. 300 bottom cog. Lap as follows - Y16 - 600, Y20 - 800, Y24 - 1000, Y28 - 1100.

200 0 200 1000 2000 mm
SCALE BEFORE REDUCTION
1:20

AUTOCAD FILE: 478-15.dwg
DATE: 11-04-97

REV.	DATE	REVISIONS	REC.	APPR.	DATE	REC.	APPR.
D	06-10-1997	Y28 horizontal reinf. shown					
C	20-03-97	Y16 starter bar infra added					
B	06-25-97	Bypass channel removed					
A	11-04-97	General Revisions					


DESIGNED: <i>[Signature]</i>	CHECKED: <i>[Signature]</i>	APPROVED: <i>[Signature]</i>
DATE: 11-04-97	DATE: 11-04-97	DATE: 11-04-97

C&D **Cardno & Davies**
Queensland Pty. Ltd.
CONSULTING ENGINEERS

OFFICE: 85 Dandenong Avenue, Melbourne, Victoria 3168
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EMAIL: cardno@cardno.com.au
WEBSITE: www.cardno.com.au

KAWANA ESTATES PTY. LTD.
PARREARRA DEVELOPMENT
STRUCTURE Z
LOCK STRUCTURE
REINFORCEMENT DETAILS - SHEET No.4

DATE: 11-12-1996
DRAWING No: 478/95-15

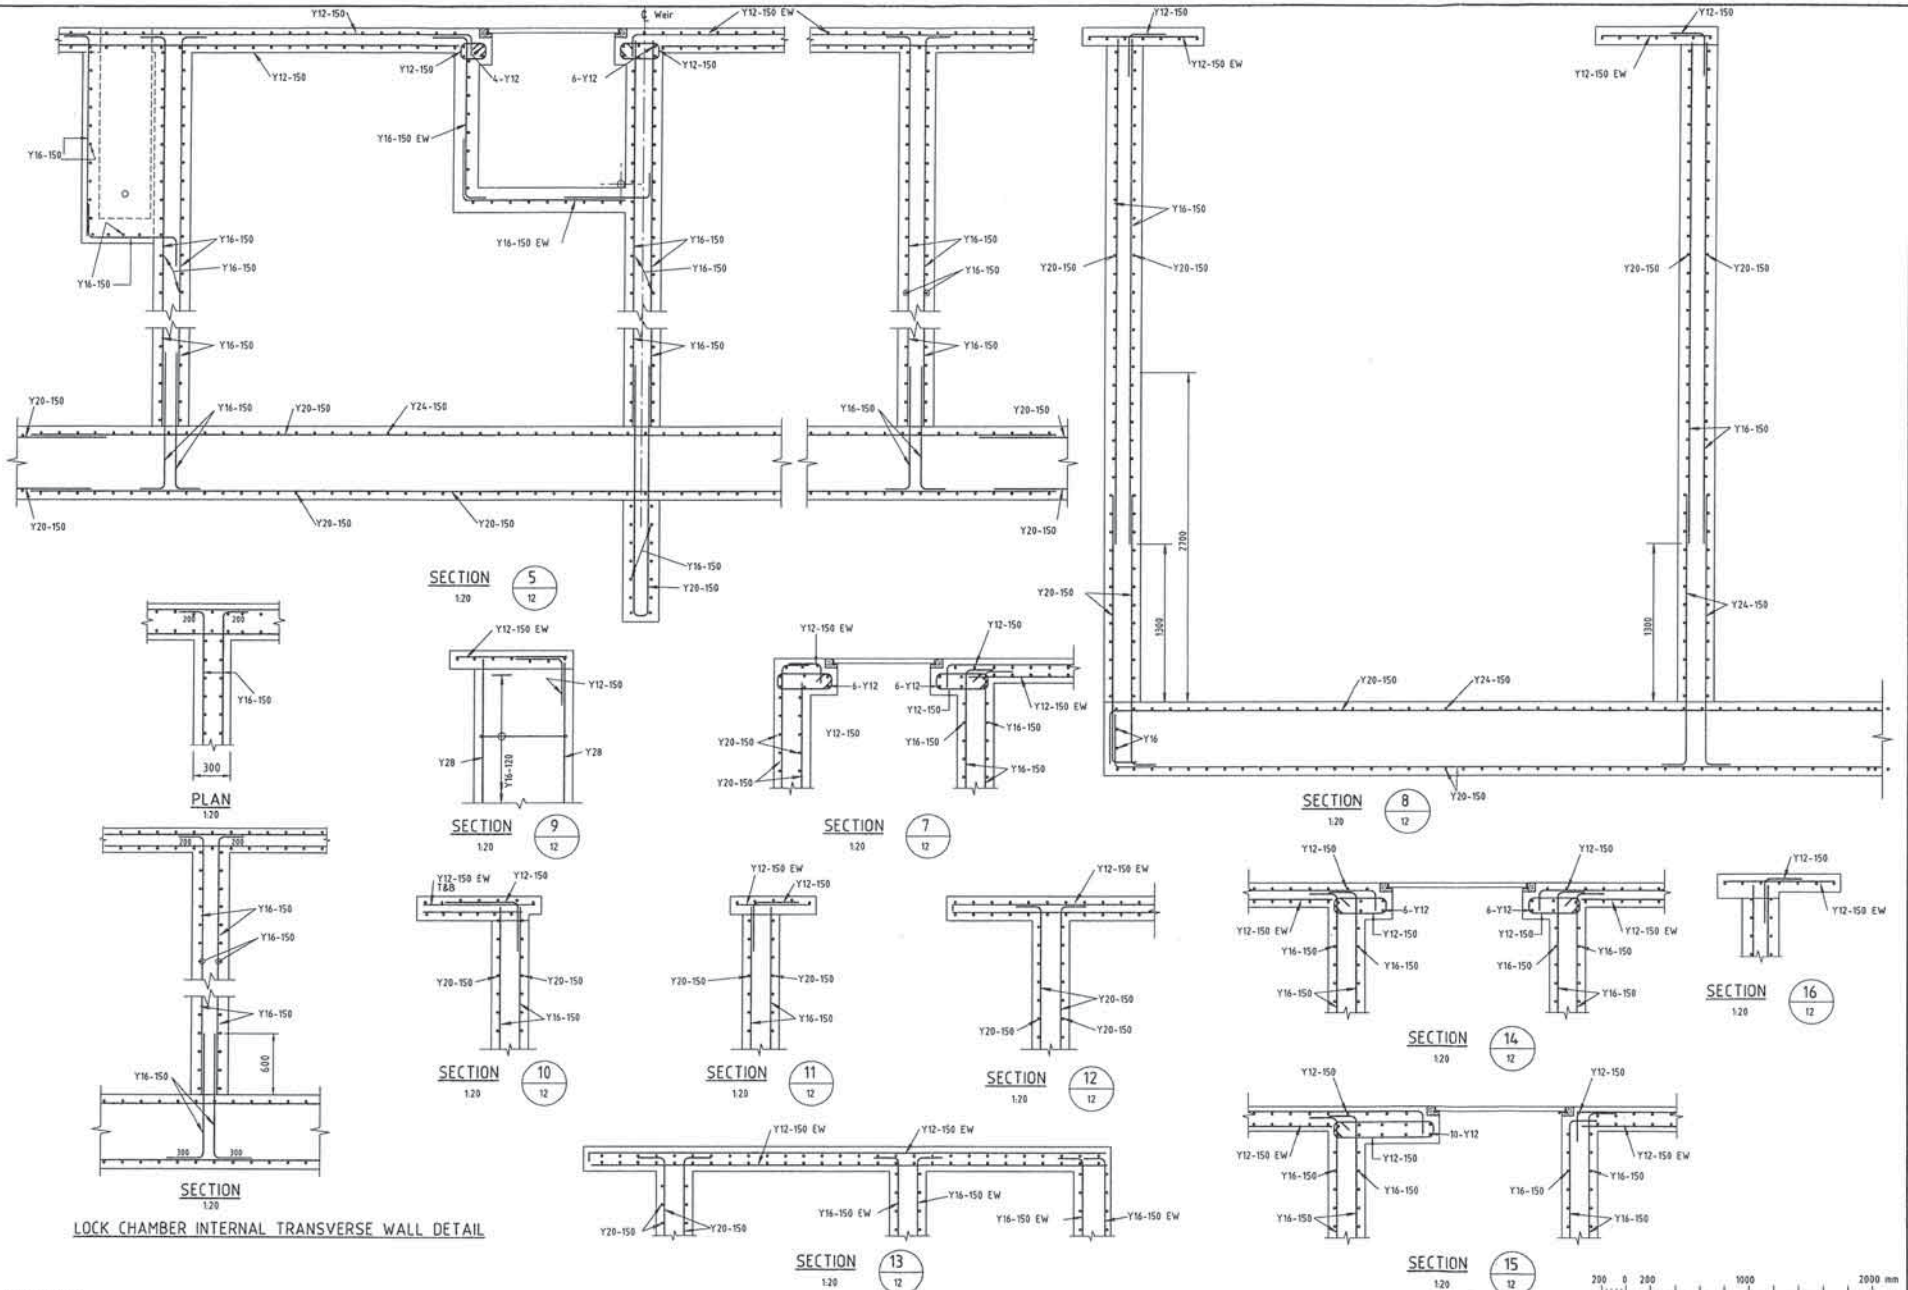

LOCK CHAMBER INTERNAL TRANSVERSE WALL DETAIL

AUTOCAD NAME: R16-11040

DATE: 20-6-1997 TIME: 1:48:30

NO.	DATE	REVISIONS	REC. APPR. No.	DATE	REC. APPR. No.
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2					
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16					


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 DRAWN: *[Signature]*
 CHECKED: *[Signature]*
 RECOMMENDED: *[Signature]*
 APPROVED: *[Signature]*

DATE: **A1**
 A.H.D.
C&D Cardno & Davies
 Queensland Pty. Ltd.
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 Consulting Engineers

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 Sydney Coast Office: 66 Riverside Avenue, Gosport/Wharfedale
 Phone: (02) 933 1111
 Facsimile: (02) 933 1111


KAWANA ESTATES PTY. LTD.
 PARREARRA DEVELOPMENT
 STRUCTURE 2
 LOCK STRUCTURE
 REINFORCEMENT DETAILS - SHEET No.5

DATE: 11-12-1996
 DRAWING No: **478/95 - 16**

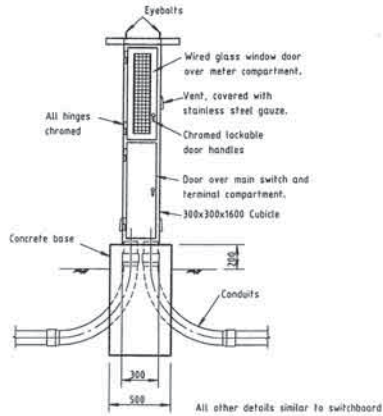


ELECTRICITY METER AND MAIN SWITCH CUBICLE

120

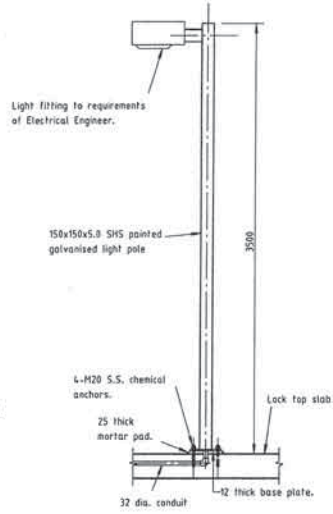


LIGHT POLE DETAILS (PL)

120

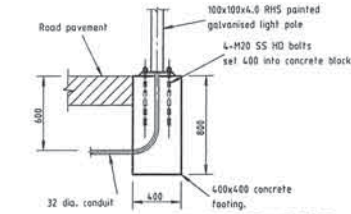


LIGHT POLE FOOTING TO ROAD PAVEMENT

120

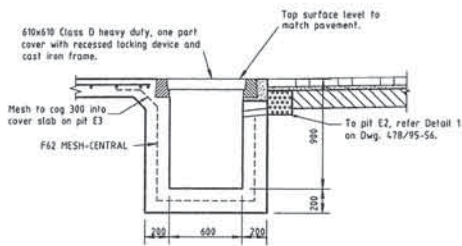

CABLE PIT E2 AND E3 DETAIL


120

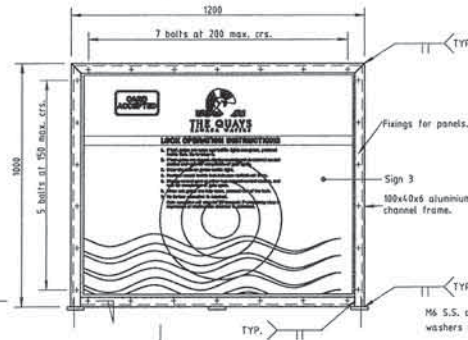

REMOTE CONTROL STATION TO
TIMBER JETTY / FLOATING PONTOON
ELEVATION


SECTION 2

2

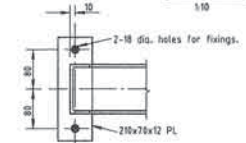


SECTION 2

15

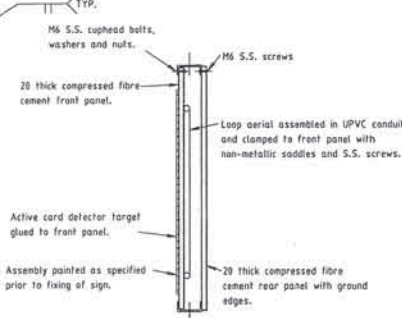


SECTION 1

110

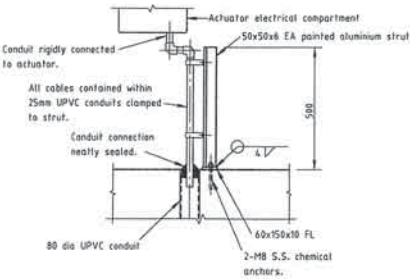

CONDUIT CONNECTION TO GATE ACTUATOR

110

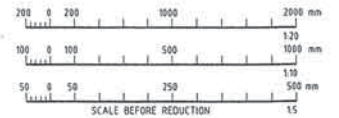

AUTOCAD 5.0 FILENAME: K95-10.DWG
DATE: 14-5-1995 TIME: 12:32 PM

NO.	DATE	REVISIONS	REV.	APPROV.	DATE

DESIGNED BY	DATE	DRAWN BY	CHECKED BY	RECOMMENDED BY	APPROVED BY
C. J. Haward	A1	A.H.D.			


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Auckland 09 389 9120







KAWANA ESTATES PTY. LTD.
PARREARRA DEVELOPMENT
STRUCTURE 2
LOCK STRUCTURE
MISCELLANEOUS CONDUIT AND ELECTRICAL DETAILS

DATE: 12-12-1996
Drawing No. 478/95 - 18

NOTE:
Cable pits E4 & E5 to have light duty, one part solid top aluminium cover with recessed locking device and cast iron frame. (refer Dwg. 478/95-11 for dimensions)

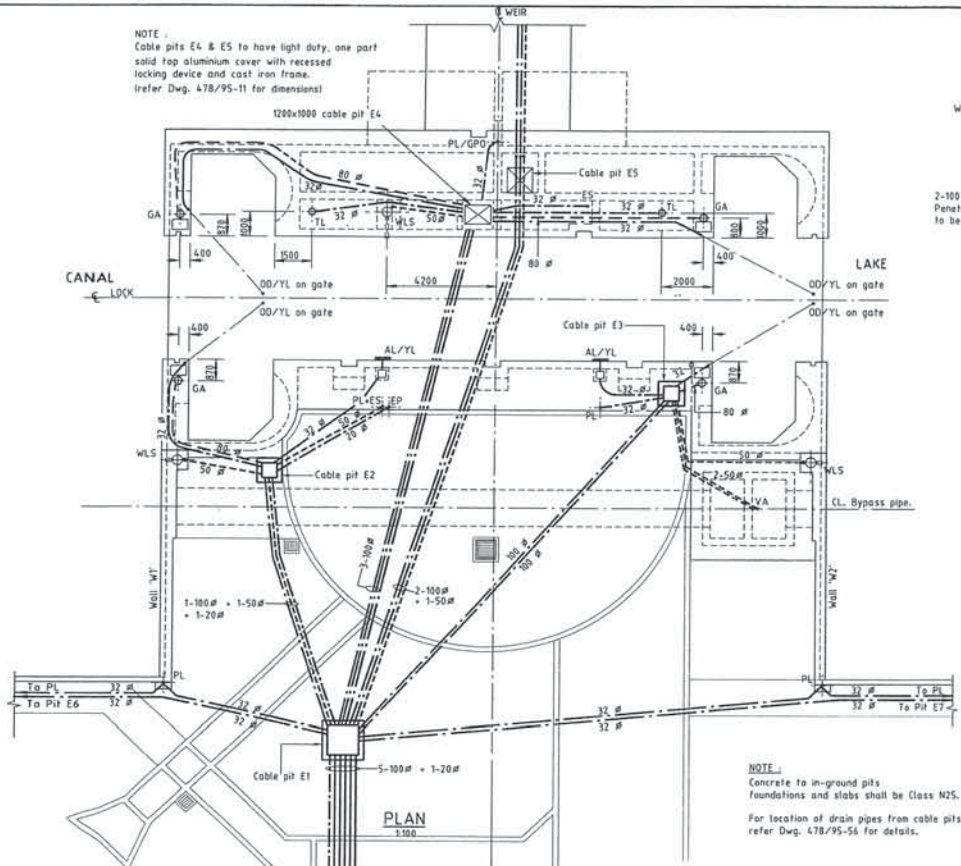

NOTE:
Concrete to in-ground pits foundations and slabs shall be Class N25. For location of drain pipes from cable pits refer Dwg. 478/95-56 for details.

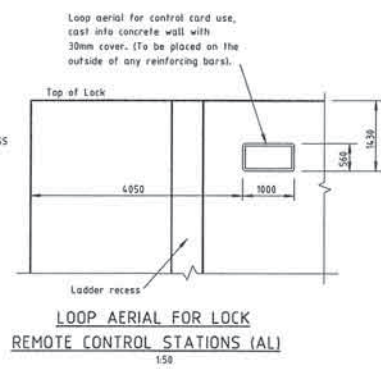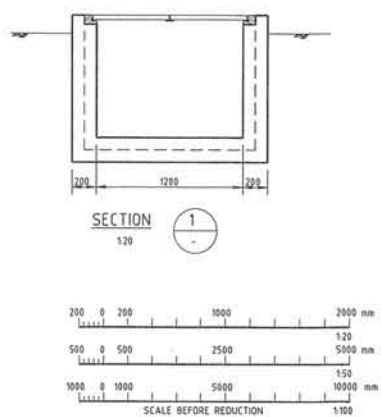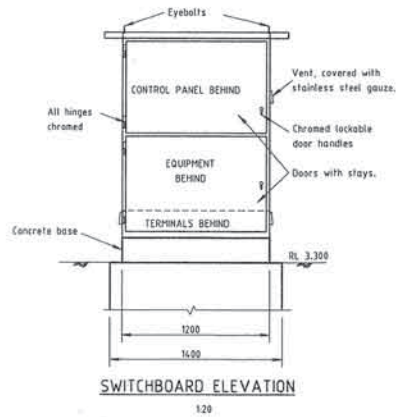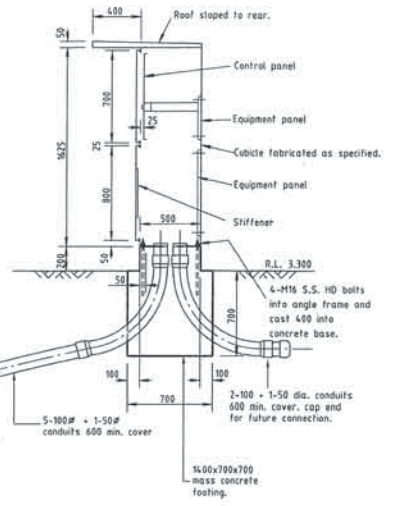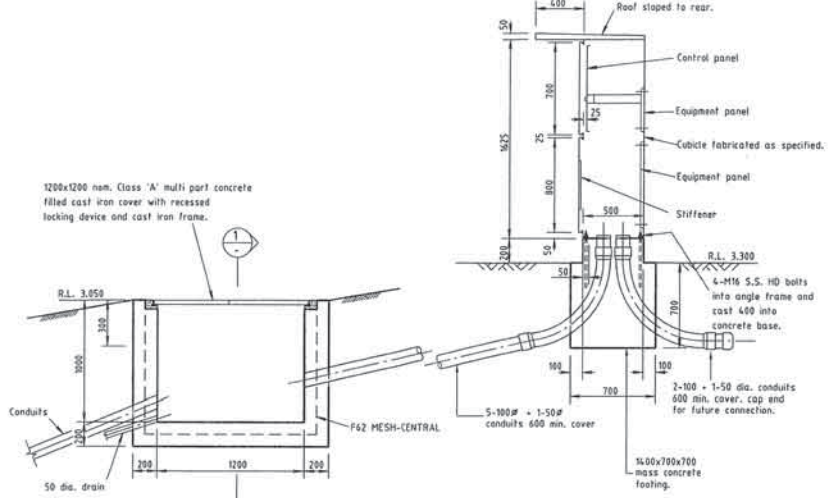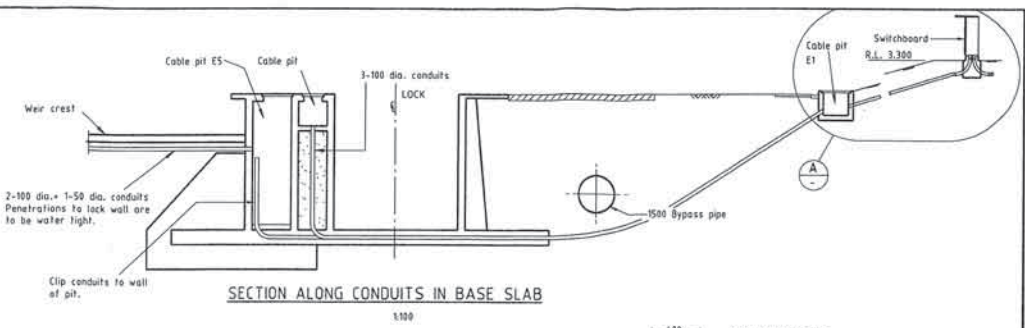

- LEGEND**
- 100 # 100 dia. UPVC Conduit
 - 80 # 80 dia. UPVC Conduit
 - 50 # 50 dia. UPVC Conduit
 - 32 # 32 dia. UPVC Conduit
 - 20 # 20 dia. UPVC Conduit
- 2-100 + 1-50 dia. conduits 600 min. cover, cap end for future connection.
- AL Local Loop Aerial for Lock Remote Control Station
 - EP Emergency Phone
 - ES Emergency Stop
 - GA Gate Actuator
 - GPD Waterproof Power Outlet (mounted on pole)
 - OD Obstruction Detector
 - PL Pole Light
 - TL Traffic Lights
 - VA Valve Actuator
 - WLS Water Level Sensor
 - YL Yellow Flashing Light

AUTOCAD R14 FILENAME: 478-11.DWG
DATE: 21-11-1995 TIME: 4:12 PM

NO.	DATE	REVISIONS	REC.	APPR.	DATE
1	07-04-98	Cable pit E1 dimensions revised.			
2	27-03-98	Cable pits E2 & E3 moved pit E1 dimensions revised.			
3	02-03-98	General Revisions to suit Landscaping requirements.			
4	28-01-98	General Revisions to suit Landscaping requirements.			


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DRAWN: *[Signature]*
CHECKED: *[Signature]*
RECOMMENDED: *[Signature]*
APPROVED: *[Signature]*

DATUM: **A1**
A.H.D.
C&D Cardno & Davies
Queenstown Pty. Ltd.
A/NZ 874 912
Consulting Engineers

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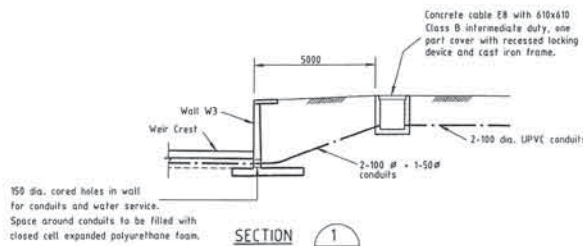
KAWANA ESTATES PTY. LTD.
PARREARRA DEVELOPMENT
STRUCTURE 2
LOCK STRUCTURE
CONDUIT PLAN AND DETAILS

DATE: 11-12-1995
DRAWING No: **478/95-17**

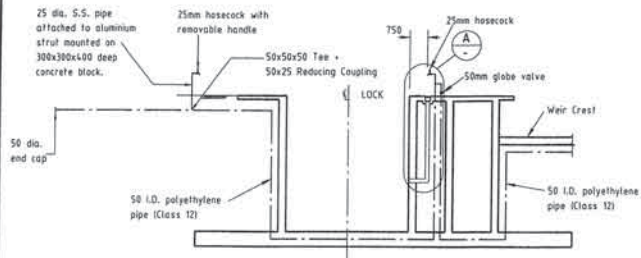


SECTION ALONG WATERSERVICE IN BASE SLAB

1:100




150 dia. cored holes in wall for conduits and water service. Space around conduits to be filled with closed cell expanded polystyrene foam.

SECTION 1/9

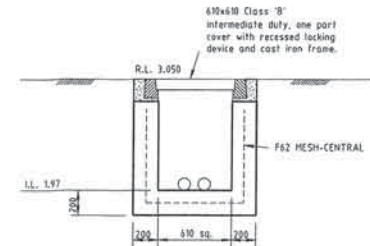

CABLE PIT EB DETAIL

1:20

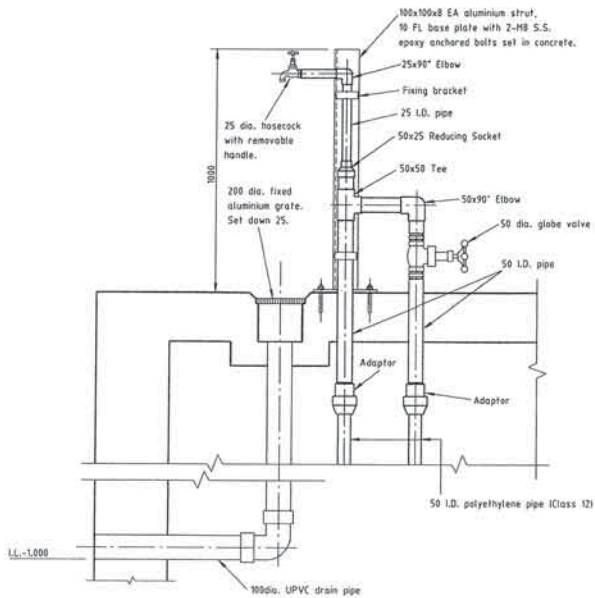


DETAIL A

1:10

NOTES

1. All exposed pipework and fittings shall be Grade 316 stainless steel.
2. All buried pipework and fittings shall be polyethylene.

Note : Contractor shall allow for water supply to Hydraulic Actuators to bypass valve system if required by that system. This is not shown on the drawings.

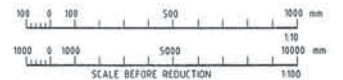

AUTOCAD NAME: KIS-19-015
DATE: 04-10-1994 THE: 1:18 PM

NO.	DATE	REVISIONS	REC.	APPR.	BY	DATE
E	02-03-98	Section 1/9 revised and Cable Pit EB Detail added.				
D	29-10-97	Section 1/9 revised.				
C	23-09-97	Section 1/9 revised.				
B	0-25-97	Notes added.				
A	11-04-97	General Revisions.				

DESIGNED: <i>[Signature]</i>	DRAWN: <i>[Signature]</i>	CHECKED: <i>[Signature]</i>	REVISIONS: <i>[Signature]</i>
PROJ. MAN. <i>[Signature]</i>	APPROVED: <i>[Signature]</i>	DATE: 04-10-94	


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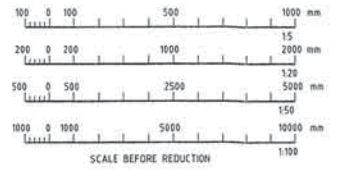
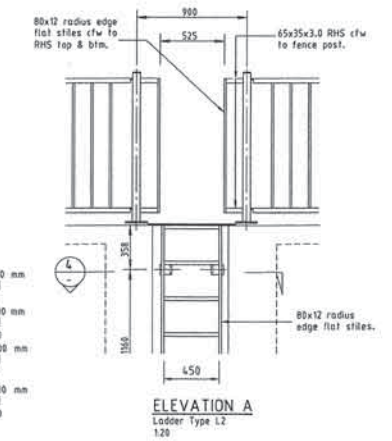
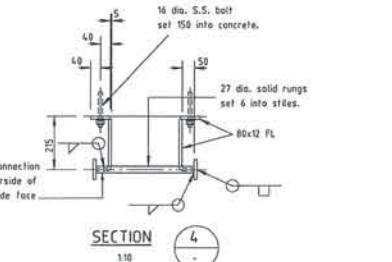
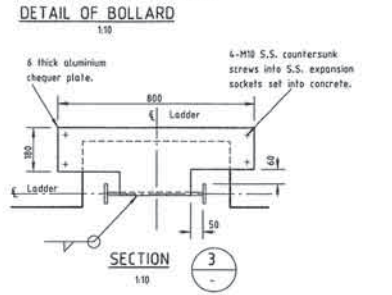
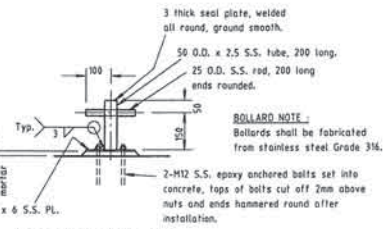
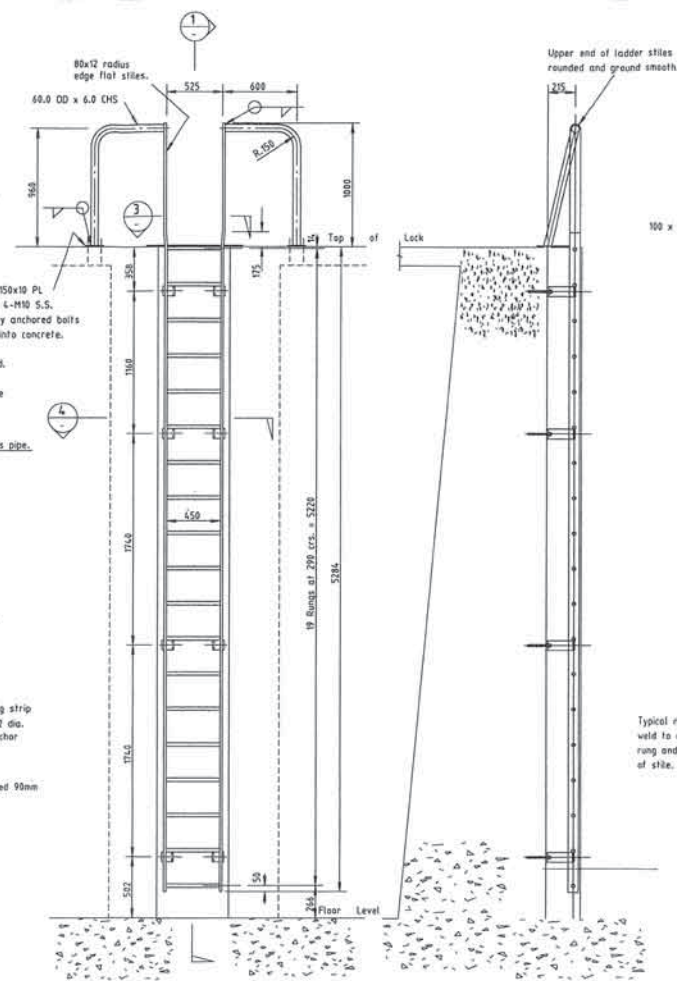
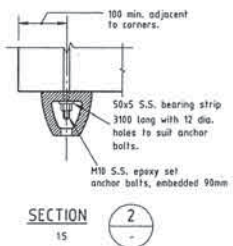
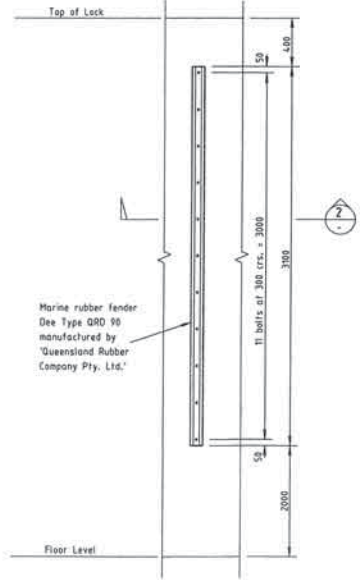
KAWANA ESTATES PTY. LTD.
PARREARRA DEVELOPMENT
STRUCTURE 2
LOCK AND WEIR STRUCTURE
WATER SERVICE DETAILS

DATE: 12-12-1994

DRAWING NO. 478/95 - 19



- NOTE:**
- Gates 1, 2, 3, 5, 7, 9, 11, 12, 13, 15 & 16 shall be locked to prevent public access.
 - Fence panels marked A & gates 1 & 7 shall have an additional bottom rail and vertical bars at 75mm crs.
 - Fence to be nominally 1200 high where indicated 1200h, 2200 high where indicated 2200h.
 - Ladders Type L1 and Type L2 as detailed, for base plate and ball setout refer Dwg. 478/95-53.
 - Gates 1, 3, 5, 7, 12, 13 & 15 are to be 2200 high.

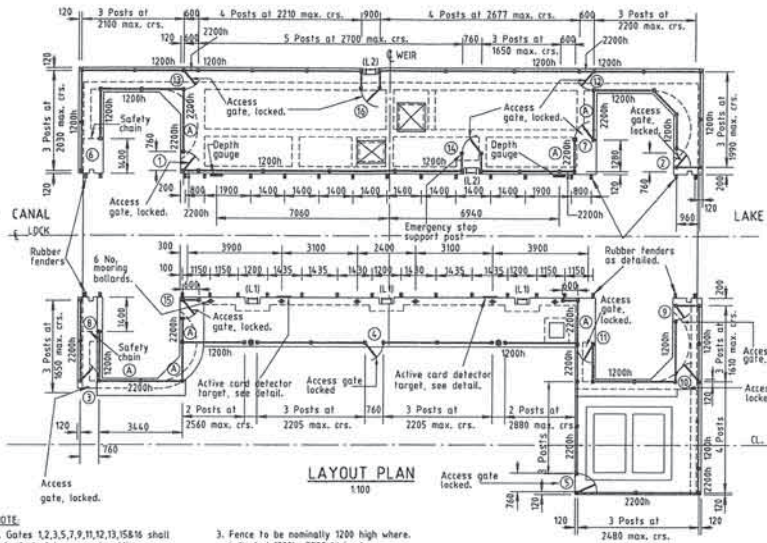

- LADDER NOTES:**
- Ladders and brackets shall be fabricated from aluminium alloy 6061 to Temper T6.
 - All welds shall be 6mm continuous fillet using filler alloy 5356.
 - Welding shall be in accordance with A.S.1845.
 - Bolts, nuts and washers shall be stainless steel Type 316.
 - Washers shall be used under all bolt heads and nuts.
 - Apply a slip resistant coating to all ladder rungs.

HUTCHER & N. FLEMING 895-20-00
DATE 14-3-1998 TIME 0:37 PM

DESIGNED	DATE	BY	REVISION
C.G. Ryan	A1	A.H.D.	
CHECKED			
RECOMMENDED			
DATE			
11-04-97			


DESIGNED: C.G. Ryan
DATE: A1
BY: A.H.D.
CHECKED:
RECOMMENDED:
DATE: 11-04-97

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Queensland Pty. Ltd.
CONSULTING ENGINEERS


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KAWANA ESTATES PTY. LTD.
PARREARRA DEVELOPMENT
STRUCTURE 2
LOCK STRUCTURE
MISCELLANEOUS DETAILS

DATE: 12-12-1996
DRAWING NO: 478/95-20

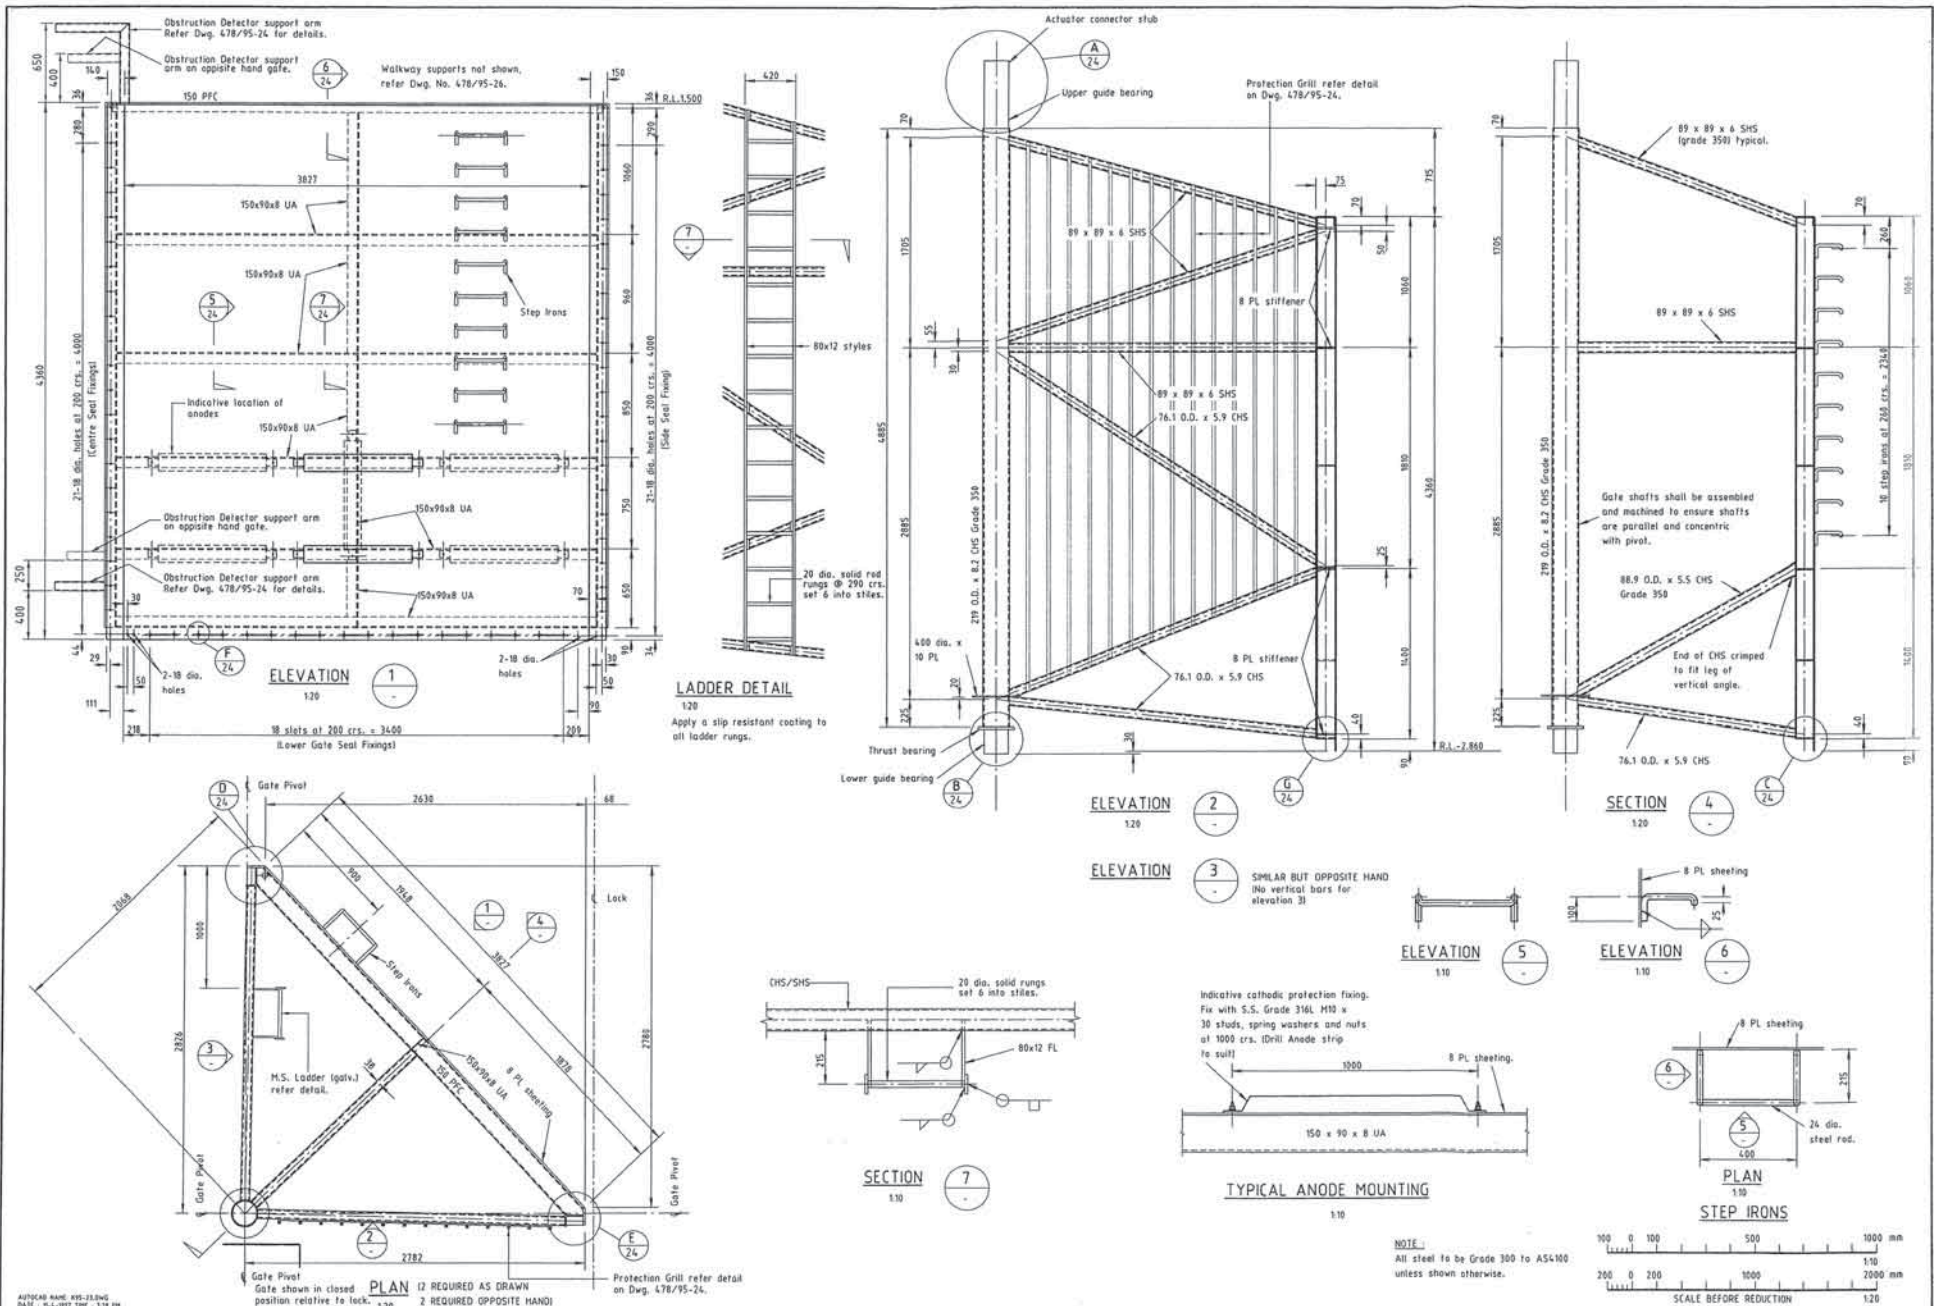

AUTHOUR NAME: 05-23-1998 DATE: 5-6-1997 TIME: 1:29 PM	DESIGNED: <i>[Signature]</i> DRAWN: <i>[Signature]</i> CHECKED: <i>[Signature]</i> RECOMMENDED: <i>[Signature]</i> PROJECT NAME: <i>[Signature]</i>	DATE/TIME: A.H.D. C&D Cardno & Davies Queensland Pty. Ltd. CONSULTING ENGINEERS	OFFICE: <i>[Address]</i> TELEPHONE: <i>[Number]</i> FAX: <i>[Number]</i> PROJECT NO.: <i>[Number]</i> DRAWING NO.: <i>[Number]</i> SHEET NO.: <i>[Number]</i> SCALE: <i>[Scale]</i> PROJECT: <i>[Project Name]</i> CLIENT: <i>[Client Name]</i> ADDRESS: <i>[Address]</i> PHONE: <i>[Number]</i> FAX: <i>[Number]</i>	KAWANA ESTATES PTY. LTD. PARREARRA DEVELOPMENT STRUCTURE 2 LOCK STRUCTURE GATE FABRICATION DETAILS - SHEET No.1	DATE: 12-12-1996 478/95 - 23
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AUTOCAD 8.0 FILENAME: 478-21.DWG
DATE: 15-01-1998 TIME: 8:02 AM








110
2 OFF AS SHOWN
2 OFF OPPOSITE HAND

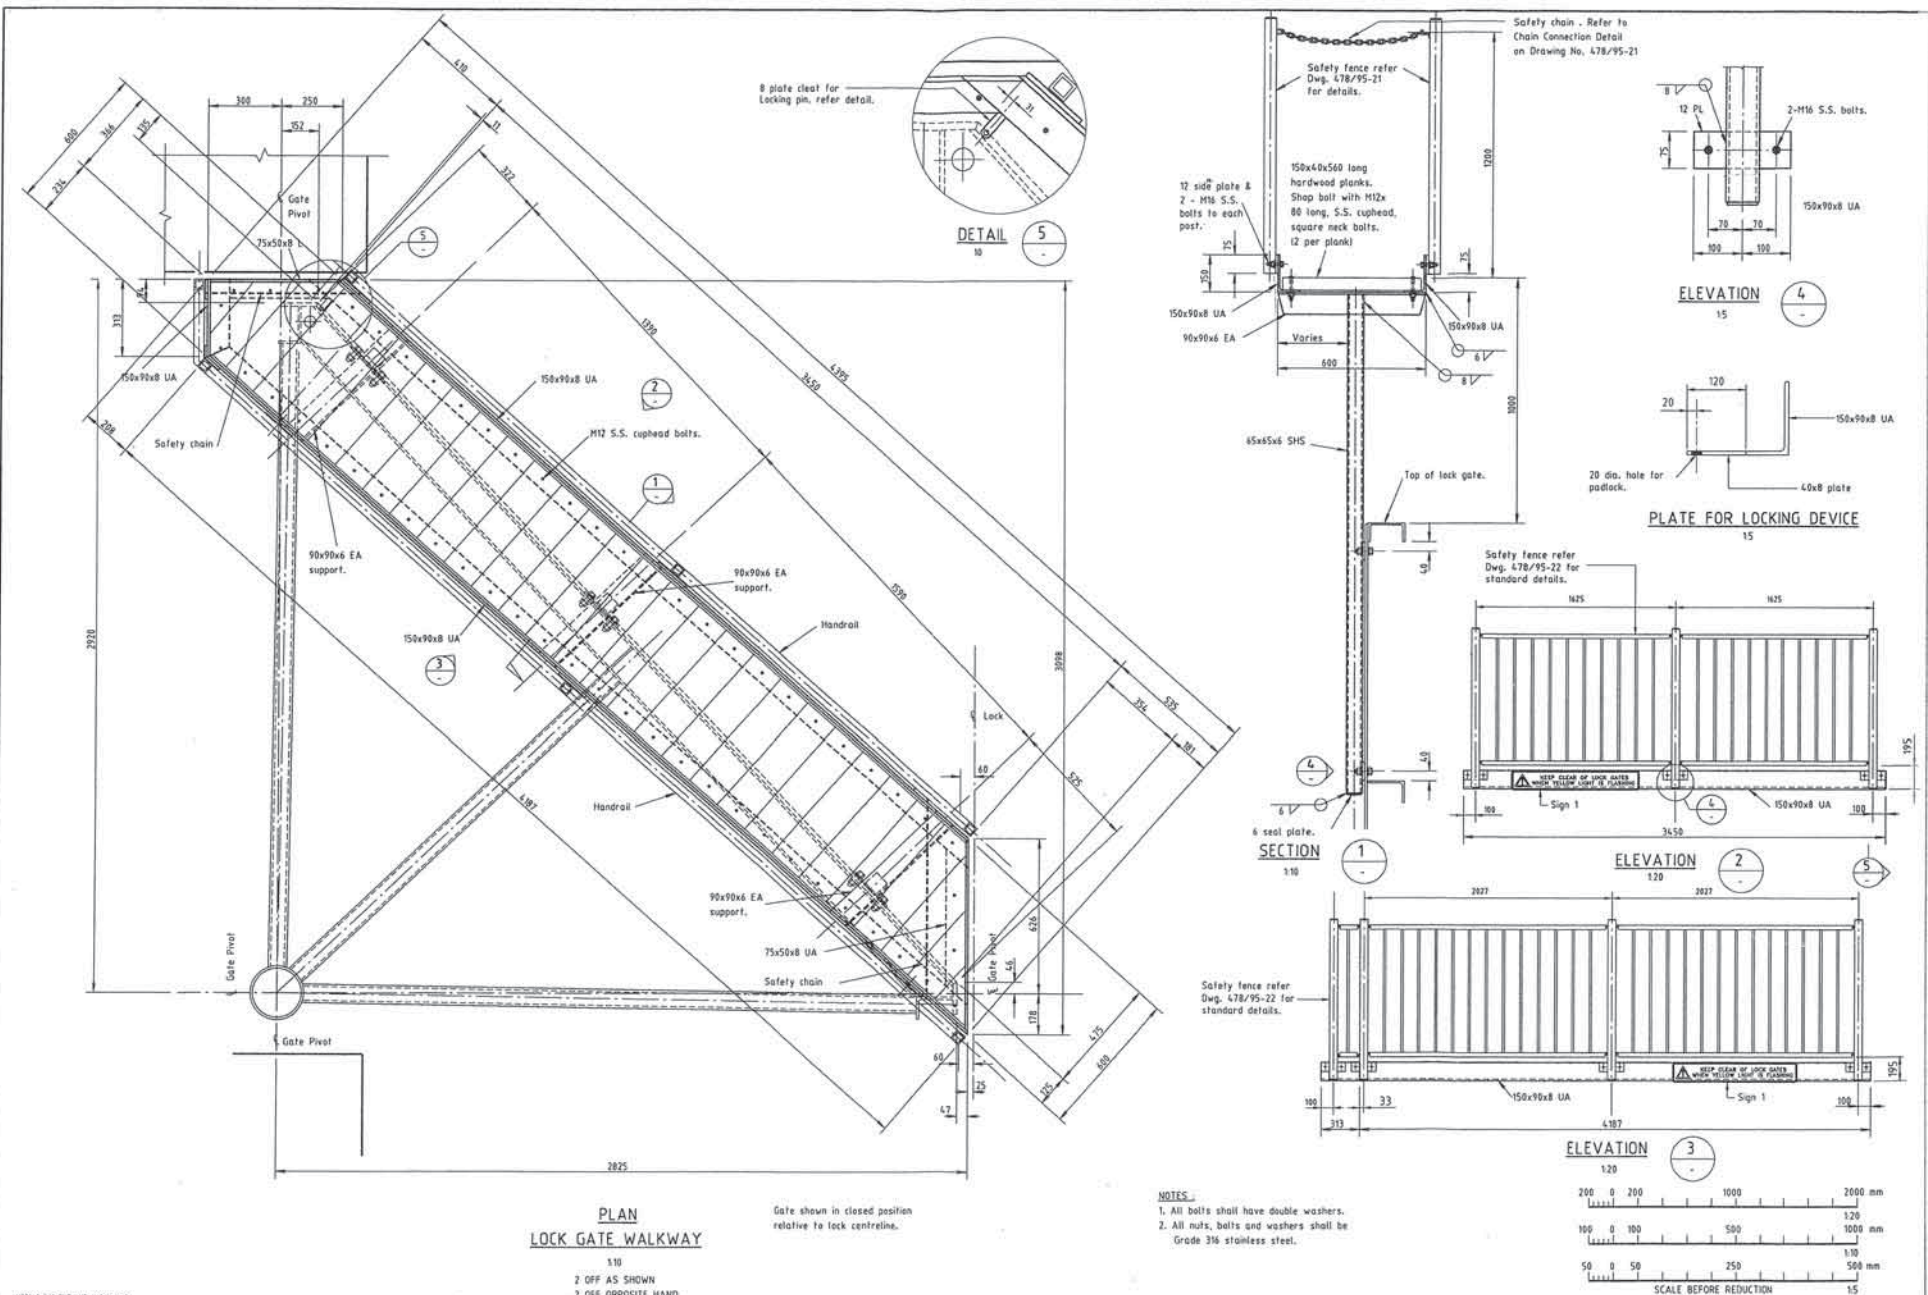DESIGNED: <i>[Signature]</i>	CHECKED: <i>[Signature]</i>	RECOMMENDED: <i>[Signature]</i>	APPROVED: <i>[Signature]</i>	DATE: 12-12-1998
DATE: 11-05-98	Sign 1 added to Elevations 2 and 3.			
DATE: 03-03-98	Tabular hand rail changed to Safety Fence.			
DATE: 1-05-97	Safety Chain added.			
DATE: 11-04-97	General Revisions			

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316 401 411
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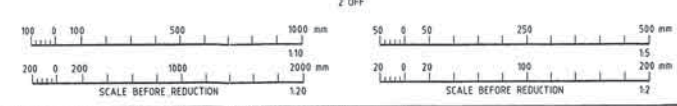
KAWANA ESTATES PTY. LTD.
PARREARRA DEVELOPMENT
STRUCTURE 2
LOCK STRUCTURE
LOCK GATE WALKWAY DETAILS

DATE: 12-12-1998
DRAWING No: 478/95 - 26

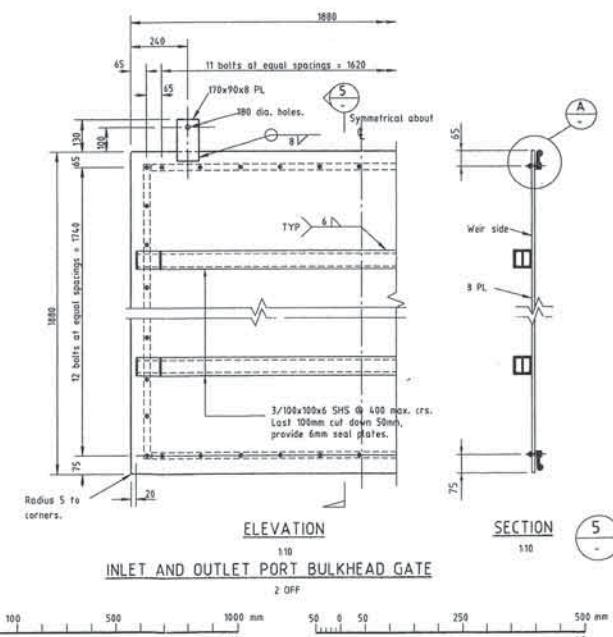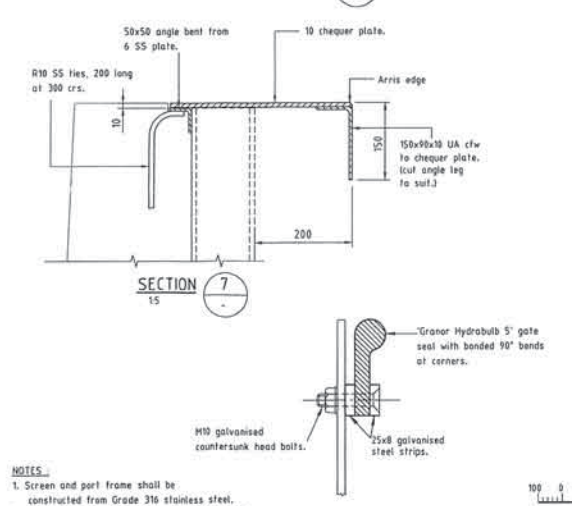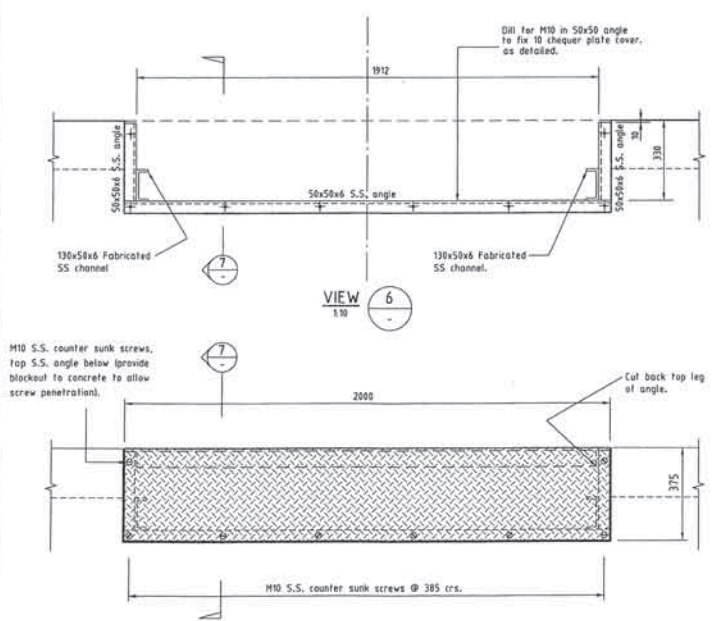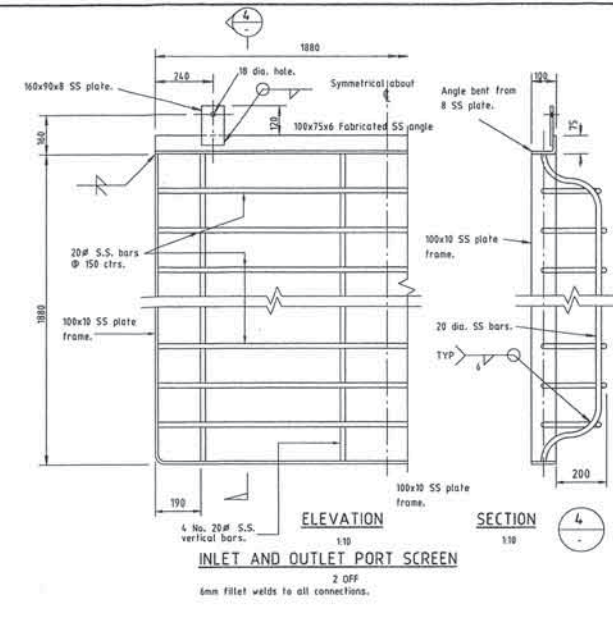
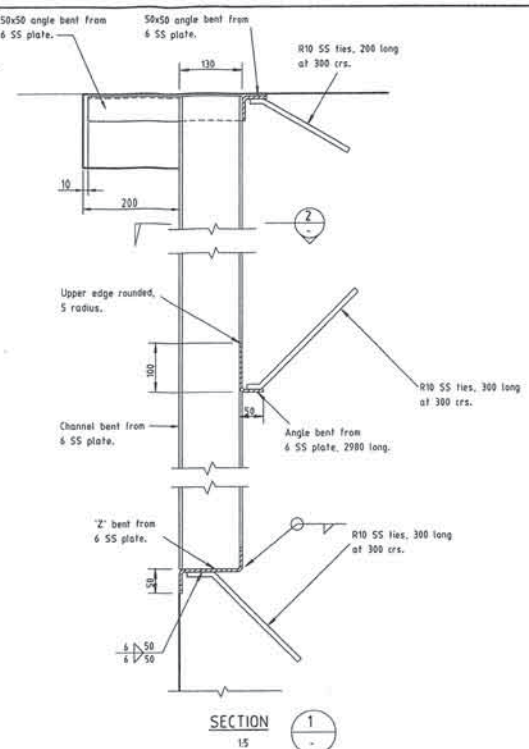
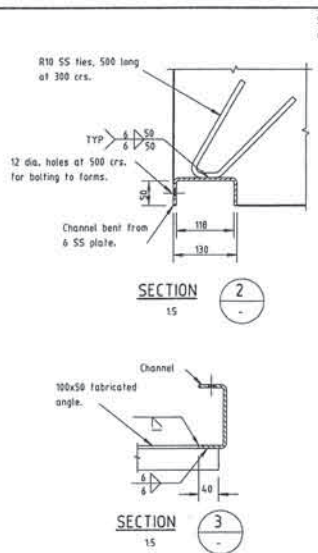
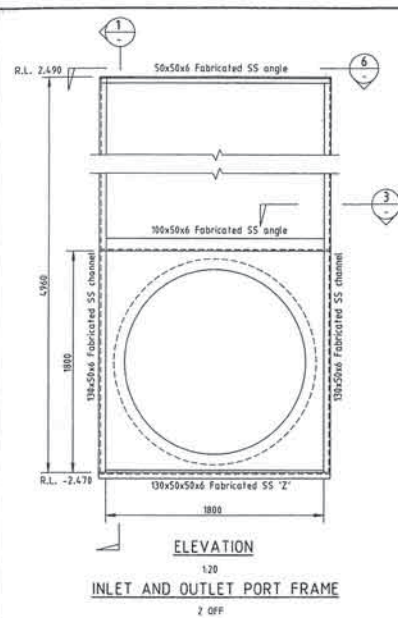


COVER TO WALLS W1-1 & W2-1
110
Cover to be hot dipped galvanised after fabrication

- NOTES**
1. Screen and port frame shall be constructed from Grade 316 stainless steel.
 2. All welds built with faces ground flush or fillet, all welds continuous unless shown otherwise.
 3. Bulkhead gate to be hot dip galvanised after fabrication.




AUTOCAD NAME: 499-27.WGS DATE: 12-10-1998 TIME: 13:38 AM		DESIGNED: <i>[Signature]</i>	DRAWN: <i>[Signature]</i>	CHECKED: <i>[Signature]</i>	RECOMMENDED: <i>[Signature]</i>	APPROVED: <i>[Signature]</i>	DATE: 12-10-1998	C&D Cardno & Davies Queensland Pty. Ltd. A/NZ 651 110 Consulting Engineers 88 Bourke Avenue, Macquarie Park Postal Address: PO Box 152 Macquarie Park, Queensland 4106	KAWANA ESTATES PTY. LTD. PARREARRA DEVELOPMENT STRUCTURE 2 LOCK WATER QUALITY BYPASS CHANNEL INLET AND OUTLET PORT SCREEN AND BULKHEAD GATE DETAILS	SHEET: 12-12-1998 DRAWING No: 478/95 - 27
NO.	DATE	REVISIONS	REC.	APPR.	BY	DATE	OFFICE: 011 951 1111 FAX: 011 951 1111 GPO Box 1111, Macquarie Park, NSW 1572 Telephone: 011 951 1111 Facsimile: 011 951 1111 Telex: 951111111 International Operator Service: 011 951 1111 88 Bourke Avenue, Macquarie Park, NSW 1572			

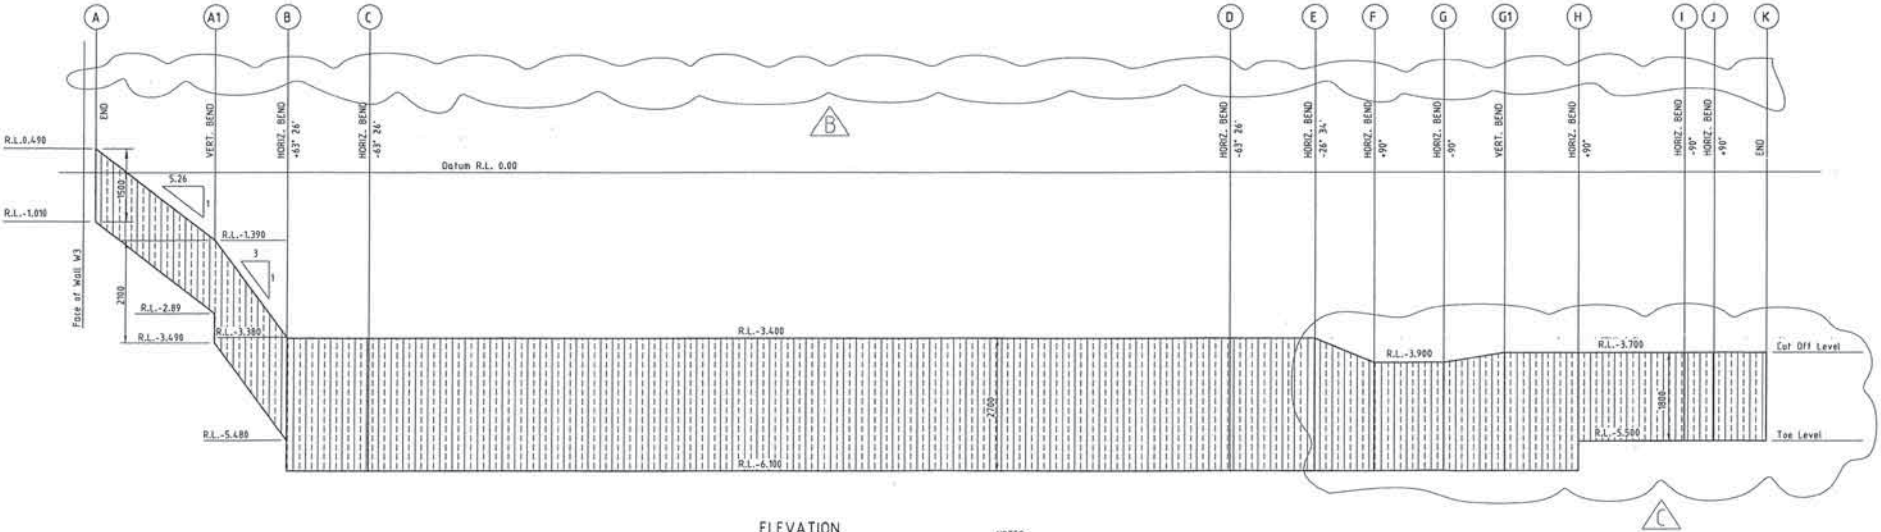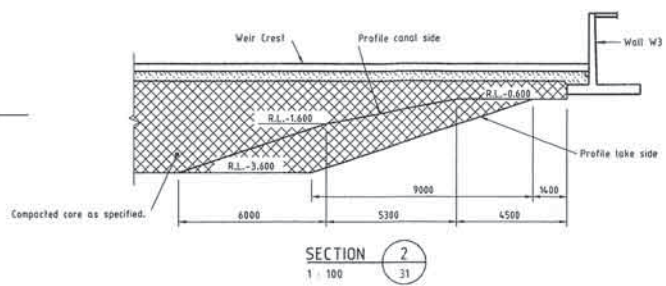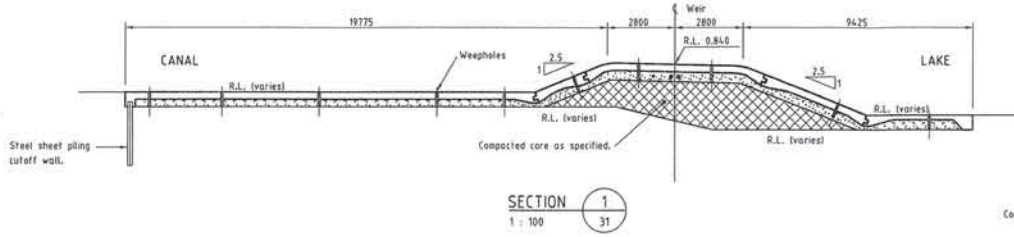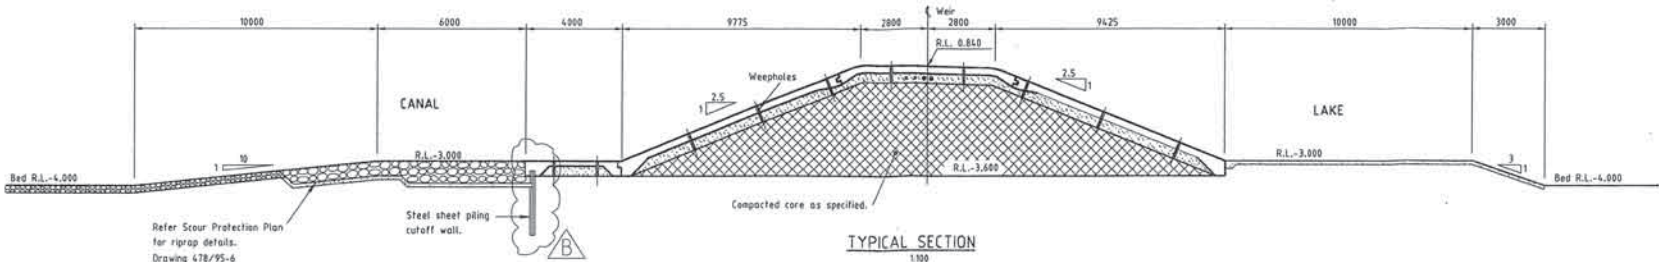

**ELEVATION
STEEL SHEET PILING**
HOR. 1:200
VERT. 1:50

NOTES:
1. Bends for steel sheet piling shall be prefabricated by cutting and welding of pile sections to suit.

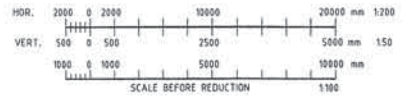

AUTOCAD NAME: KYS-21.DWG
DATE: 15-04-1997 10:13:10 PM

NO.	DATE	REVISIONS	REC. APPR.	DATE
C	25-08-97	Sheet piling levels revised		
B	04-05-97	Sheet piling moved 10mm		
A	11-04-97	General Revisions		

DESIGNED: PKM
DRAWN: C.J. [Signature]
CHECKED: SVC
RECOMMENDED: [Signature]
APPROVED: [Signature]



DATUM: A.H.D.

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Queensland Pty. Ltd.
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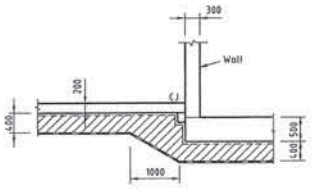
OFFICE	TELEPHONE	FAX
Brisbane	011 3208 9331	011 3208 9122
Gold Coast	011 3208 9331	011 3208 9122
Surabaya Coast	011 3208 9331	011 3208 9122
Perth	011 3208 9331	011 3208 9122
Wellington	011 3208 9331	011 3208 9122
Christchurch	011 3208 9331	011 3208 9122
Dunedin	011 3208 9331	011 3208 9122
Wellington	011 3208 9331	011 3208 9122
Wellington	011 3208 9331	011 3208 9122
Wellington	011 3208 9331	011 3208 9122

KAWANA ESTATES PTY. LTD.
PARREARRA DEVELOPMENT
STRUCTURE Z
WEIR STRUCTURE
SHEET PILING AND WEIR FILL PROFILES


DATE: 15-04-1997
DRAWING No: 478/95 - 29

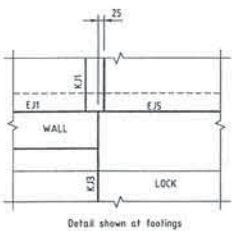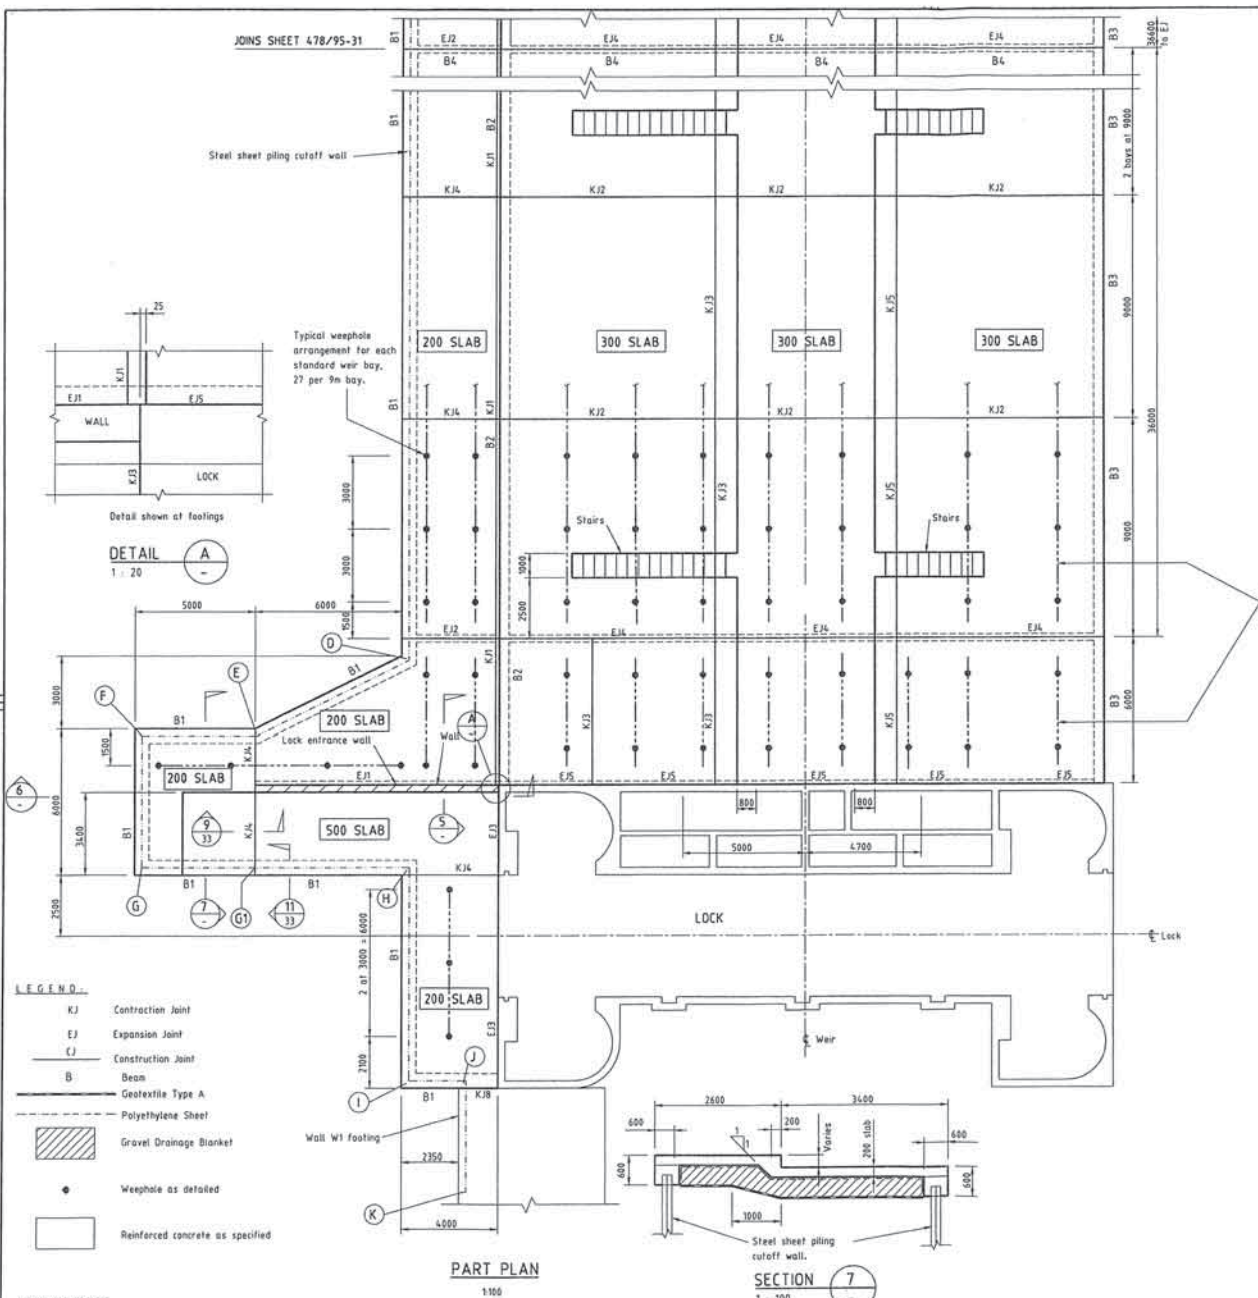

DETAIL A
1:20




SECTION 5
1:50

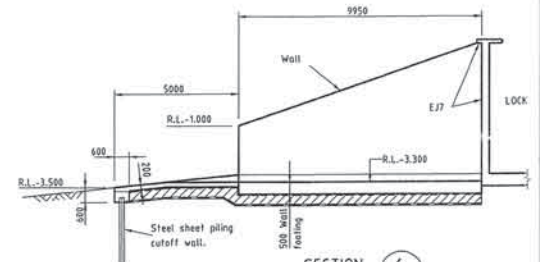

SECTION 6
1:100

NOTE: Refer dwg. 478/95-45 for reinforcement details.

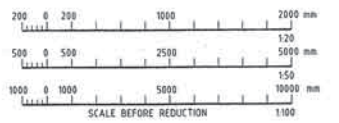

- LEGEND**
- K/J Contraction Joint
 - E/J Expansion Joint
 - C/J Construction Joint
 - B Beam
 - Geotextile Type A
 - Polyethylene Sheet
 - Gravel Drainage Blanket
 - Weephole as detailed
 - Reinforced concrete as specified

PART PLAN
1:100

SECTION 7
1:100

AUSCAD NAME: KYS-10.DWG
DATE: 11-10-97 TIME: 3:24 PM

NO.	DATE	REVISIONS	REC.	APPR.	DATE	REC.	APPR.
0	23-05-97	Cable all IS moved.					
1	25-08-97	Mark G1 added					
2	04-05-97	Bypass channel removed, Sheet Piling moved 100mm					
3	11-04-97	General Revisions					

DESIGNED: P.M.
DRAWN: C.P. Bag
CHECKED: S.C.
RECOMMENDED: M.W.
APPROVED: C.J. Hume
DATE: 11-10-97

DATUM: A1
A.H.D.

C&D Cardno & Davies
Queensland Pty. Ltd.
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OFFICES:
Brisbane
Gold Coast
Sunshine Coast
Townsville
Cairns
Darwin
Perth
Sydney
Melbourne
Auckland
Wellington
Christchurch
Dunedin






TELEPHONE:
07 551 7700
07 551 7701
07 551 7702
07 551 7703
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07 551 7710
07 551 7711
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07 551 7715
07 551 7716
07 551 7717
07 551 7718
07 551 7719
07 551 7720

FAX:
07 551 7721
07 551 7722
07 551 7723
07 551 7724
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07 551 7732
07 551 7733
07 551 7734
07 551 7735
07 551 7736
07 551 7737
07 551 7738
07 551 7739
07 551 7740

HEADQUARTERS OFFICE:
34 Queens Avenue, Manly/Burwood
Postal Address: PO Box 103
Manly/Burwood, Queensland 4155

KAWANA ESTATES PTY. LTD.
PARREARRA DEVELOPMENT
STRUCTURE 2
WEIR STRUCTURE
JOINTING PLAN AND DETAILS - SHEET NO.1

DATE: 5TH APRIL 1994
DRAWING No: 478/95-30

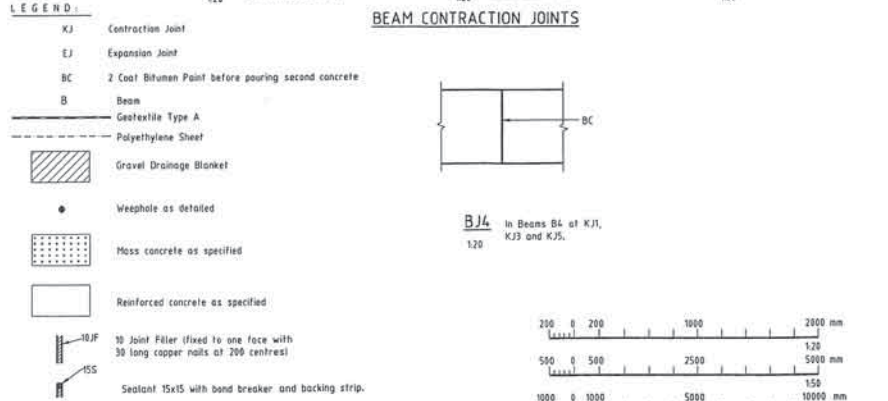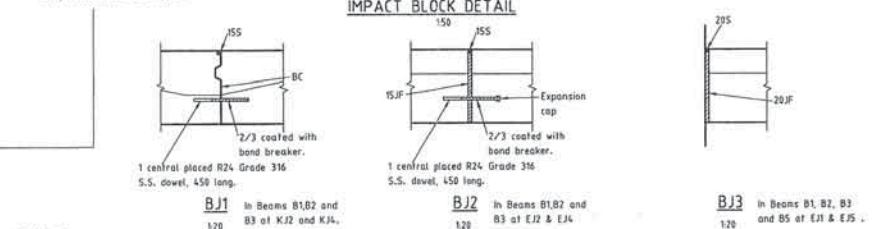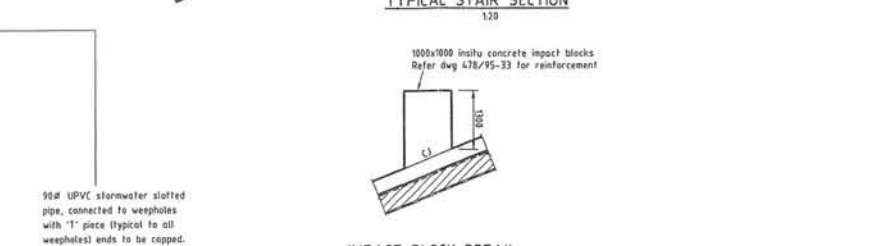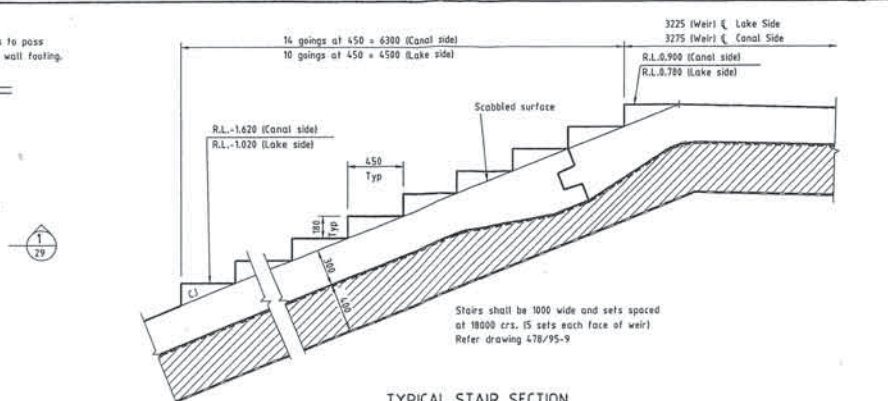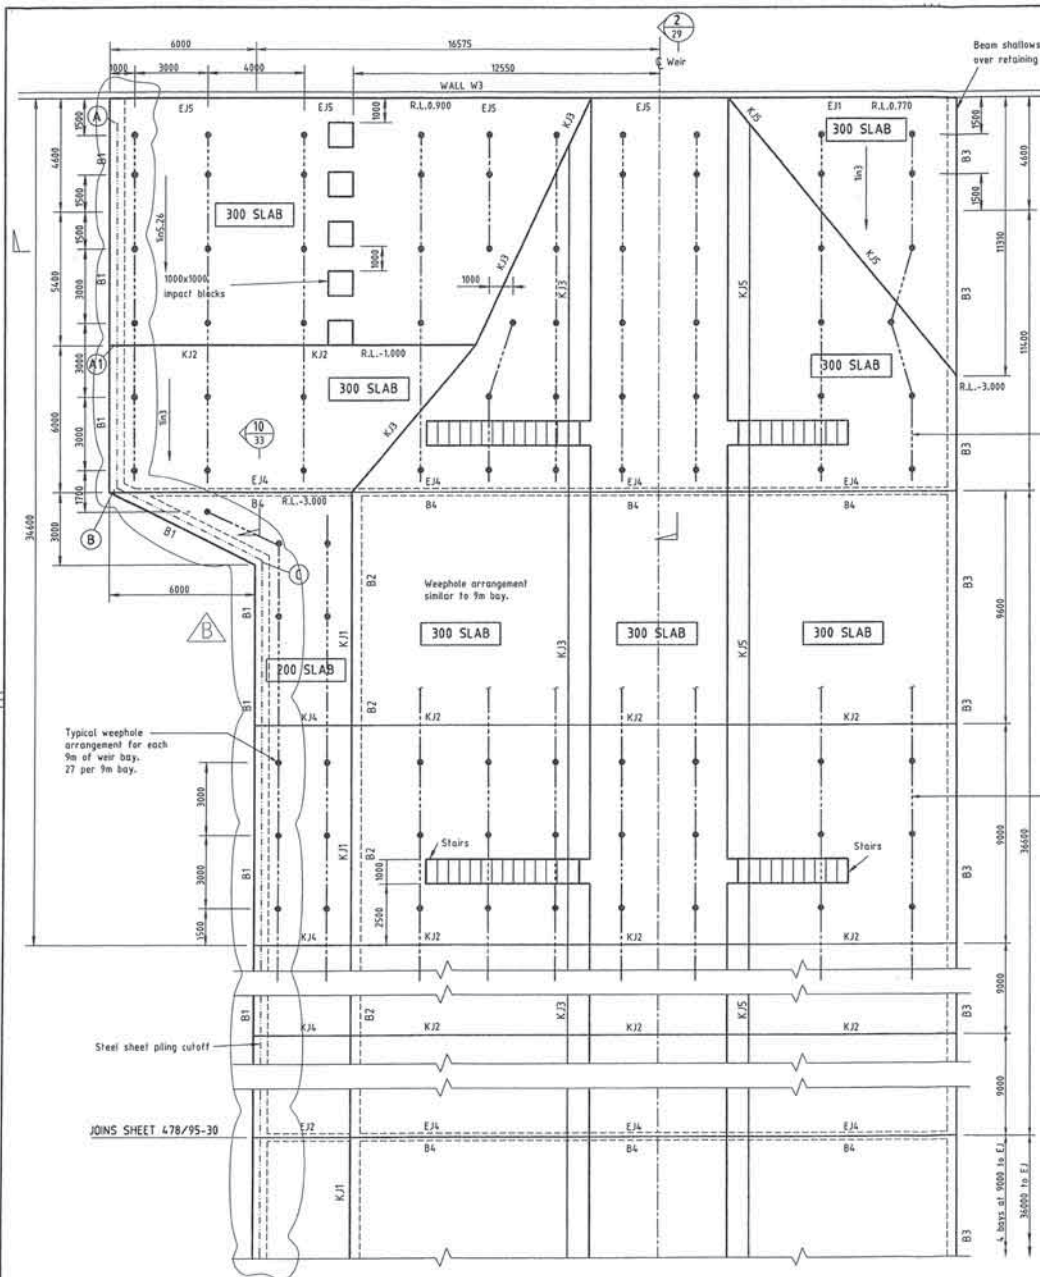

PART PLAN
1:100

AUTOCAD FILE: DWG1210.DWG
DATE: 3-1-1991 TIME: 1:58 PM

NO.	DATE	REVISIONS	REC.	APPR.	DATE
C	28-10-97	B/A added & Impact Block revised.			
B	6-05-97	Sheet Piling moved 150mm.			
A	11-04-97	General Revisions			



DESIGNED: <i>[Signature]</i>	DRAWN: <i>[Signature]</i>	CHECKED: <i>[Signature]</i>	RECOMMENDED: <i>[Signature]</i>	DATE: 11/04/97
APPROVED: <i>[Signature]</i>				DATE: 11/04/97

C&D **Cardno & Davies**
Queensland Pty. Ltd.
Consulting Engineers
204, 407, 476, 111






OFFICES:
Brisbane: 187 2348 9111
Gold Coast: 187 2348 9111
Sunshine Coast: 187 2348 9111
Tully: 187 2348 9111
Mackay: 187 2348 9111
Rockhampton: 187 2348 9111
Gungahlin: 187 2348 9111
Sydney: 187 2348 9111
Melbourne: 187 2348 9111
Perth: 187 2348 9111
Auckland: 187 2348 9111

KAWANA ESTATES PTY. LTD.
PARREARRA DEVELOPMENT
STRUCTURE Z
WEIR STRUCTURE
JOINING PLAN AND DETAILS - SHEET NO.2



DATE: 6TH APRIL 1994
478/95-31

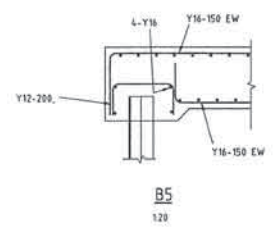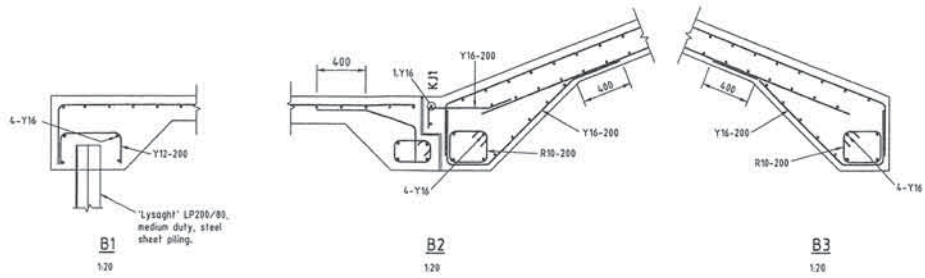


BEAM REINFORCEMENT

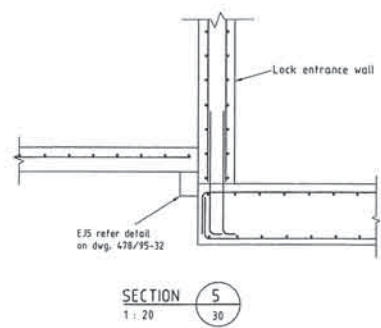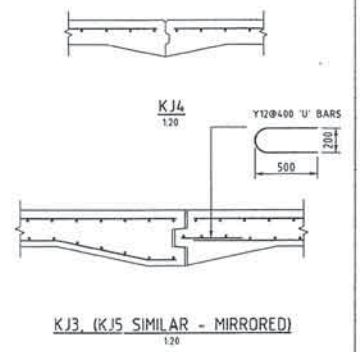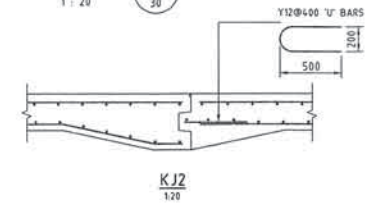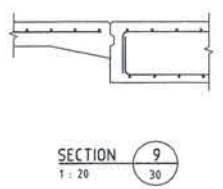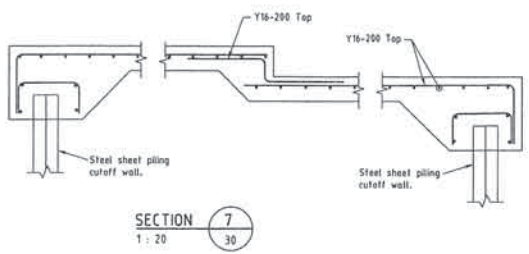

ALL REINFORCEMENT:
Y16-200 E.W. U.N.O
70 COVER U.N.O.

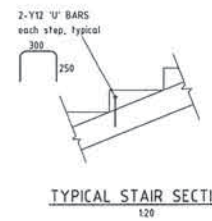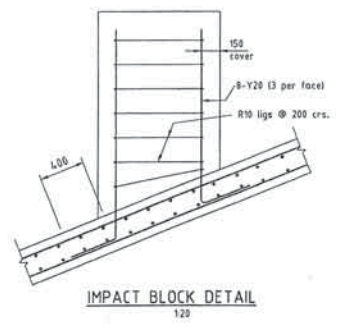

CONTRACTION JOINTS (KJ)

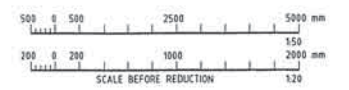

AUTOCAD RASTER/VECTOR/DWG DATE 28-11-1995 10:05:17

No.	DATE	REVISIONS	REC. APPR.	DATE	REC. APPR.
C	25-10-97	Impact block revised.			
D	23-09-97	Cable pit E/S omitted.			
C	15-05-97	Cover to Impact block amended			
B	08-05-97	Bypass channel removed, Sheet Piling moved 30mm			
A	11-04-97	General Revisions			

DESIGNED: *[Signature]*
DRAWN: *[Signature]*
CHECKED: *[Signature]*
RECOMMENDED:
PROJ. MGR. *[Signature]*
DATE: 28-11-95
A1 A.H.D.
APPROVED:
PROJ. MGR. *[Signature]*

C&D **Cardno & Davies**
Queensland Pty. Ltd.
Consulting Engineers


OFFICES:
Brisbane
Gold Coast
Maroochydore
Noosa
Parramatta
Perth
Sydney
Townsville
Wollongong

TELEPHONE:
017 554 9222
017 554 9222
017 554 9222
017 554 9222
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017 554 9222


FAX:
017 554 9222
017 554 9222
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KAWANA ESTATES PTY. LTD.
PARRARRA DEVELOPMENT
STRUCTURE Z
WEIR STRUCTURE
REINFORCEMENT DETAILS


DATE: 28-11-1995
DRAWING No: **478/95 - 33**

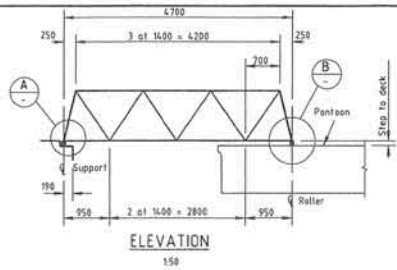


ELEVATION
150

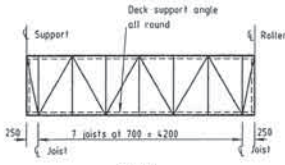


PLAN
150

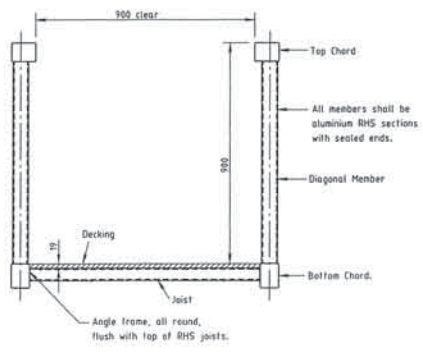


TYPICAL SECTION
110

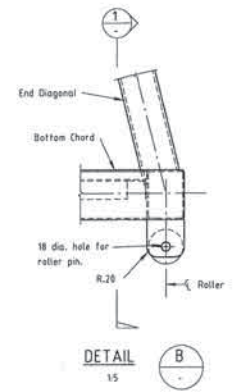


DETAIL
15

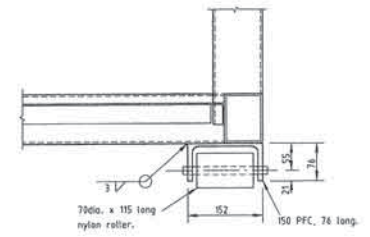

SECTION
15

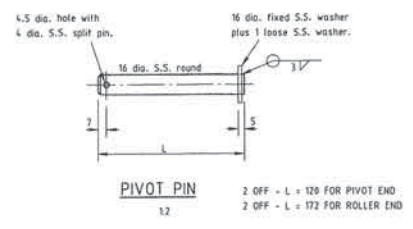

PIVOT PIN
12
2 OFF - L = 120 FOR PIVOT END
2 OFF - L = 172 FOR ROLLER END

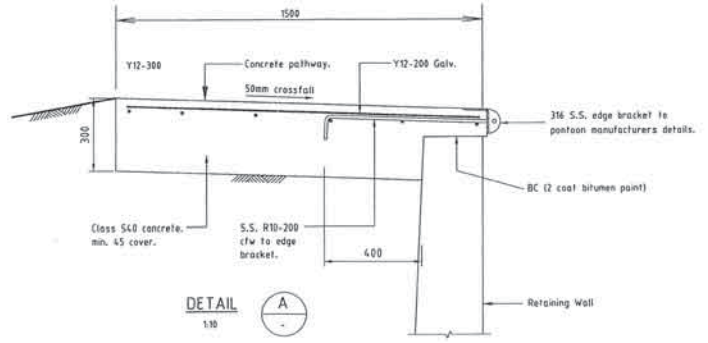

DETAIL
130

- NOTES**
- Gangway shall be fabricated from aluminium alloy 6061-T6.
 - All welds shall be 3mm continuous fillet using filler alloy 535A.
 - All butt welds shall be full penetration.
 - All stainless steel shall be Grade 316.
 - Decking to gangway shall be 19 thick sealed marine plywood with non-slip rubber sheeting surface fixed to frame with 4mm S.S. countersunk screws at 150 centres.



GANGWAY DESIGN LIVE LOAD :
4.0 kPa DISTRIBUTED
4.5 kN CONCENTRATED

AUSTROAD NAME: 478-35/95
DATE: 0-10-1998 BY: 528 BH

DATE	REVISIONS	REC. APPR. BY	DATE	REC. APPR.
	B 03-03-98 Detail A revised			
	A 11-04-97 General Revisions			


DESIGNED: <i>[Signature]</i>	DATUM: A.H.D.
DRAWN: <i>[Signature]</i>	
CHECKED: <i>[Signature]</i>	
RECOMMENDED: <i>[Signature]</i>	
APPROVED: <i>[Signature]</i>	

C&D **Cardno & Davies**
Queensland Pty. Ltd.
CONSULTING ENGINEERS


OFFICES:
Brisbane 081 554 9111
Gold Coast 081 554 9111
Townsville 081 554 9111
Cairns 081 554 9111
Hervey Bay 081 554 9111
Parramatta 081 554 9111
Port Moresby 081 554 9111
SPECIALIST CONSULTANTS:
68 Dufferin Street, Mandurah WA
Postal Address: PO Box 532
Mandurah, Queensland 4655

KAWANA ESTATES PTY. LTD.
PARREARRA DEVELOPMENT
STRUCTURE 2
FLOATING PONTOON GANGWAY DETAILS


DATE: 12-12-1998
DRAWING NO: **478/95 - 35**

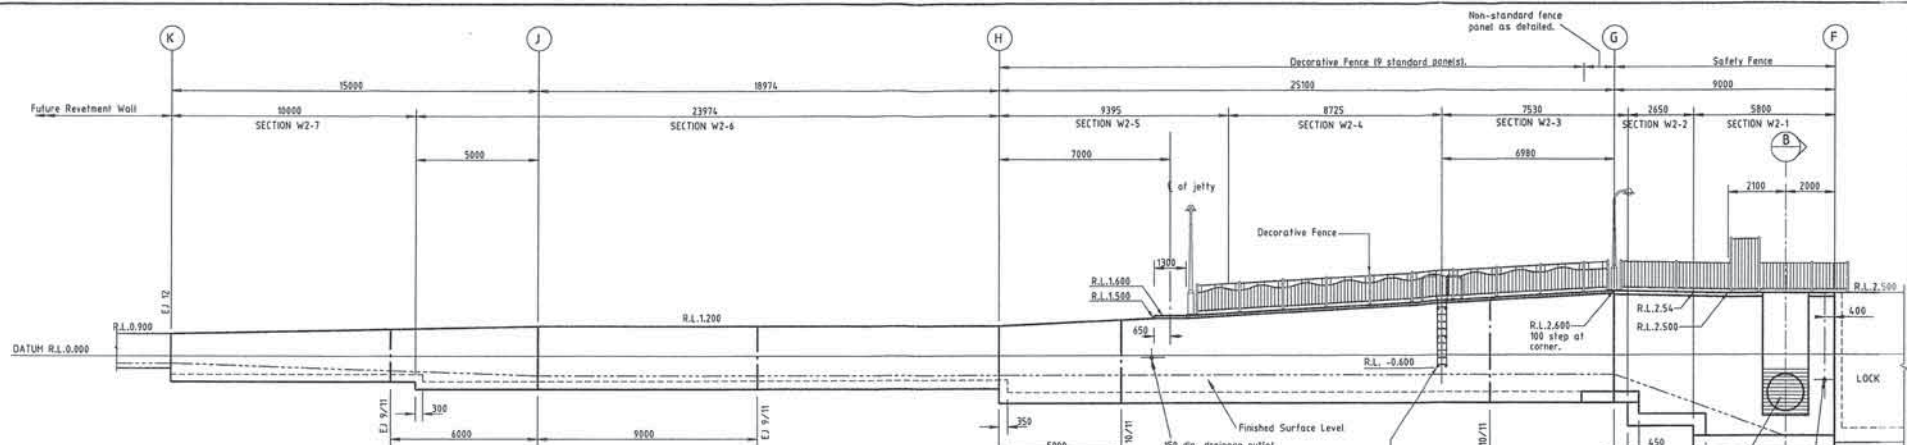

ELEVATION
1:100
(Weepholes not shown)

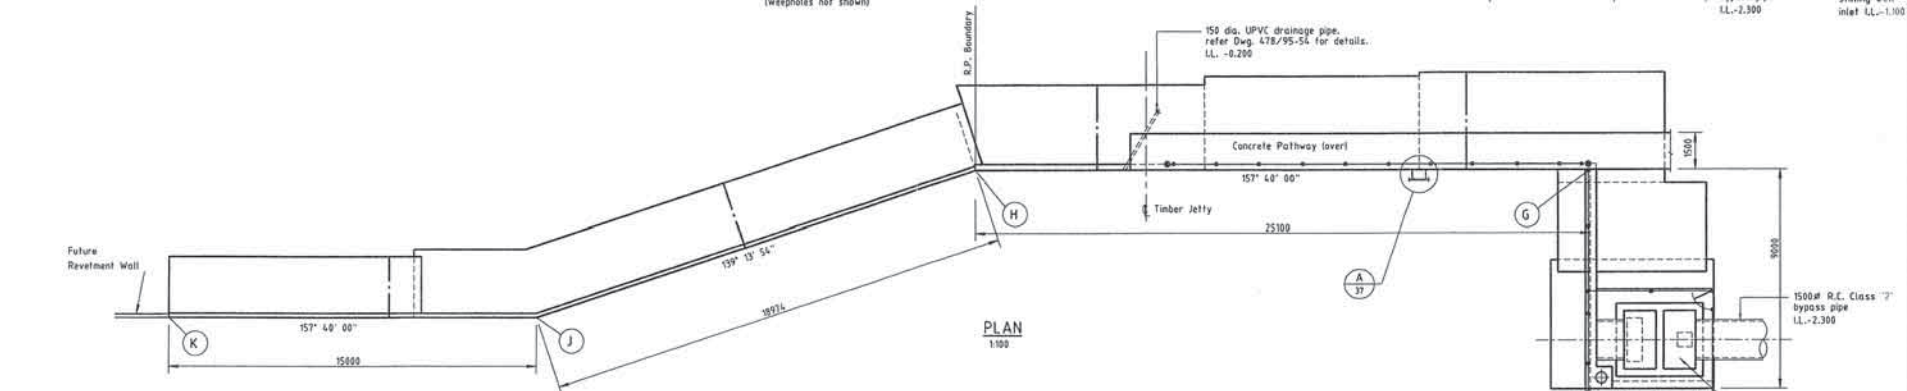


PLAN
1:100

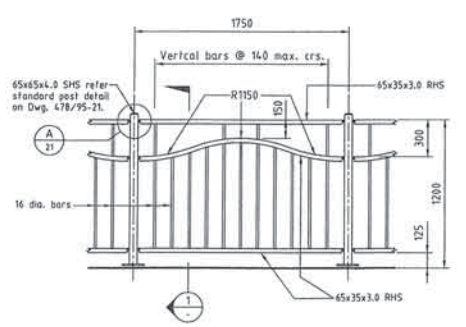


DECORATIVE FENCE (Standard Panel)
1:20

All posts and bars are to be vertical. Rails are to be sloped to match wall profile.

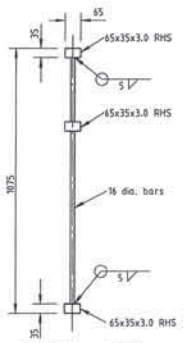


SECTION
1:100

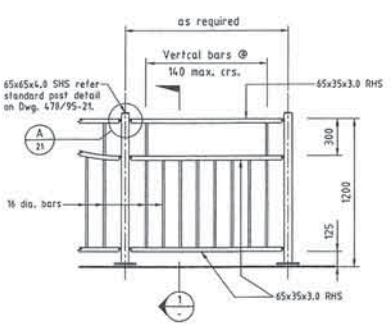

DECORATIVE FENCE (Non-standard Panel)
1:20

NOTE: All fence setout dimensions to be verified on site prior to the commencement of fabrication.

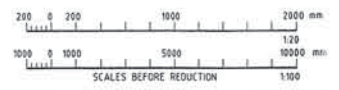

AUTOCAD NAME: K11-18.DWG
DATE: 12-12-1995 TIME: 10:10 PM

NO.	DATE	REVISIONS	REC.	APPR.	DATE	REC.	APPR.
C	02-07-98	Fences & Levels to top of walls revised					
B	06-05-97	Bypass pipe added, Ladder added.					
A	11-24-97	General Revisions					


DESIGNED: <i>[Signature]</i>	CHECKED: <i>[Signature]</i>	RECOMMENDED: <i>[Signature]</i>	DATE: 12-12-95
DRAWN: <i>[Signature]</i>	CHECKED: <i>[Signature]</i>	RECOMMENDED: <i>[Signature]</i>	DATE: 12-12-95
DATE: 12-12-95	DATE: 12-12-95	DATE: 12-12-95	DATE: 12-12-95

C&D **Cardno & Davies**
Queensland Pty. Ltd.
Consulting Engineers


OFFICES:
Brisbane: (07) 3281 8122
Gold Coast: (07) 5461 9222
Lismore Coast: (07) 5461 9222
Maryborough: (07) 5461 9222
Newcastle: (07) 5461 9222
Parramatta: (07) 5461 9222
Sydney: (07) 5461 9222
Townsville: (07) 5461 9222
Wollongong: (07) 5461 9222

KAWANA ESTATES PTY. LTD.
PARREARRA DEVELOPMENT
STRUCTURE 2
RETAINING WALLS - WALL W2
PLAN AND ELEVATION


DATE: 12-12-1995
DRAWING NO: **478/95 - 38**

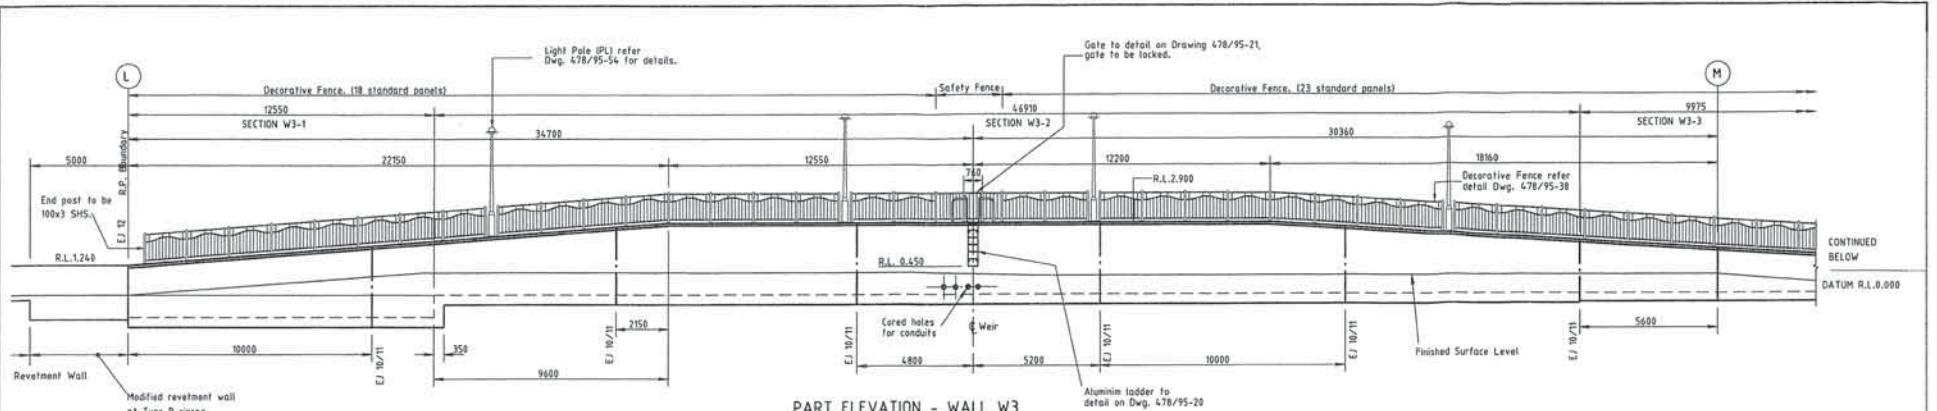


PART ELEVATION - WALL W3
1:100
(Weepholes not shown)

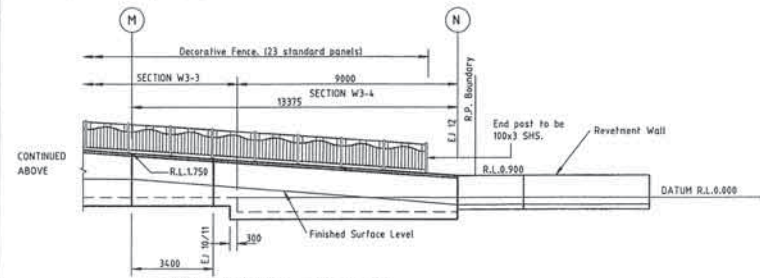


PART ELEVATION - WALL W3
1:100
(Weepholes not shown)

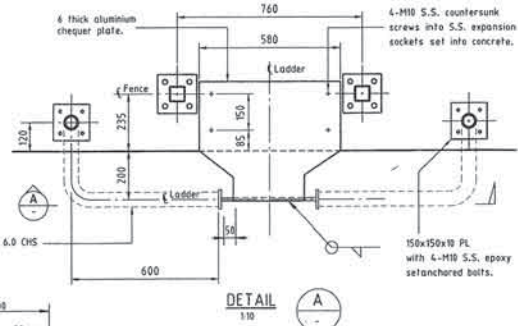


DETAIL A
1:100

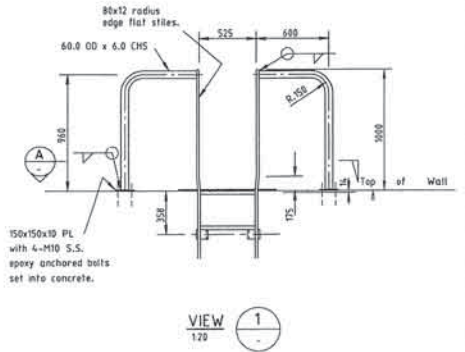

VIEW 1
1:120

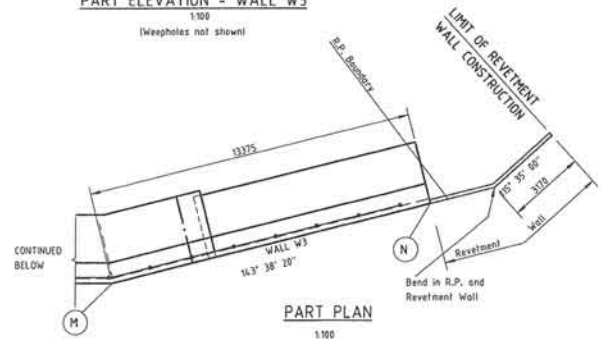


PART PLAN
1:100

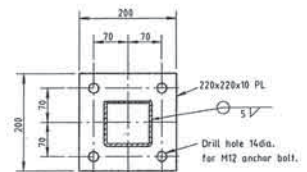

BASE PLATE TO 100 SHS END POST
(Walls W3-1 & W3-4)
1:15

NOTE: All fence setout dimensions to be verified on site prior to the commencement of fabrication.

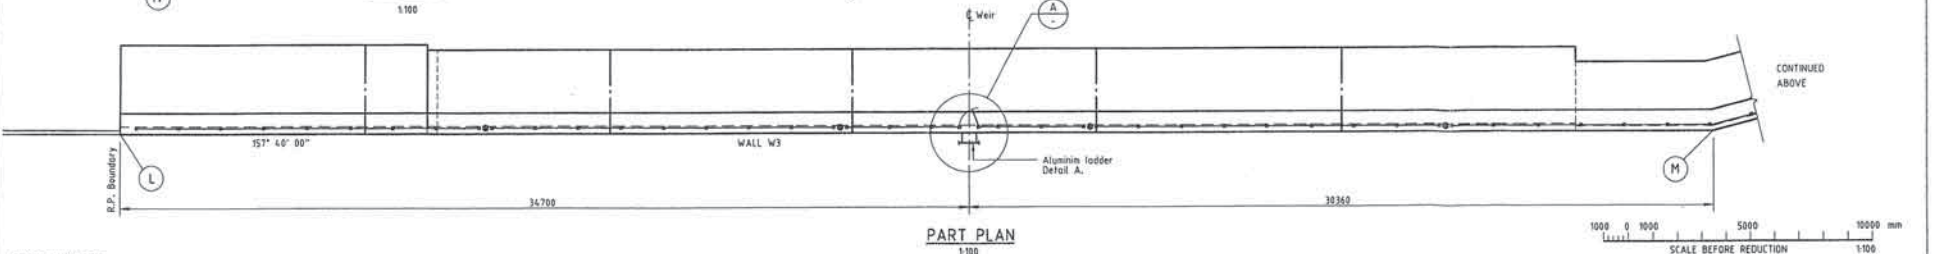

PART PLAN
1:100

SCALE BEFORE REDUCTION
1:100

AUTOCAD NAME: 478-29/95
DATE: 10-10-1994 TWC: 155 mm

NO.	DATE	REVISIONS	REC.	APPR.	BY	DATE
1	02-02-98	Fences to top of wall revised.				
2	23-09-97	Wall finished level revised.				
3	18-05-97	Ladder & Safety fence added.				
4	11-04-97	General Revisions.				

DESIGNED: *P. H. H.*
DRAWN: *C. J. H.*
CHECKED: *[Signature]*
RECOMMENDED: *[Signature]*
PROJ. MGR: *[Signature]*
APPROVED: *[Signature]*


A1 DATUM: **A.H.D.**

C&D **Cardno & Davies**
Queensland Pty. Ltd.
5th Floor, 111
Consulting Engineers


OFFICES: TELEPHONE: FAX:
Brisbane (07) 339 9111 (07) 339 9112
Gold Coast (07) 544 9111 (07) 544 9112
Cairns (07) 544 9111 (07) 544 9112
Darwin (08) 251 1111 (08) 251 1112
Hwy 1 (07) 544 9111 (07) 544 9112
Townsville (07) 544 9111 (07) 544 9112
Central QLD (07) 544 9111 (07) 544 9112
88 South Street, Mackay
Postal Address: PO Box 123
Mackay, Queensland 4740

KAWANA ESTATES PTY. LTD.
PARREARRA DEVELOPMENT
STRUCTURE 2
RETAINING WALLS - WALLS W3
PLANS AND ELEVATIONS


DATE: 12-12-1996
DRAWING No: **478/95 - 39**

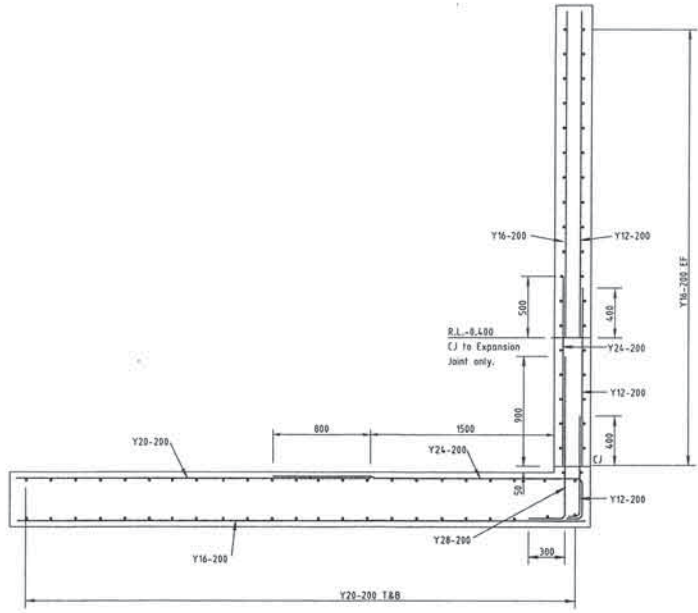


WALL W1-3
120

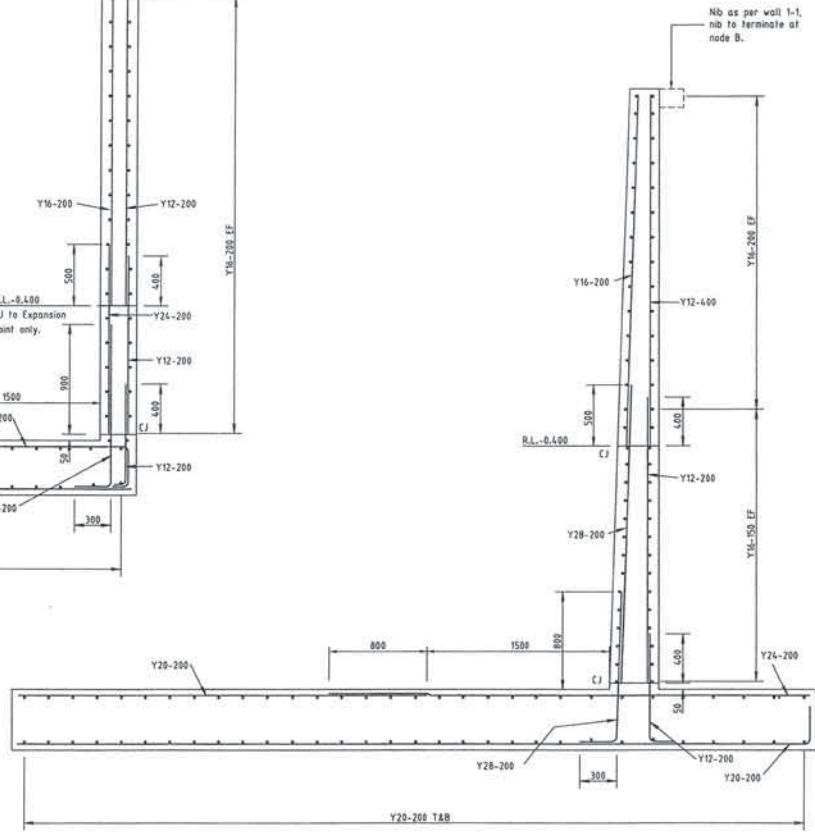

WALL W1-2
120

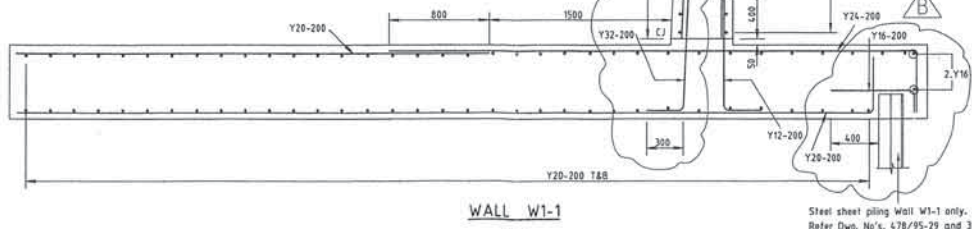


WALL W1-1
120

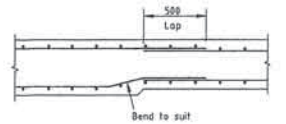

**STEP IN FOOTING AT
W1-3 TO W1-4 AND
W2-3 TO W2-4**



Steel sheet piling wall W1-1 only.
Refer Dwg. No's. 478/95-29 and 31
for limit of steel sheet piling.

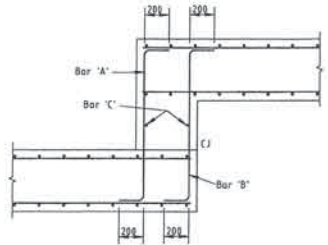

FOOTING STEP DETAIL
NOT TO SCALE

STEP IN FOOTING AT JUNCTION OF WALLS	BAR'S 'A'	BAR'S 'B'	BAR'S 'C'
W1-1 to W1-2	Y20-200	Y20-200	Y16
W1-2 to W1-3	Y20-200	Y20-200	Y16
W1-6 to W1-7	Y16-200	Y16-200	Y16
W1-7 to W1-8	Y16-250	Y16-250	Y16
W1-8 to W1-9	Y16-250	Y16-250	Y16
W2-1 to W2-2	Y12-250	Y12-250	Y12
W2-2 to W2-3	Y12-250	Y12-250	Y12
W3-1 to W3-2	Y12-300	Y12-300	Y12
W3-3 to W3-4	Y12-300	Y12-300	-

AUTOCAD NAME: XIS-L1000
DATE: 18-09-95 TIME: 10:33:00

DATE	REVISIONS	REC.	APPR.	DATE	REC.	APPR.
	D 16-10-97					
	C 05-05-97					
	B 11-04-97					
	A 11-12-96					

DESIGNED: *[Signature]*
DRAWN: *[Signature]*
CHECKED: *[Signature]*
RECOMMENDED: *[Signature]*
DATE: 12-12-1996


DATUM: A1
A.H.D.
APPROVED: *[Signature]*
PROJECT: *[Signature]*

C&D Cardno & Davies
Queensland Pty. Ltd.
A/C 811 ST. HI
Consulting Engineers

OFFICES: TELEPHONE: FAX:
Brisbane 081 238 9111 081 238 9112
Gold Coast 081 238 9111 081 238 9112
Hervey Bay 081 238 9111 081 238 9112
Maryborough 081 238 9111 081 238 9112
Newcastle 081 238 9111 081 238 9112
Port Macquarie 081 238 9111 081 238 9112
Sydney 081 238 9111 081 238 9112
Wollongong 081 238 9111 081 238 9112


KAWANA ESTATES PTY. LTD.
PARREARRA DEVELOPMENT
STRUCTURE Z
RETAINING WALLS
REINFORCEMENT DETAILS - SHEET No. 1

DATE: 12-12-1996
DRAWING No: 478/95 - 41

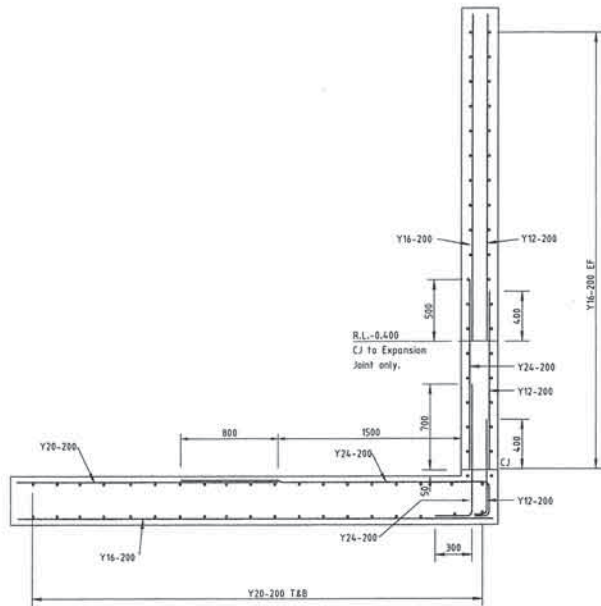


WALL W2-3

120

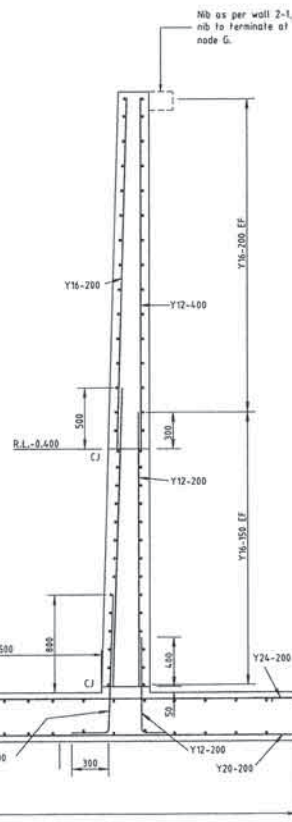


WALL W2-2

120

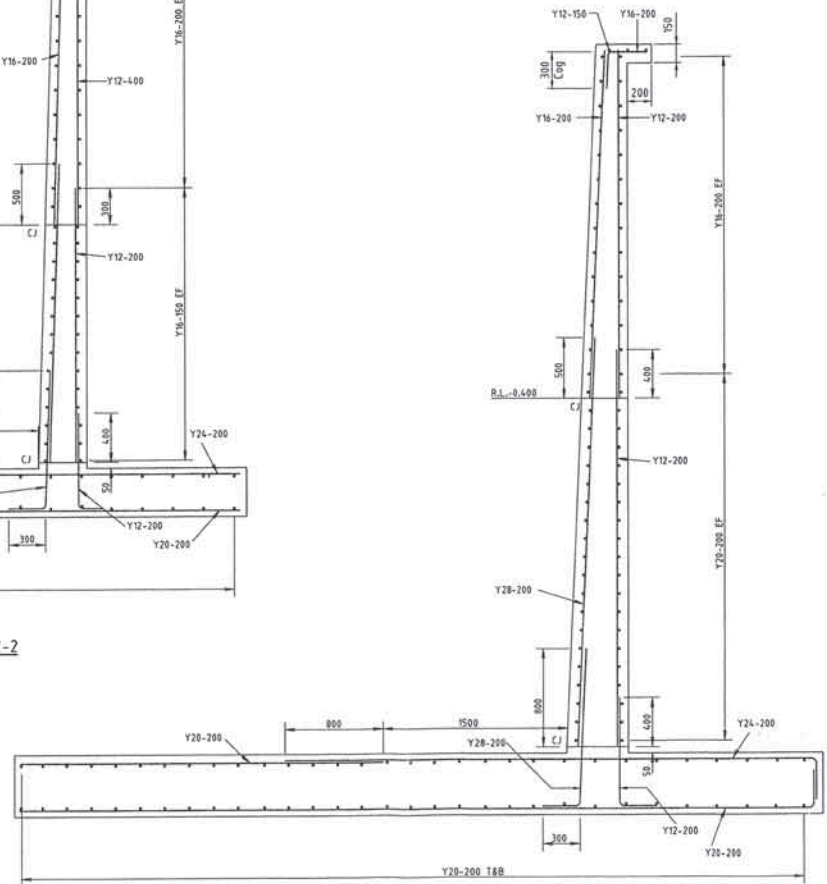

WALL W2-1

120

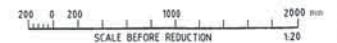

AUTOCAD NAME: K15-11195
DATE: 16-04-1997 TIME: 10:58 AM

NO.	DATE	REVISIONS	REC.	APPR.	BY	DATE	REC.	APPR.
D	03-04-98	R.L. nb added to Walls W2-1 & W2-2						
C	08-05-97	Sheet along removed from wall 2-1						
B	15-04-97	General Revisions						
A	11-12-96	Revised Drawing Issues						


DESIGNED: *[Signature]*
DRAWN: *[Signature]*
CHECKED: *[Signature]*
RECOMMENDED: *[Signature]*
DATE: 16-04-1997
APPROVED: *[Signature]*
A1
A.H.D.

C&D Cardno & Davies
Queenston Pty. Ltd.
101, 103, 105, 107
Consulting Engineers


OFFICES: TEL/FAX/PHONE:
Brisbane 081 239 9172
Gold Coast 081 239 9173
Darling Downs 081 239 9174
Toowoomba 081 239 9175
Murray Hill 081 239 9176
Port Kennedy 081 239 9177
Central QLD 081 239 9178
88 South Street, Mackay
Postal Address: PO Box 112
Mackay, Queensland 4740

KAWANA ESTATES PTY. LTD.
PARREARRA DEVELOPMENT
STRUCTURE 2
RETAINING WALLS
REINFORCEMENT DETAILS - SHEET No. 2


DATE: 12-02-1997
DRAWING No: 478/95 - 42

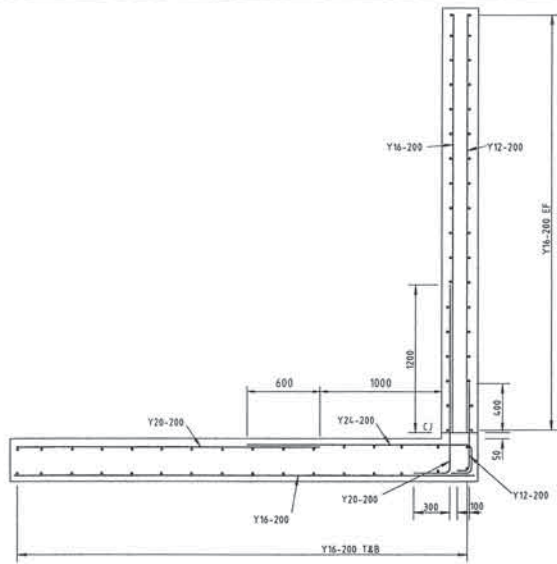


WALL W1-4
120
WALL W2-4 SIMILAR

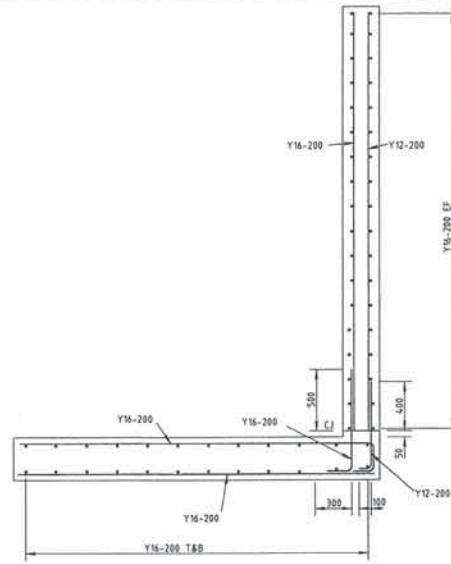


WALL W1-6
120

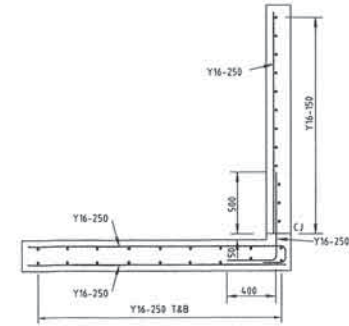


WALL W1-8
120
WALLS W1-7 AND W1-9 SIMILAR
WALL W2-7 SIMILAR
WALLS W3-3 AND W3-4 SIMILAR

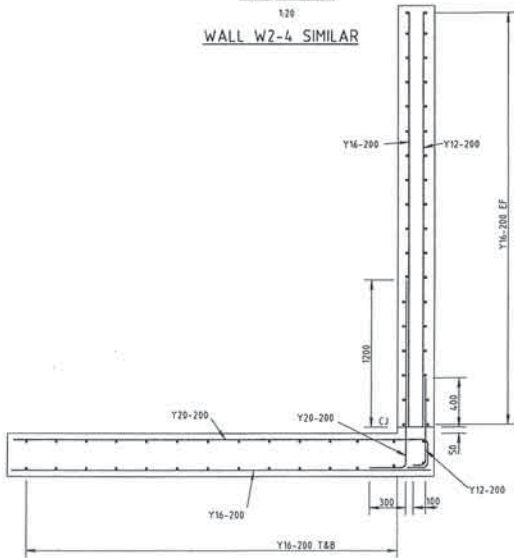

WALL W1-5
120
WALL W2-5 SIMILAR
WALLS W3-1 & W3-2 SIMILAR

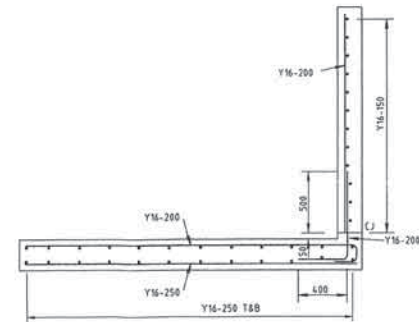

WALL W2-6
120

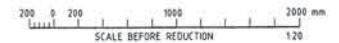

AUTOCAD NAME: Y16-LEADS
DATE: 16-12-95 TIME: 10:55:30 AM

NO.	DATE	REVISIONS	REC.	APPR.	DATE	REC.	APPR.
1							
2	06-05-93	STEERING WALL DETAIL MOVED TO DWG. 478/95-50					
3	11-04-97	General Revisions					
4	11-12-96	Revised Drawing Issue					


DESIGNED: <i>A.H.D.</i>	DRAWN: <i>C.P. Davis</i>	CHECKED: <i>S.G.</i>	RECOMMENDED: <i>A.H.D.</i>	PROJ. MGR: <i>A.H.D.</i>	APPROVED: <i>A.H.D.</i>	PROJ. CHG: <i>A.H.D.</i>
DATE: 16-12-95						

C&D Cardno & Davies
Queensland Pty. Ltd.
SIN 80 651 911
Consulting Engineers

OFFICES	TELEPHONE	FACX
Brisbane	(07) 558 9111	(07) 554 1212
Gold Coast	(07) 558 9112	(07) 558 9413
Surfers Paradise	(07) 558 9113	(07) 558 9414
Rockhampton	(07) 558 9114	(07) 558 9415
Port Moresby	(07) 558 9115	(07) 558 9416
Head Office	(07) 558 9116	(07) 558 9417
Port Moresby	(07) 558 9117	(07) 558 9418
Head Office	(07) 558 9118	(07) 558 9419

KAWANA ESTATES PTY. LTD.
PARREARRA DEVELOPMENT
STRUCTURE Z
RETAINING WALLS
REINFORCEMENT DETAILS - SHEET No. 3

Date: 12-12-1995
Drawing No: 478/95 - 43

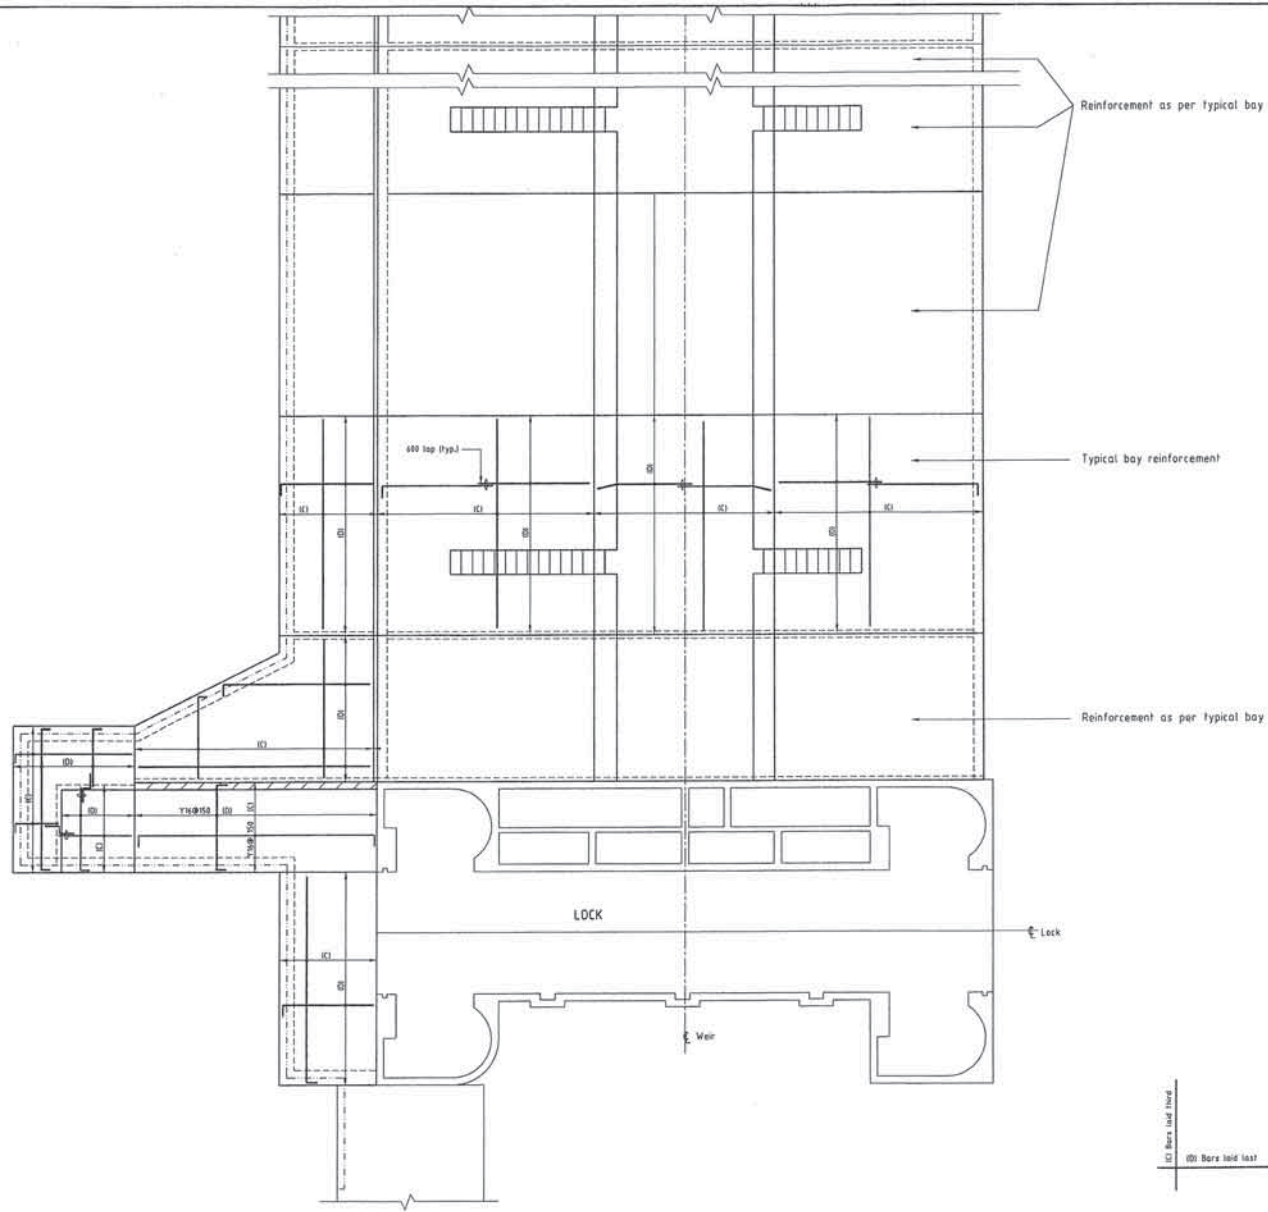

Reinforcement as per typical bay

Typical bay reinforcement

Reinforcement as per typical bay

400 lap (typ.)

LOCK

Lock

Weir

(C) Bars laid first
(D) Bars laid last

All reinforcement to be Y16@200 E.W. U.N.O.

PART PLAN
1:100

1000 0 1000 5000 10000 mm
SCALE BEFORE REDUCTION 1:100

DATE	REVISIONS	REV.	APPR.	DATE	REV.	APPR.
	B 23-05-97					
	A 6-05-97					

DESIGNED: PKM
DRAWN: C. J. Blay
CHECKED: S.C.
RECOMMENDED:
PROJ. MGR.:
D. J. Newman

DATUM:
A1
A.H.D.
APPROVED:
PROJ. MGR.:
D. J. Newman


C&D Cardno & Davies
Queensland Pty. Ltd.
Consulting Engineers

OFFICE: Brisbane
Gold Coast
Townsville
Cairns
Darwin
SUNSHINE COAST OFFICE:
48 Beach Road, Manly
Postal Address: PO Box 122
Manly, Queensland 4158


KAWANA ESTATES PTY. LTD.
PARREARRA DEVELOPMENT
STRUCTURE 2
WEIR STRUCTURE
TOP REINFORCEMENT DETAILS - SHEET No. 1

DATE: 13-02-1997
DRAWING No: 478/95 - 48

1	B
2	C
3	D

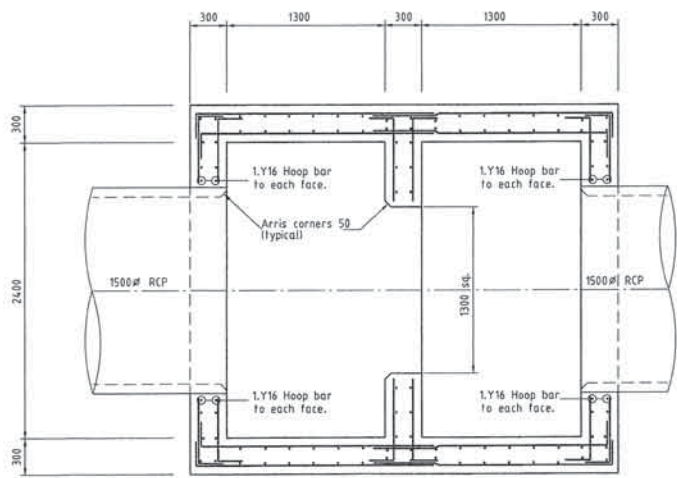

SECTION C
1:20

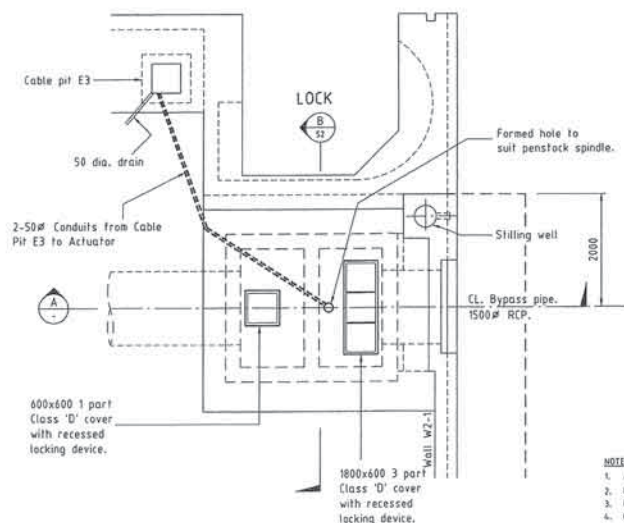


LAYOUT PLAN
1:50

All reinforcement to be Y16@200, all laps to be 400mm and cogs to be 300mm U.N.O., 70mm min. cover to all reinforcement. Provide starter bars to match vertical reinforcement, lap 500.

R.C. Pipes to Bypass Conduit are not to be cut. (Specials are to be manufactured if required.)


- NOTES:
- All dimensions to be checked by the Contractor before fabrication and construction. DIMENSIONS SHALL NOT BE SCALED.
 - During construction the structure shall be maintained in a stable condition and no part shall be overstressed.
 - No penetrations, chases or temporary features are permitted without prior approval of the Superintendent.
 - Concrete to be Class 50 as specified.
 - No construction joints, other than those shown on the drawings, shall be used without the approval of the Superintendent.

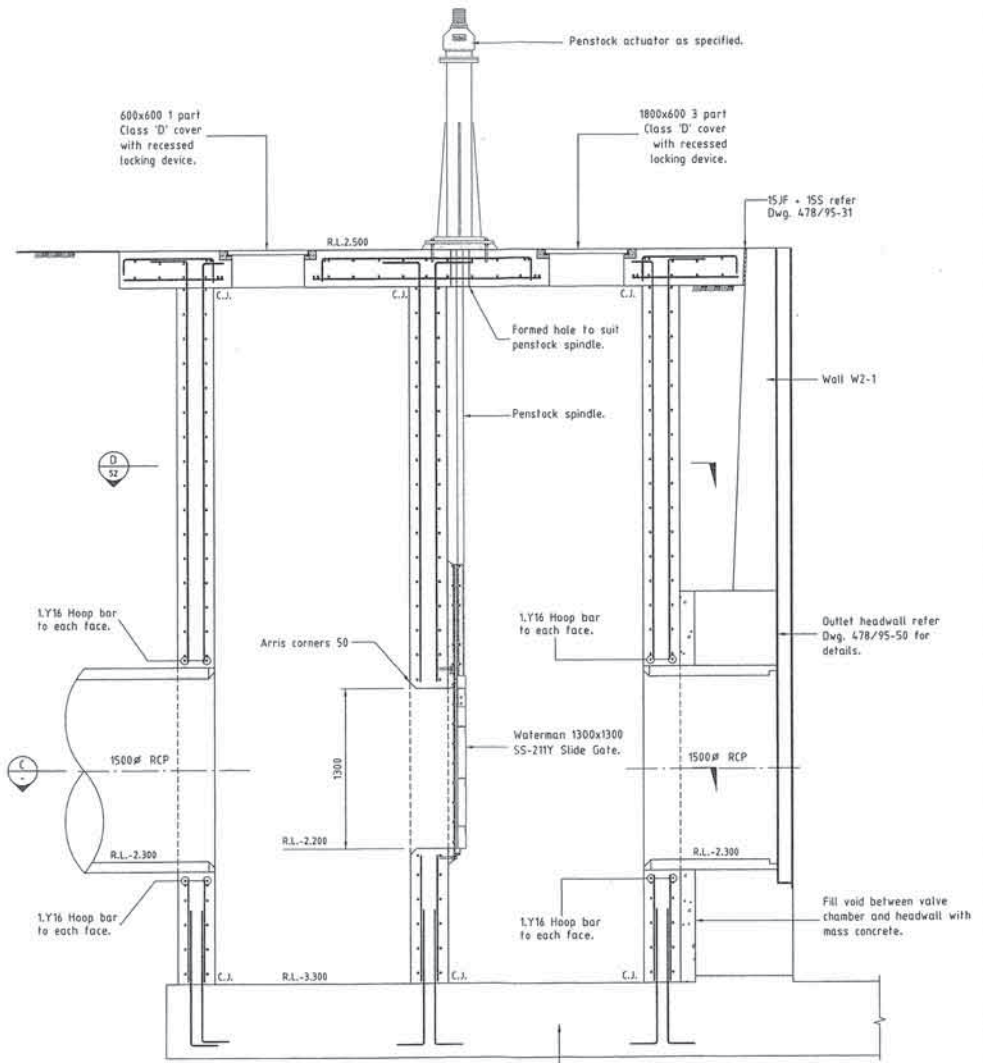

SECTION A
1:20




DESIGNED: <i>[Signature]</i>	CHECKED: <i>[Signature]</i>	DATE: A1	A.H.D.	Cardno & Davies Queensland Pty. Ltd. 201, 203, 205 Consulting Engineers	OFFICES: Brisbane 071 234 9111 Gold Coast 071 234 9111 Darling Downs 071 234 9111 Mackay 071 234 9111 North Queensland 071 234 9111 Townsville 071 234 9111 Cairns 071 234 9111 Port Moresby 091 161 1111 SUVA 091 161 1111 SUVA 091 161 1111	KAWANA ESTATES PTY. LTD. PARREARRA DEVELOPMENT STRUCTURE 2 BYPASS VALVE CHAMBER LAYOUT PLAN AND SECTIONS	DATE: 23-12-1997 DRAWING NO: 478/95-51
REVISIONS: A. 27-03-98 Cable pit E3 moved to lock cover slab.	REC. APPROV. <i>[Signature]</i>	DATE:	DATE:		PROJECT NO.	DRAWING DATE:	DRAWING NO.

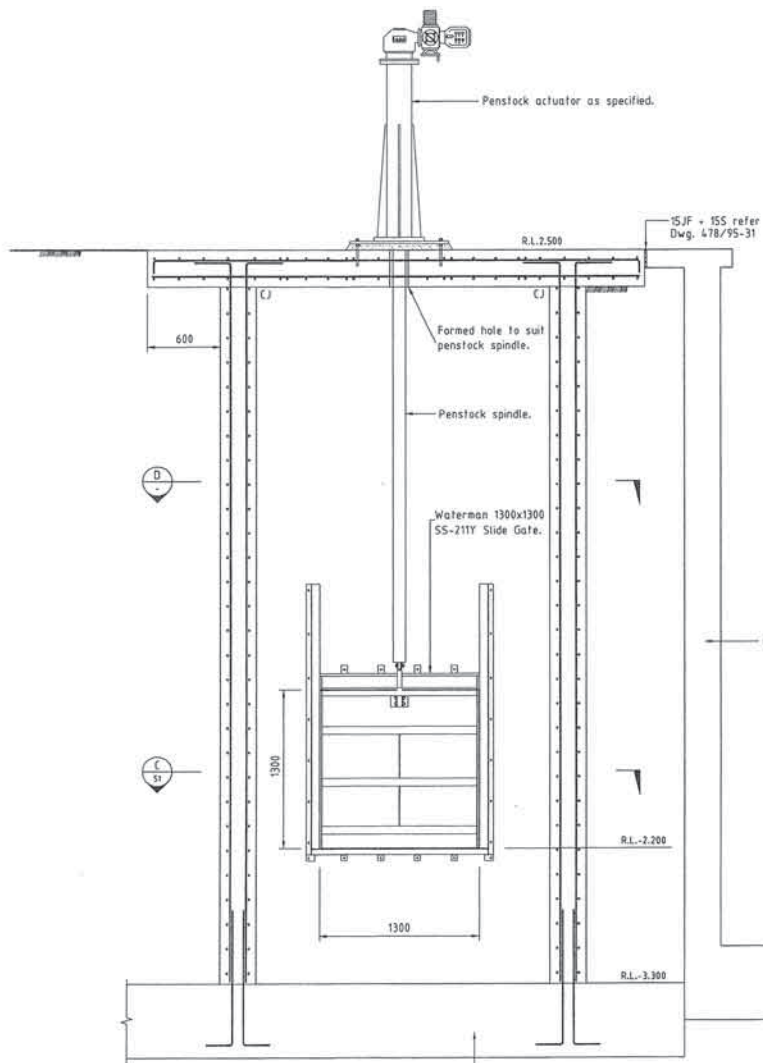


Wall W2-1 footing, refer Dwg. 478/95-42 for details.

SECTION B
1 : 20

All reinforcement to be Y16@200, all laps to be 400mm and cogs to be 300mm U.N.D., 70mm min. cover to all reinforcement. Provide starter bars to match vertical reinforcement, lap 500.

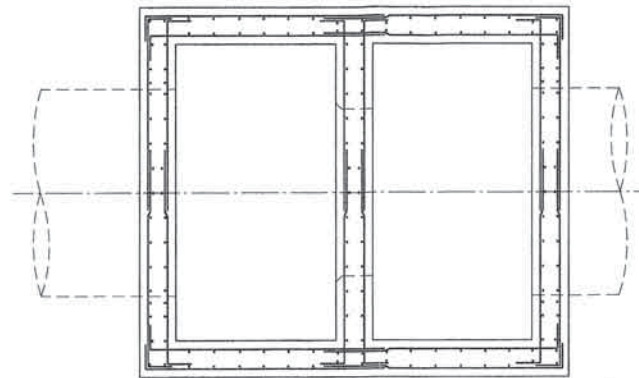

SECTION D
1 : 20

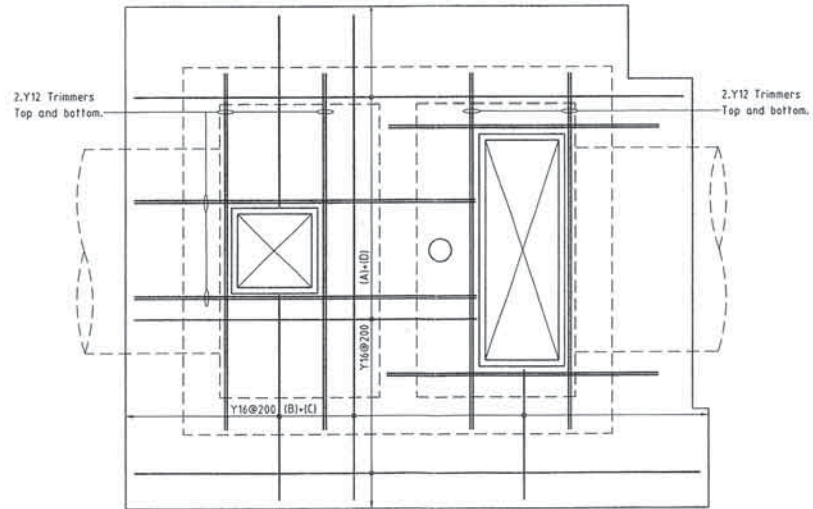




BYPASS VALVE CHAMBER
COVER SLAB (300 thick)

1 : 20
Note: Top reinforcement to have 120 end cog at edges.


100 Bars laid second
120 Bars laid third
120 (A) Bars laid first
120 Bars laid first

1000 500 0 1000 mm
SCALE BEFORE REDUCTION 1 : 20


DESIGNED: <i>CR</i>	DRAWN: <i>CR</i>	CHECKED: <i>CR</i>	RECOMMENDED: <i>CR</i>	APPROVED: <i>CR</i>	DATE: 23-12-1997
PROJECT: <i>Parrearra</i>	PROJ. NO: <i>478/95-52</i>	PROJ. DATE: <i>23-12-1997</i>	PROJ. NAME: <i>Parrearra Development</i>	PROJ. LOCATION: <i>Parrearra Development</i>	DRAWING No: 478/95 - 52
A1 A.H.D. C&D Cardno & Davies Queenston Pty. Ltd. Consulting Engineers		OFFICE: <i>100/100</i> ADDRESS: <i>100/100</i> PHONE: <i>081 554 1111</i> FAX: <i>081 554 1111</i> TELEPHONE: <i>081 554 1111</i> TELEFAX: <i>081 554 1111</i> SYDNEY: <i>100/100</i> ADDRESS: <i>100/100</i> PHONE: <i>081 554 1111</i> FAX: <i>081 554 1111</i> TELEPHONE: <i>081 554 1111</i> TELEFAX: <i>081 554 1111</i>		KAWANA ESTATES PTY. LTD. PARREARRA DEVELOPMENT STRUCTURE Z BYPASS VALVE CHAMBER SECTIONS AND DETAILS	

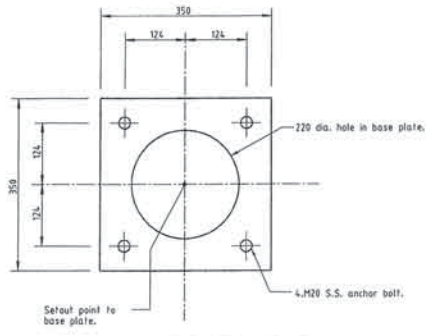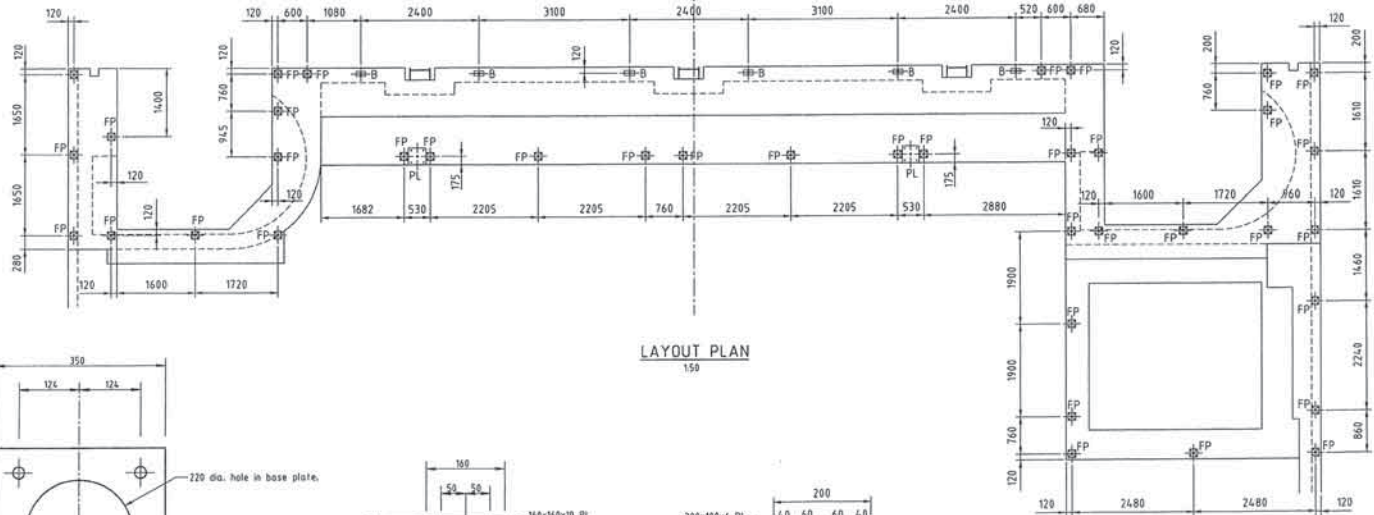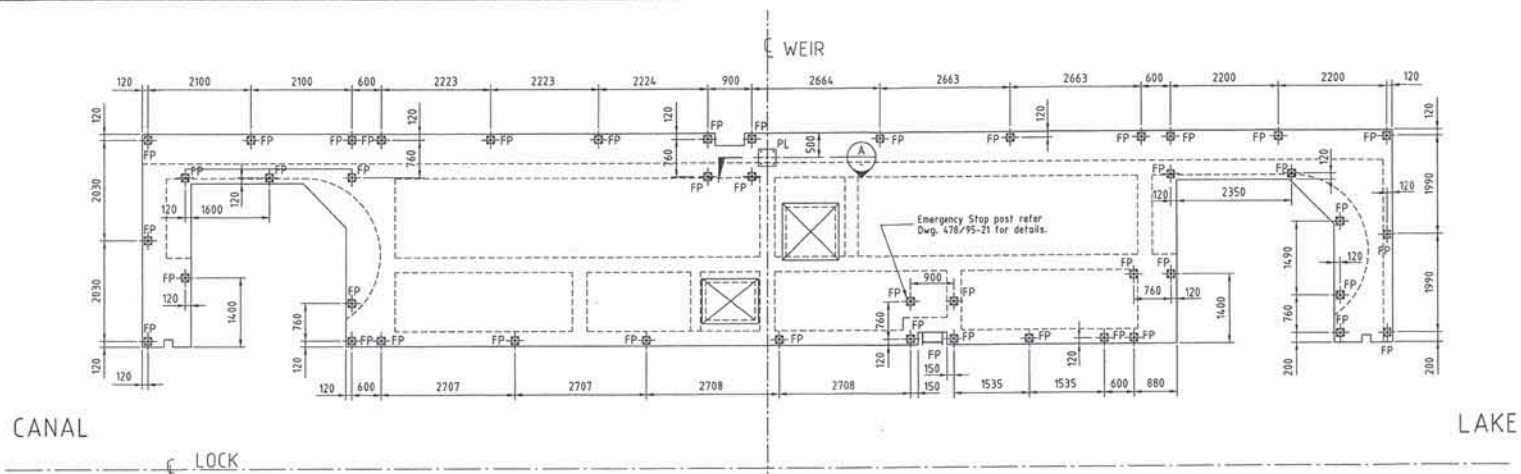


LIGHT POLE BASE PLATE (PL)
15

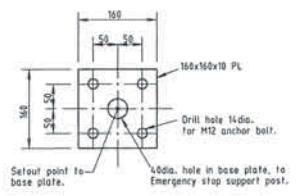

FENCE POST BASE PLATE (FP)
15

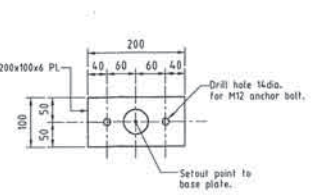

BOLLARD BASE PLATE (B)
15

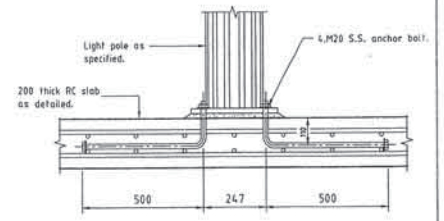

SECTION A
1:10

DESIGNED: <i>[Signature]</i>		CHECKED: <i>[Signature]</i>		DATE: 18-01-1998	
DRAWN: <i>[Signature]</i>		RECOMMENDED: <i>[Signature]</i>		DRAWING No: 478/95-53	
DATE: 18-01-98		APPROVED: <i>[Signature]</i>		DATE: 18-01-1998	
REVISIONS:		REC. APPR.:		DATE:	

C&D **Cardno & Davies**
Queensland Pty. Ltd.
CONSULTING ENGINEERS


OFFICES:
Brisbane
Gold Coast
Sunshine Coast
Hervey Bay
Maryborough
Rockhampton
Tweed Heads

TELEPHONE:
07 551 1111
07 551 1112
07 551 1113
07 551 1114
07 551 1115
07 551 1116
07 551 1117


FAX:
07 551 1118
07 551 1119
07 551 1120
07 551 1121
07 551 1122
07 551 1123

HEAD OFFICE:
25 Spence Street, Brisbane
Postal Address: PO Box 152
Brisbane, Queensland 4000

KAWANA ESTATES PTY. LTD.
PARREARRA DEVELOPMENT
STRUCTURE Z
LOCK STRUCTURE
BASE PLATE SETOUT PLAN FOR LOCK

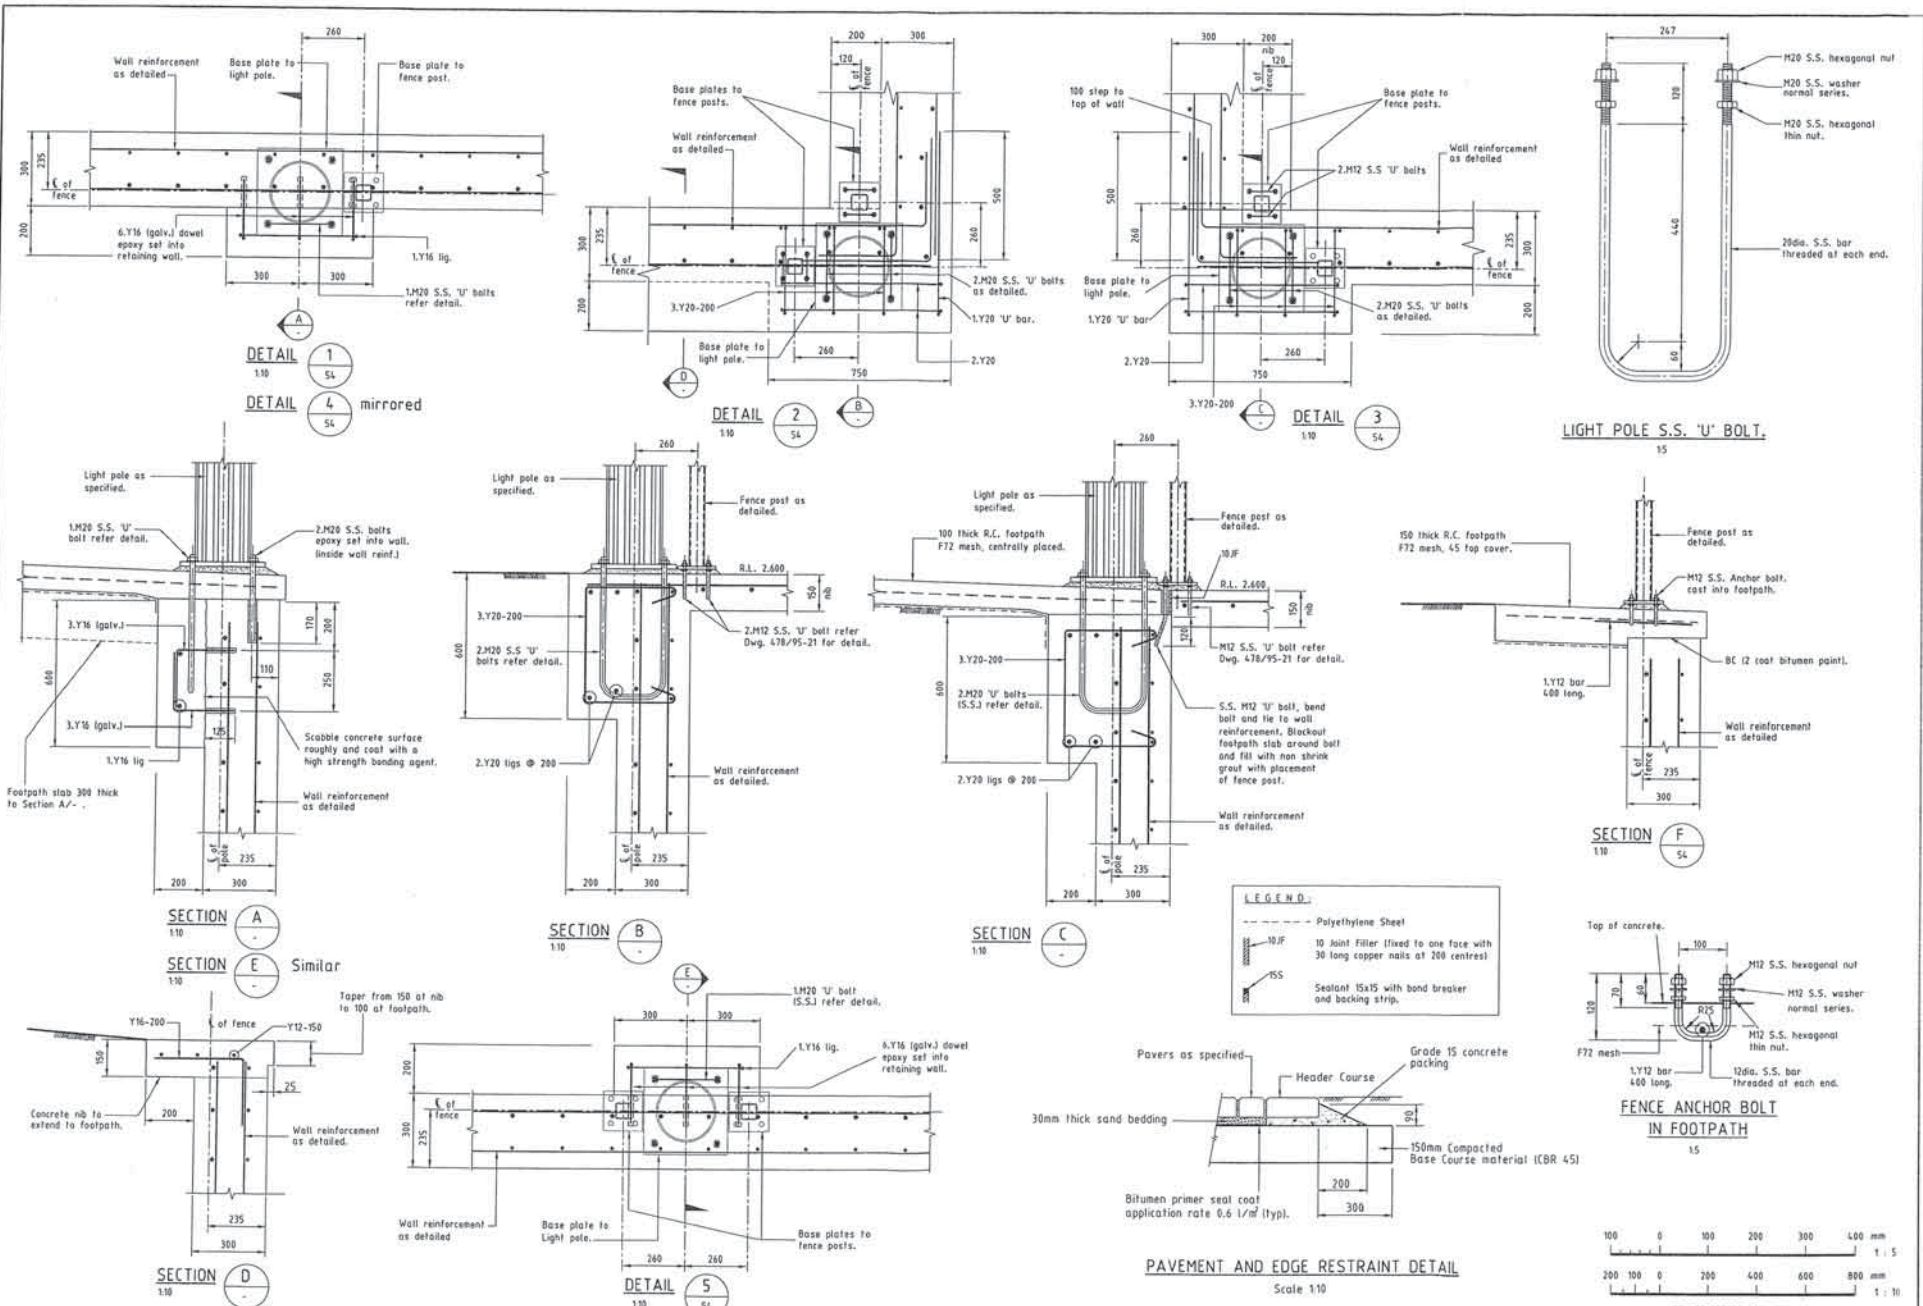

DESIGNED BY <i>[Signature]</i>	CHECKED BY <i>[Signature]</i>	RECOMMENDED BY <i>[Signature]</i>	APPROVED BY <i>[Signature]</i>	DRAWN BY <i>[Signature]</i>	DATE 13-02-1998
A1 A.H.D.			CONSULTING ENGINEERS		
KAWANA ESTATES PTY. LTD.			PARREARRA DEVELOPMENT		
STRUCTURE 2			LANDSCAPING		
FIXING DETAILS FOR LIGHT POLES AND FENCES.			DRAWING No. 478/95-55		

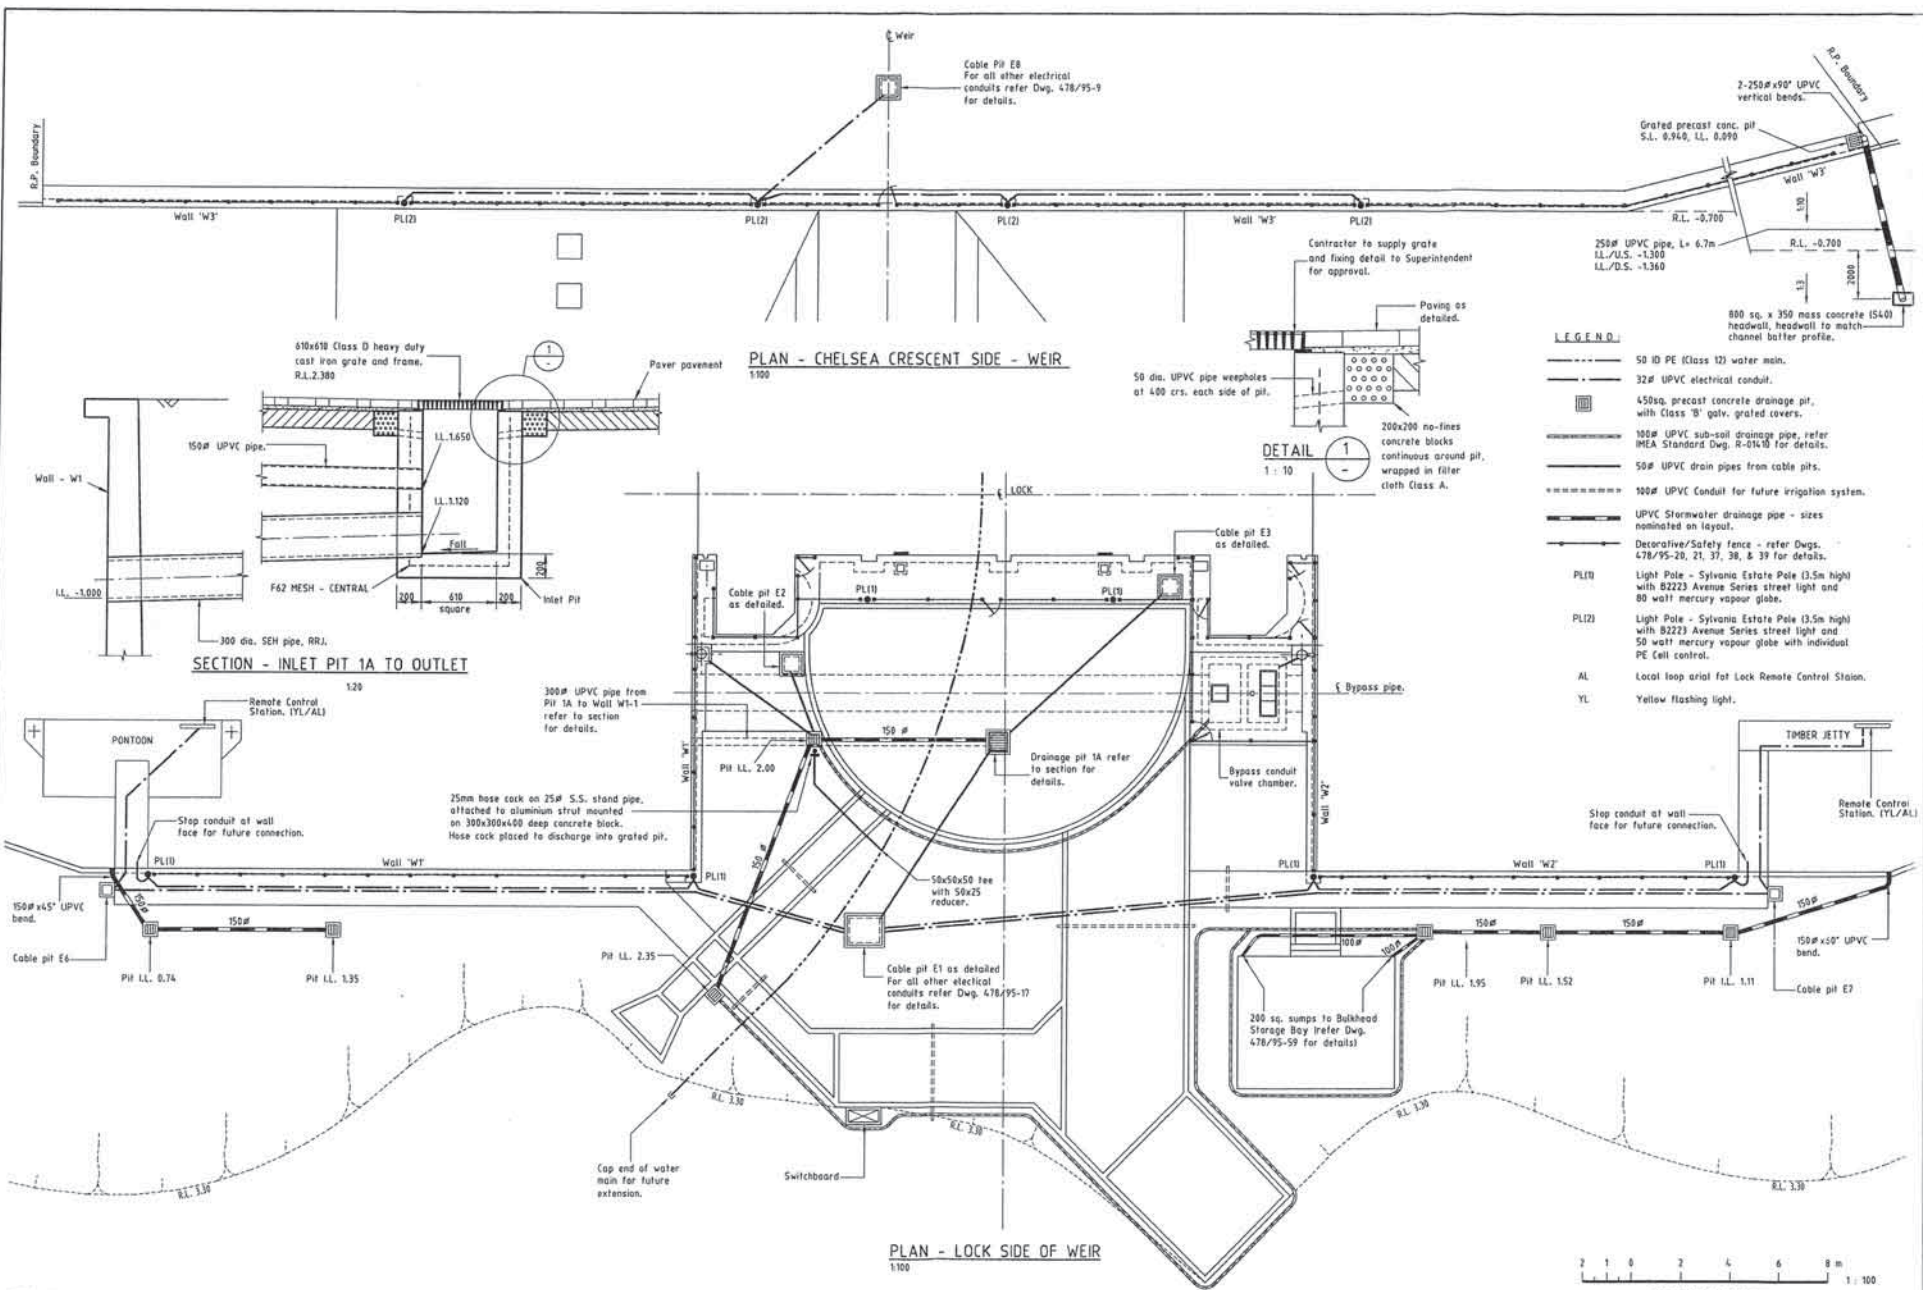

PLAN - CHELSEA CRESCENT SIDE - WEIR
1/100

PLAN - LOCK SIDE OF WEIR
1/100

SECTION - INLET PIT 1A TO OUTLET
1/20


DETAIL 1
1:10

- LEGEND**
- 50 ID PE (Class 12) water main.
 - 32# UPVC electrical conduit.
 - 450sq. precast concrete drainage pit, with Class 'B' galv. grated covers.
 - 100# UPVC sub-soil drainage pipe, refer IMA Standard Dwg. R-014 for details.
 - 50# UPVC drain pipes from cable pits.
 - 100# UPVC Conduit for future irrigation system.
 - UPVC Stormwater drainage pipe - sizes nominated on layout.
 - Decorative/Safety fence - refer Dwg. 478/95-20, 21, 37, 38, & 39 for details.
 - PL10 Light Pole - Sylvana Estate Pole (3.5m high) with B2223 Avenue Series street light and 80 watt mercury vapour globe.
 - PL12 Light Pole - Sylvana Estate Pole (3.5m high) with B2223 Avenue Series street light and 50 watt mercury vapour globe with individual PE Cell control.
 - AL Local loop aerial for Lock Remote Control Station.
 - YL Yellow flashing light.


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DATE: 24-12-1998 10:06:51 AM

DESIGNED: C.J. Hogg	DRAWN: C.J. Hogg	CHECKED: C.J. Hogg	APPROVED: A1	DATUM: A.H.D.	<p>Cardno & Davies Queensland Pty. Ltd. Consulting Engineers</p>	<p>OFFICES: Brisbane 042 322 8822 Cairns 042 322 8822 Gold Coast 042 322 8822 Hervey Bay 042 322 8822 Mackay 042 322 8822 Newcastle 042 322 8822 Rockhampton 042 322 8822 Tweed Heads 042 322 8822</p> <p>LANDSCAPE CONSULTANTS: 38 Boundary Street, Mackay Postal Address PO Box 152 Mackay Queensland 4740</p>	<p>KAWANA ESTATES PTY. LTD. PARREARRA DEVELOPMENT STRUCTURE 2 LANDSCAPING STORMWATER & CONDUIT LAYOUT</p>	DATE: 19-02-1998
REVISIONS:	REV: 18-05-98 Bulkhead storage bay & Viewing platform added.	REV: 27-03-98 Cable pits E2 and E3 moved.	DATE:	DATE: 19-02-1998				


478/95 - 56

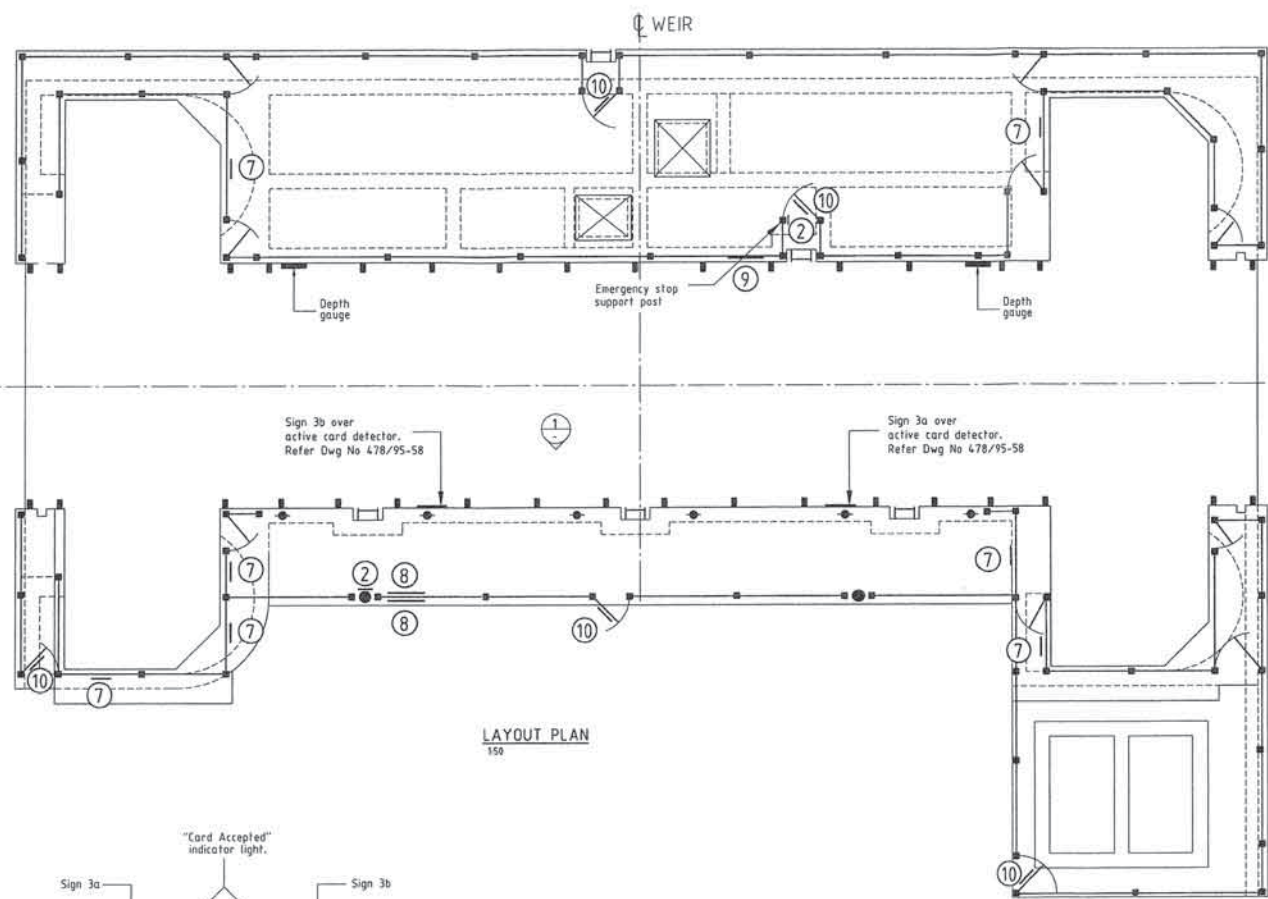

LAYOUT PLAN
150

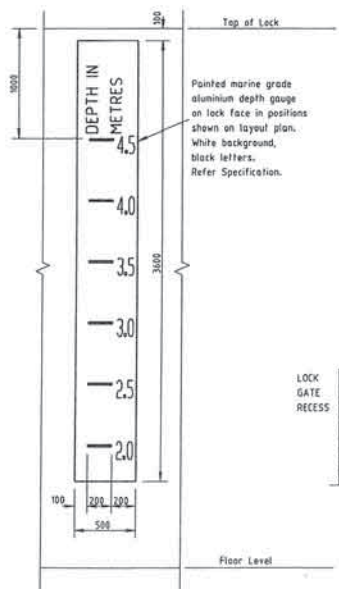

DEPTH GAUGE DETAILS
NOT TO SCALE

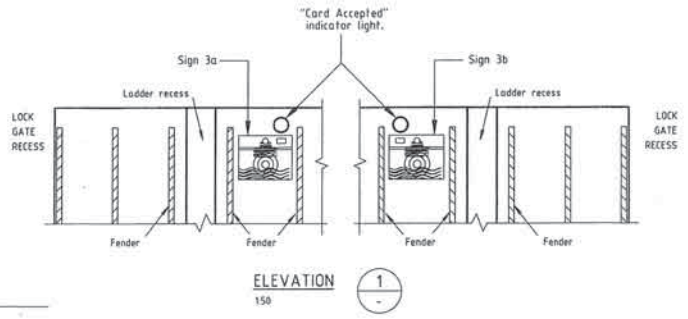

ELEVATION
150

LEGEND

- ② Sign 2, Refer Dwg No 478/95-58
- ⑦ Sign 7, Refer Dwg No 478/95-58
- ⑧ Sign 8, Refer Dwg No 478/95-58
- ⑨ Sign 9, Refer Dwg No 478/95-58
- ⑩ Sign 10, Refer Dwg No 478/95-58



AUTOCAD R13 FILENAME : 895-D1-040
DATE : 16-11-1998 TIME : 4:55 PM

NO.	DATE	REVISIONS	REC.	APPR.	DATE	Sign 3b details
A	11-1-1998					


DESIGNED: *M.E.*
 DRAWN: *M.E.*
 CHECKED: *C.D.V.*
 RECOMMENDED: *A.J.H.*
 APPROVED: *A.J.H.*
 DATE: 11-1-1998

DATUM: A1
 A.H.D.
C&D Cardno & Davies
 Queensland Pty. Ltd.
 404 BR 4/11 RD
 Consulting Engineers


OFFICES: TELEPHONE: FAX:
 Brisbane 0811 5048 9122 0811 5048 9122
 Gold Coast 0811 5048 9122 0811 5048 9122
 Sunshine Coast 0811 5048 9122 0811 5048 9122
 Hervey Bay 0811 5048 9122 0811 5048 9122
 Mackay 0811 5048 9122 0811 5048 9122
 Port Macquarie 0811 5048 9122 0811 5048 9122

KAWANA ESTATES PTY LTD
 PARREARRA DEVELOPMENT
 STRUCTURE 2
 SIGN LOCATIONS AND DETAILS


DATE: 11-05-1998
 DRAWING NO: 478/95-57
 1/1

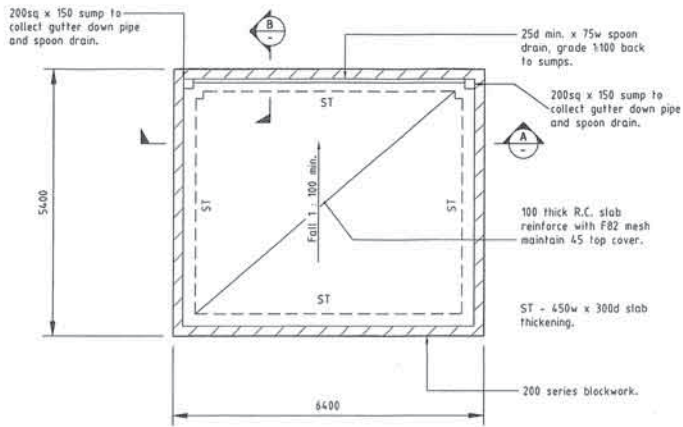


SLAB & FOOTING LAYOUT
1:50

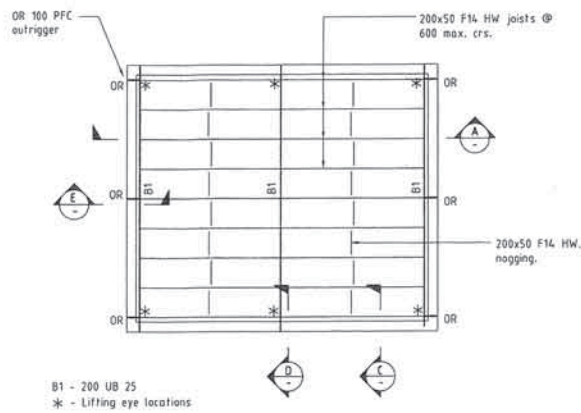


FRAMING LAYOUT
1:50

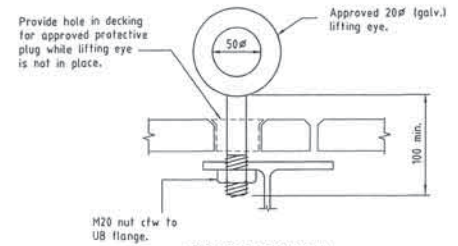


LIFTING EYE DETAIL
1:2.5

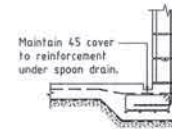


SECTION B
1:10

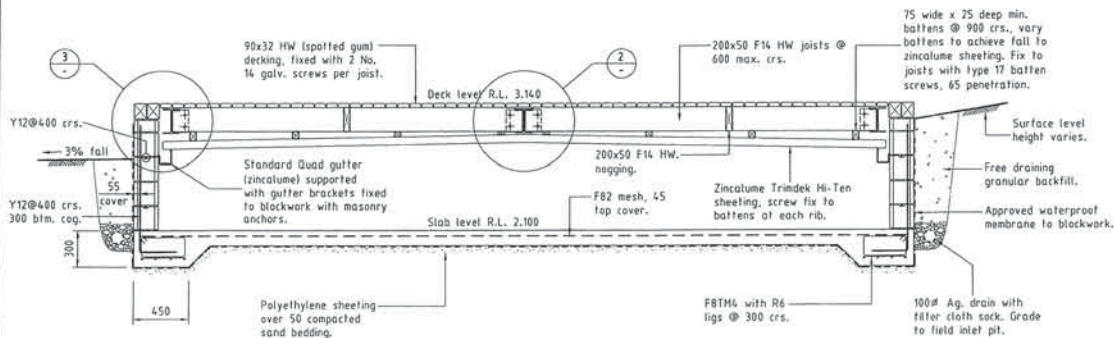

SECTION A
1:20

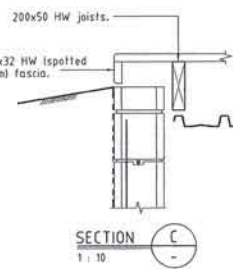


SECTION C
1:10

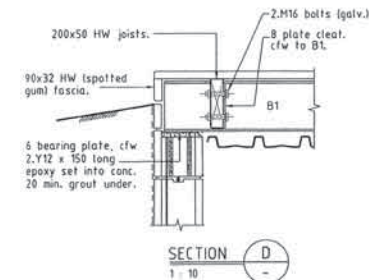


SECTION D
1:10

NOTES


1. All steelwork to hot dipped galvanised after fabrication.
2. All bolts and screws to be galvanised.
3. After removal, timber platform is to be supported by blocks placed under outriggers & B1.

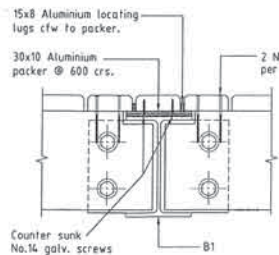


DETAIL 1
1:5

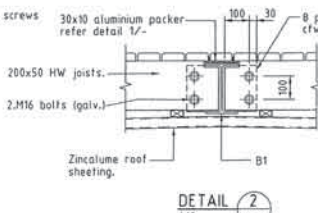


DETAIL 2
1:10

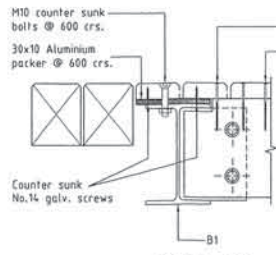

DETAIL 3
1:5

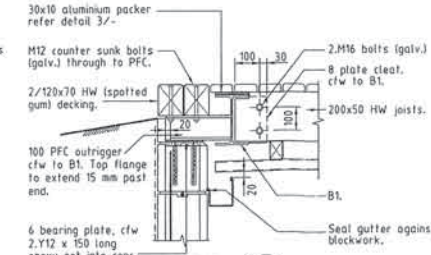

SECTION E
1:10

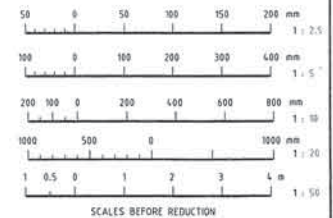


AUTOCAD 2014 PLOTNAME : 895-5829V3
DATE : 05-09-1998 TIME : 15:27 PM

NO.	DATE	REVISIONS	REC.	APP.	DATE	Notes/Revisions
A	21-01-98	Minor Revisions				

DESIGNED: *C.D. Bay*
DRAWN: *C.D. Bay*
CHECKED: *C.D. Bay*
PROJECT NO.: *895-5829*
APPROVED: *C.D. Bay*
SCALE: *A1*


DATUM: A.H.D.
CARDNO & DAVIES
Queensland Pty. Ltd.
CONSULTING ENGINEERS
100 Queen Street, Queensland
Phone: (07) 322 1111
Fax: (07) 322 1111

APPROVED: *C.D. Bay*
DATE: 11-05-1998
DRAWING NO.: **478/95-59**
KAWANA ESTATES PTY LTD
PARREARRA DEVELOPMENT
STRUCTURE 2
LANDSCAPING
BULKHEAD STORAGE BAY

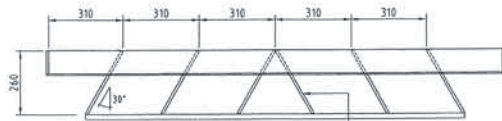


PLAN

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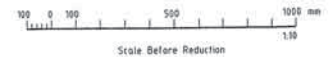
ELEVATION

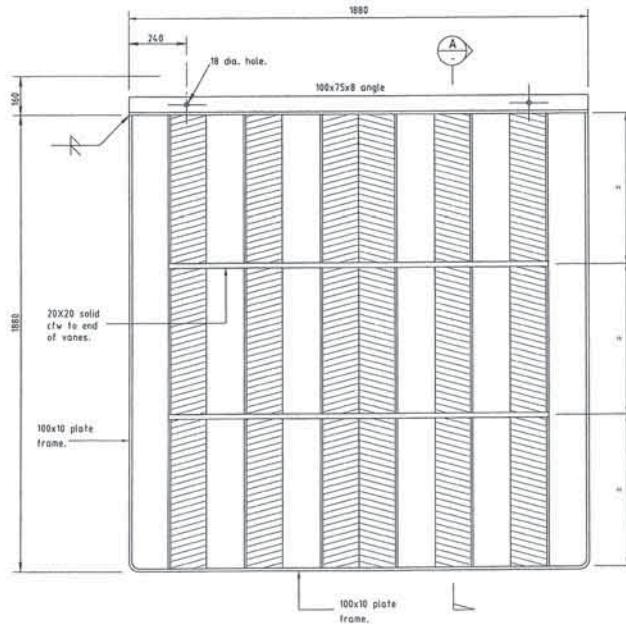1:10



SECTION A-A

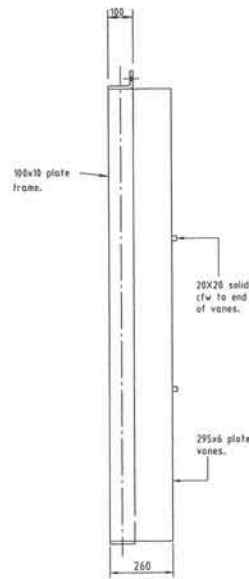1:10



No.	DATE	REVISIONS	REC.	APPR.	No.	DATE	REVISIONS	REC.	APPR.

DESIGNED: *C. J. H.*
 DRAWN: *C. J. H.*
 CHECKED: *C. J. H.*
 RECOMMENDED: *C. J. H.*
 APPROVED: *S. S. C.*
 NOTED: A1 DATUM A.H.D.
 PROJECT: PARREARRA DEVELOPMENT
 DATE: 15-1-1999 TIME: 9:47 AM

Cardno + Davies
 Cardno & Davies Queensland Pty Ltd
 ACH 581 074 962

OFFICES: TELEPHONE FAX
 Brisbane 071 3368 9622 071 3558 9722
 Gold Coast 071 8450 9533 071 8028 9543
 Sunshine Coast 071 8443 9535 071 8440 9643
 Townsville 071 4770 1166 071 4721 2566
 Harvey Bay 071 4124 8458 071 4124 9155
 Bundaberg 071 4181 1211 071 4151 8710
 Port Kennedy 081 18761 325 3255 081 18761 325 0961
 BRISBANE OFFICE:
 18 Colquhoun Avenue, Maroochydore
 P.O. Box 162, Maroochydore, QM 4506, Australia
 Email: info@cardno.com.au

KAWANA ESTATES PTY. LTD.
 PARREARRA DEVELOPMENT
 STRUCTURE Z
 LOCK WATER QUALITY BYPASS CHANNEL
 BYPASS CONDUIT OUTLET DIFFUSER.

DATE: January 1999
 DRAWING No: **478/95-60**


Appendix C: Quay Line Plan

PARREARRA LAKE QUAY LINE PLANS

Drawing No:	Rev.	Date:	Stage
P-2780-55	B	15/11/2001	PLA2A, 2B & 2C
P-2780-56	C	15/11/2001	PLA2A, 2B & 2C
P-2780-76	B	15/11/2001	Stage 1
P-2780-77	B	15/11/2001	Stage 1
P-2780-84-1	A	15/11/2001	Stage 2
P-2780-84-2	A	15/11/2001	Stage 2
P-2780-92-1	A	15/11/2001	Stage 3
P-2780-92-2	A	15/11/2001	Stage 3
P-2780-93-1	A	15/11/2001	Stage 4
P-2780-93-2	A	15/11/2001	Stage 4
P-2780-93-3	A	15/11/2001	Stage 4
P-2780-93-4	B	15/11/2001	Stage 4
P-2780-93-5	C	15/11/2001	Stage 4
P-2780-505-1		20/02/2002	Stage 5
P-2780-505-2	A	28/02/2002	Stage 5
P-2780-505-3		20/02/2002	Stage 5
P-2780-505-4		20/02/2002	Stage 5
P-2780-524		7/02/2003	Stage 5
P-2780-527-1		26/02/2003	Stage 7
P-2780-527-2		26/02/2003	Stage 7
P-2780-527-3		26/02/2003	Stage 7
P-2780-527-4		26/02/2003	Stage 7
P-2780-528		7/06/2003	Stage 7
P-2780-529		6/03/2003	Stage 7
P-2780-536-1	B	5/05/2004	Stage 8
P-2780-536-2	B	5/05/2004	Stage 8
P-2780-536-3	B	5/05/2004	Stage 8
P-2780-536-4	B	5/05/2004	Stage 8
P-2780-536-5	B	5/05/2004	Stage 8


NOTES

1. Colandra City Council is the trustee of the Sport and Recreation Reserve (Parrearra Lake). No structures can be erected in Parrearra Lake before entering into a lease under Section 57 of the Land Act, 1994. The structures must be approved in accordance with the approval process and comply with the structural and operation requirements as outlined in the Parrearra Lake Management Plan.
2. A vessel berthed at a pontoon must not at any time, extend within 1.5 metres of the side boundaries of the designated Quay Line. Vessels must comply with all other Mooring Arrangements as specified in the Parrearra Lake Management Plan.
3. Restrictions to the height and beam of vessels may apply due to The Nicklin Way bridges and the width of the lock
4. The lake area is a Sport and Recreation Reserve under the control of the Colandra City Council and the use of the lake and environs is subject to control by local laws
5. The mooring allocations shown on this plan are only for the potential use of lots 72-80, 32 and 93 as shown on this plan
6. Underwater stormwater outlets into the lake may impact on some of the mooring allocations shown on this plan. A user should satisfy themselves on this matter
7. The easement shown across the park from a lot to a quay line allocation, is for the purpose of an underground extension of the water and electricity services from that lot to the mooring

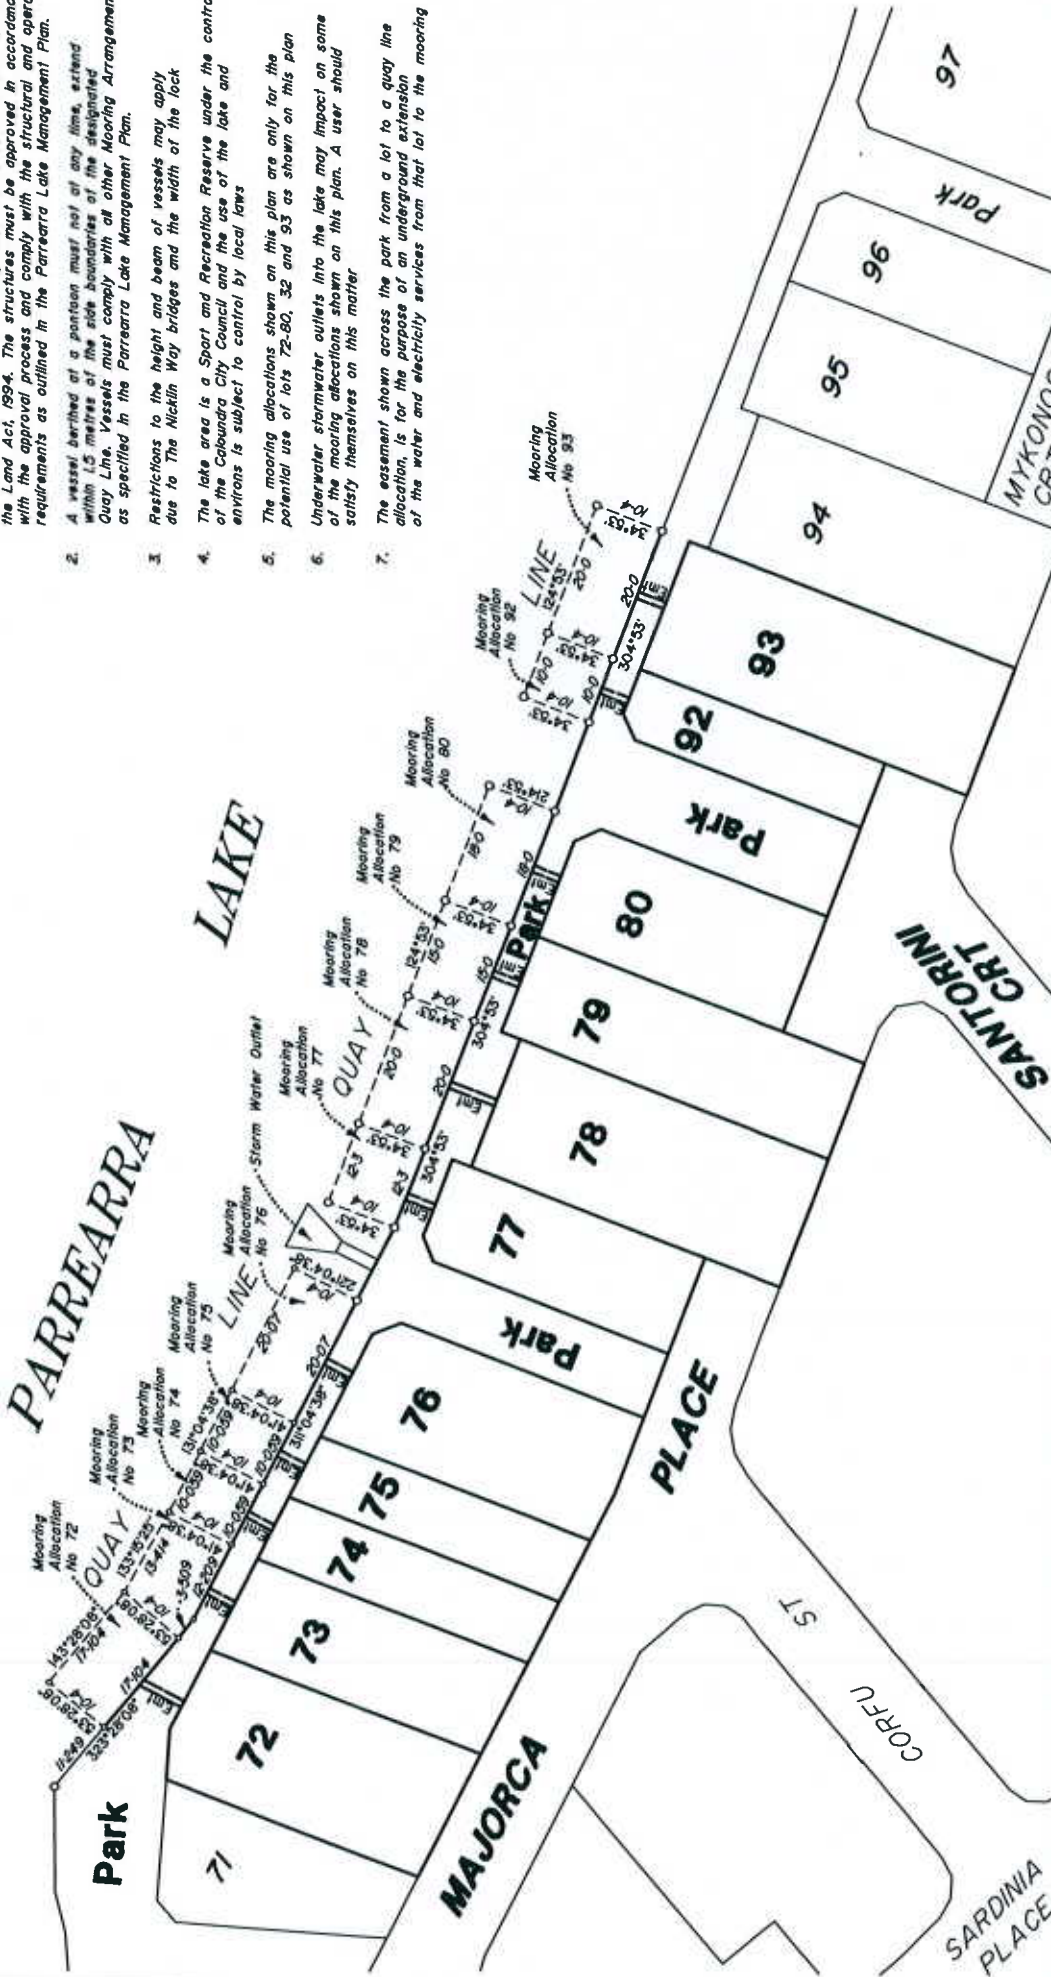

<p>J.B. Goodwin, Midson & Partners consulting surveyors, planners and development consultants</p> <p>Brisbane 622 Coronation Drive Toowong 4066 Ph (07)3870 2161 Fax (07)3870 3944 Keweenaw 2/12 Technology Drive Warana 4675 Ph (07)5493 7407 Fax (07)5493 4880 Beanoah 2 Park Street Beanoah 4310 Ph/Fax (07)5483 1368</p> <p><small>member firm of the association of consulting surveyors</small></p>		<p>LENSWORTH KAWANA WATERS PTY LTD AMDT</p> <p>Plan of Mooring Layout for Release 1 & 2 Stage 1, Kawana Island</p> <p>B</p>	
<p>Surveyed</p>	<p>Drawn</p>	<p>GJF</p>	<p>17/01/01</p>
<p>Designed</p>	<p>Checked</p>	<p>JBG</p>	<p>17/01/01</p>
<p>FBK</p>	<p>LBK</p>	<p>scale:</p>	<p>ref no</p>
<p>1:750</p>	<p>P-2780-77</p>	<p>A3</p>	<p>AMDT</p>

Amdt B 15-11-01 MK (CCC) Amend Notes
 Amdt A 22-02-01 JBG Amend Quay Allocations Lot 77

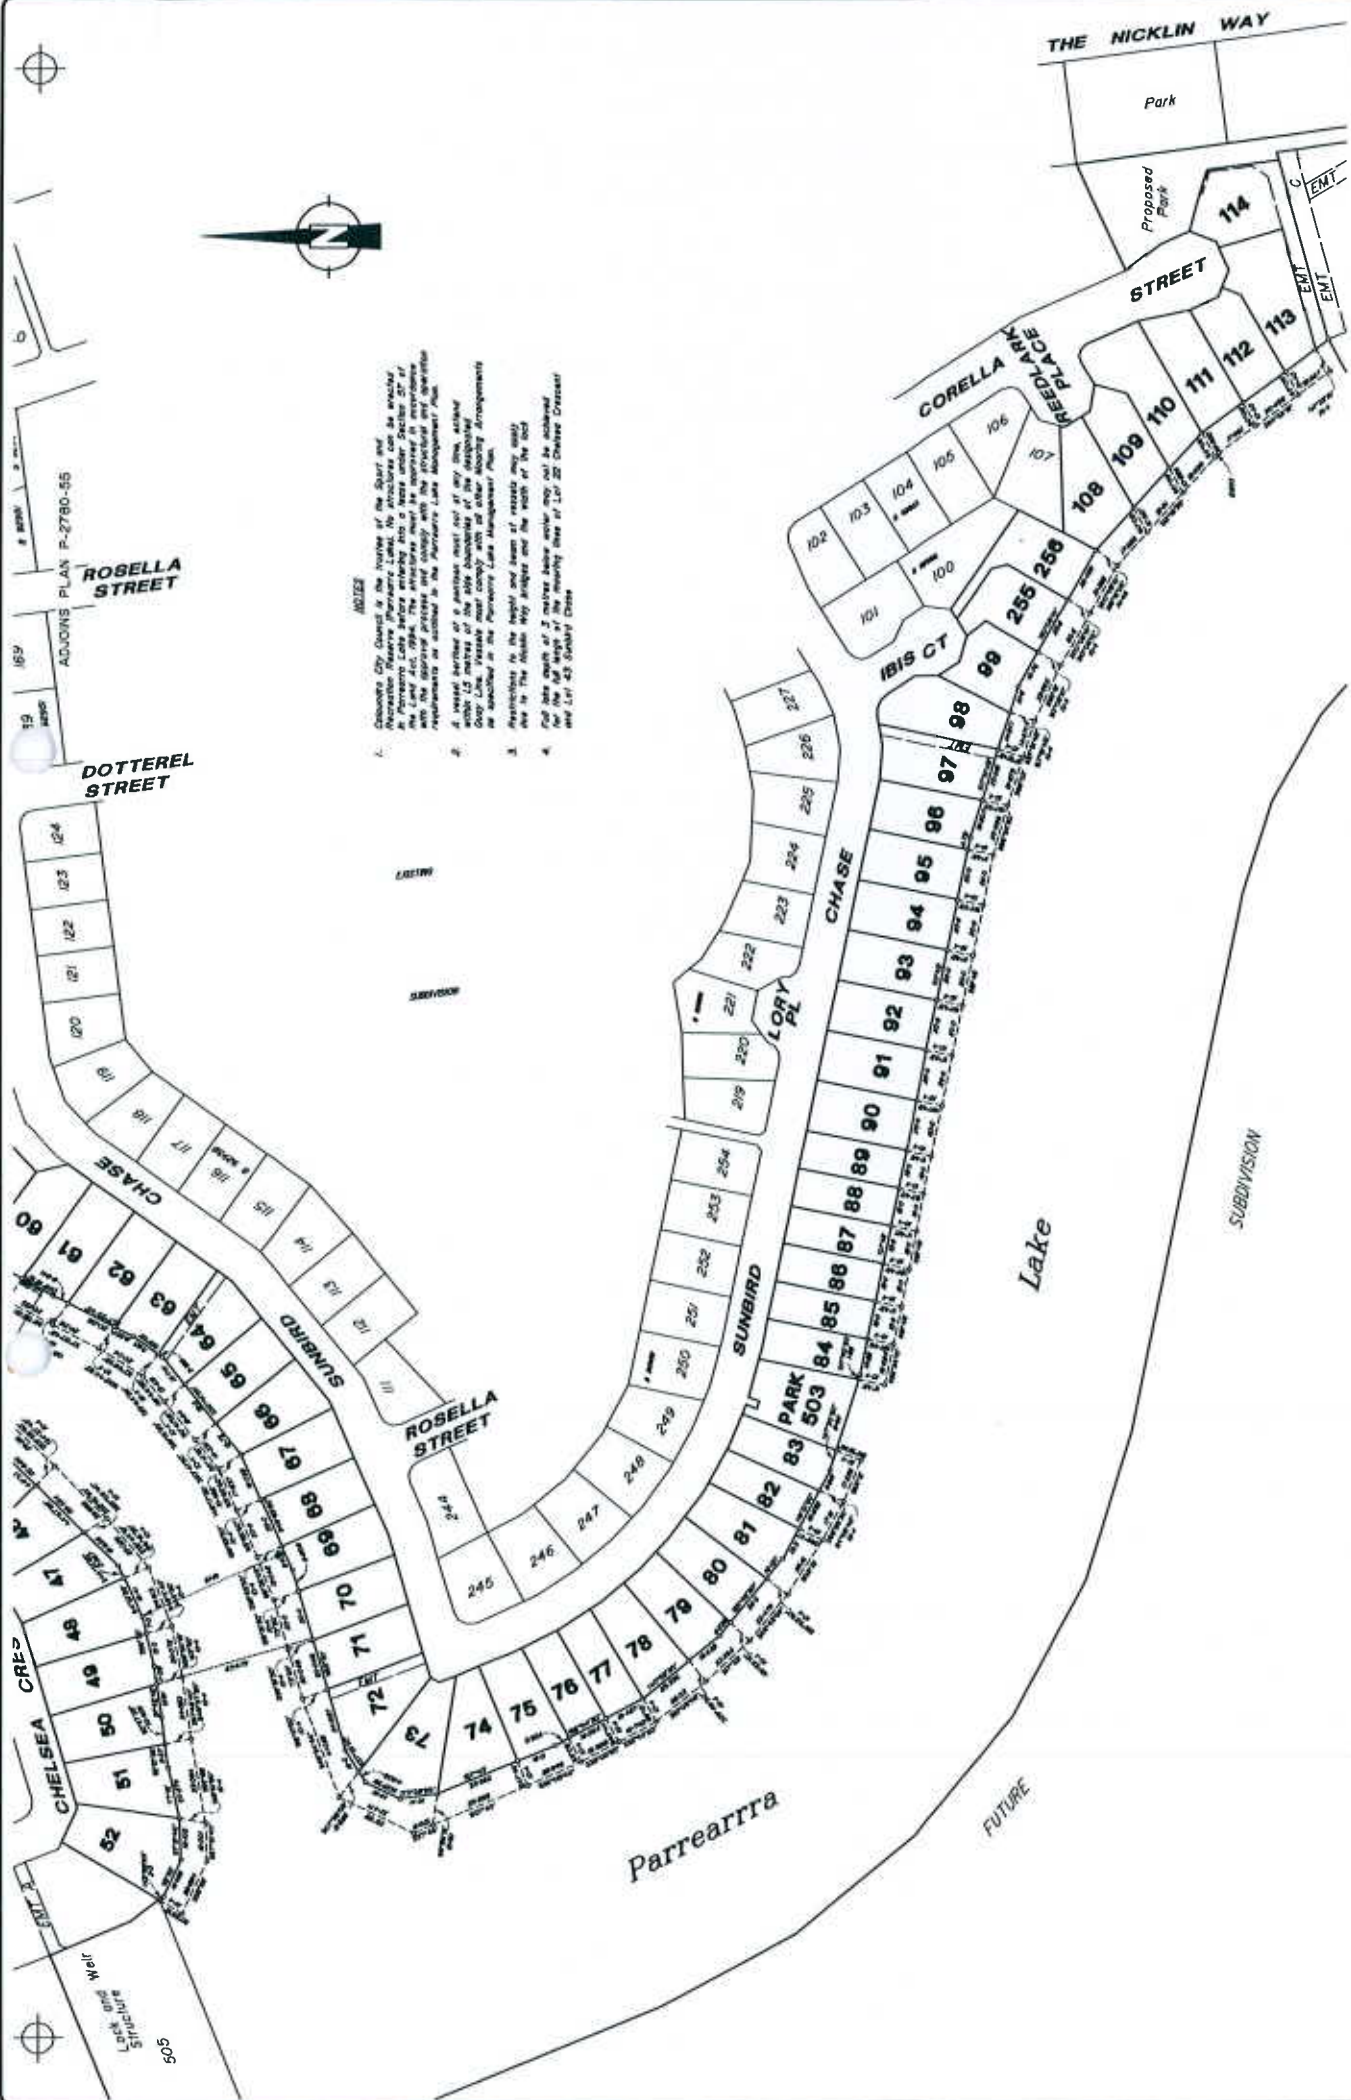


- NOTES**
1. Adelaide City Council is the owner of the Street and the adjacent area. The Street and the adjacent area are shown in the plan under Section 57 of the Land Act, 1994. The structures must be approved in accordance with the provisions of the Adelaide City Council's requirements as outlined in the Parrearra Lake Management Plan.
 2. A 15m wide easement for the street and the adjacent area is shown in the plan. The easement is shown in the Parrearra Lake Management Plan.
 3. Structures to the left and right of the street may not be higher than 2 metres above the ground level. The height of the structures must comply with the other planning arrangements as outlined in the Parrearra Lake Management Plan.
 4. Full details of the height and level of the street and the adjacent area are to be provided in the final stage of the subdivision. The height of the street and the adjacent area is to be provided in the final stage of the subdivision.


Drawing No. 1000 Date of Issue 10/10/2018 Scale 1:1000 Project Stages PL2A, PL2B & PL2C Parrearra	Client KAWANA ESTATES PTY LTD Planning Stage PL2A, PL2B & PL2C Parrearra Parish of Mooloolah County of Conning	Consultant J.B. Goodwin, Midson & Partners Consulting Engineers 11000 P-2780-56	Drawing Title Plan of Mooring Layout Stage PL2A, PL2B & PL2C Parrearra Parish of Mooloolah County of Conning	Drawing No. A1 Date of Issue 10/10/2018 Scale 1:1000

NOTES

1. Caloundra City Council is the trustee of the Sport and Recreation Reserve (Parrearra Lake). No structures can be erected in Parrearra Lake before entering into a lease under Section 57 of the Land Act, 1994. The structures must be approved in accordance with the approval process and comply with the structural and operation requirements as outlined in the Parrearra Lake Management Plan.
2. A vessel berthed at a pontoon must not at any time, extend within 1.5 metres of the side boundaries of the designated Quay Line. Vessels must comply with all other Mooring Arrangements as specified in the Parrearra Lake Management Plan.
3. Restrictions to the height and beam of vessels may apply due to The Nicklin Way bridges and the width of the lock.
4. The lake area is a Sport and Recreation Reserve under the control of the Caloundra City Council and the use of the lake and environs is subject to control by local laws.
5. The mooring allocations shown on this plan are only for the potential use of lots 94-97 as shown on this plan.
6. Underwater stormwater outlets into the lake may impact on some of the mooring allocations shown on this plan. A user should satisfy themselves on this matter.
7. The easement shown across the park from a lot to a quay line allocation, is for the purpose of an underground extension of the water and electricity services from that lot to the mooring.

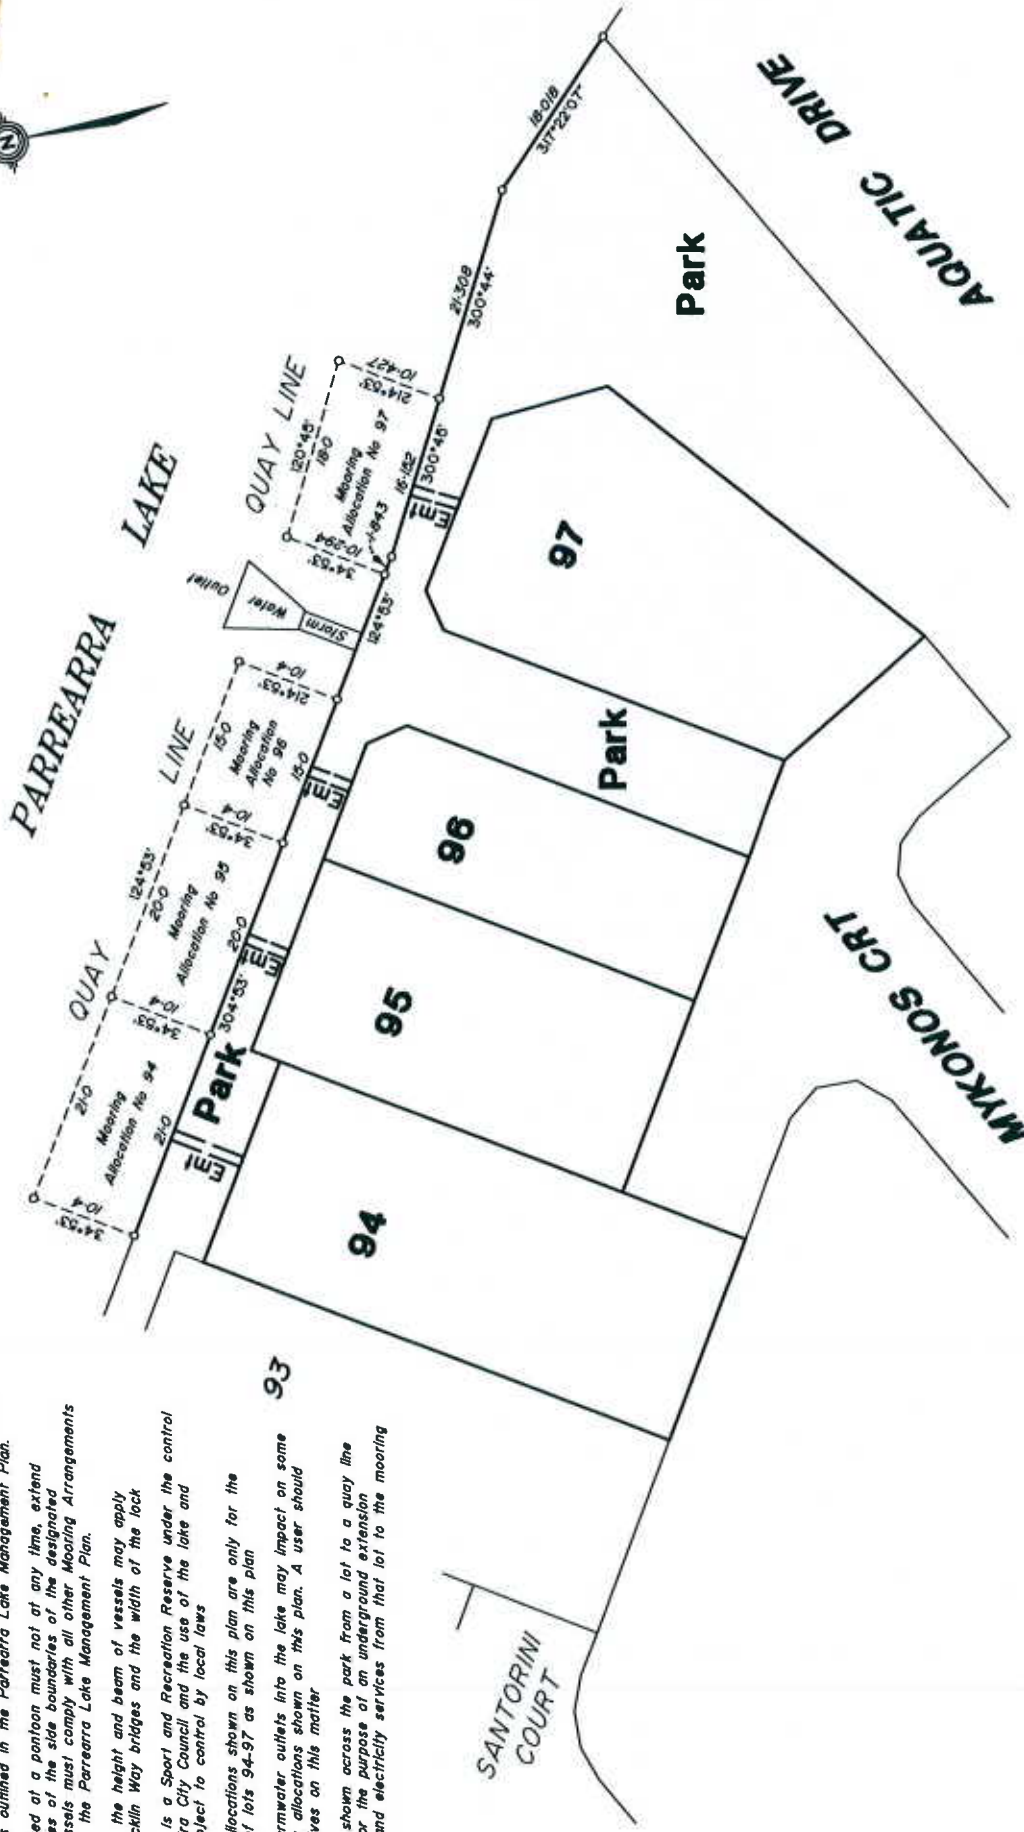


<p>J.B. Goodwin, Midson & Partners consulting surveyors, planners and development consultants</p> <p>GHP</p>		<p>Brisbane 628 Coronation Drive Toowong 4066 Ph (07)3570 2161 Fax (07)3570 3944</p> <p>Kawana 2/12 Technology Drive Warrina 4575 Ph (07)5463 1707 Fax (07)5463 4800</p> <p>Bonnieville 2 Park Street, Bonnah 4310 Ph/Fax (07)5463 1598</p> <p>member firm of the association of consulting surveyors</p>		<p>LENSWORTH KAWANA WATERS PTY LTD</p> <p>Plan of Mooring Layout for Release 3 of Stage 1, Kawana Island</p>		<p>AMDT</p> <p>B</p>				
<p>Surveyed</p>	<p>Drawn</p>	<p>GUF</p>	<p>17/1/01</p>	<p>Designed</p>	<p>JBG</p>	<p>17/1/01</p>	<p>FBK</p>	<p>scale: 1:500</p>	<p>ref no P-2780-76</p>	<p>A3</p>
<p>Amdt B 15-11-01 MK (CCC) Amend Notes Amdt A 22-02-01 JBG Amend Quay line Allocation Lot 97</p>										

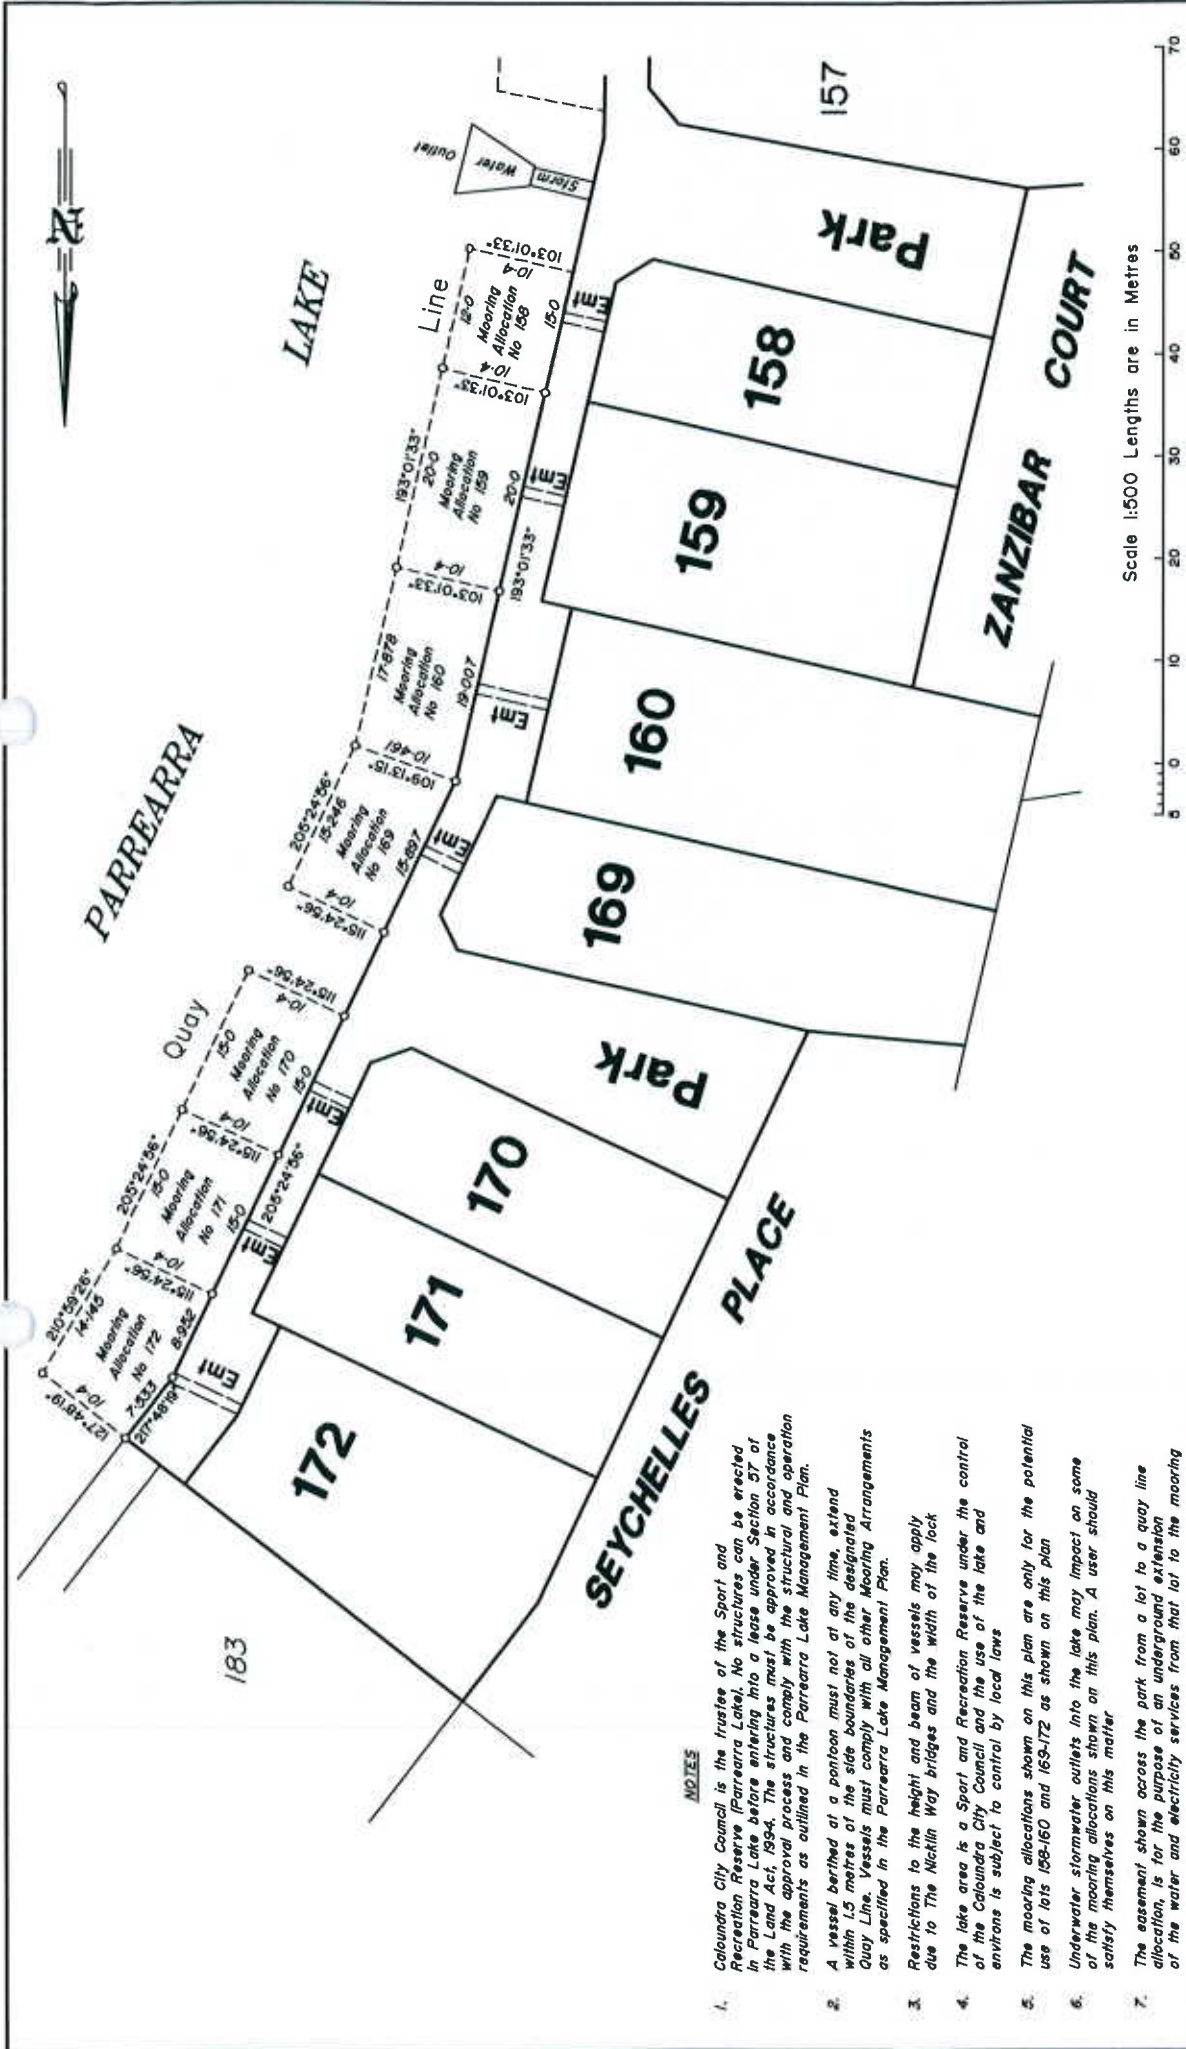

NOTES

1. Caloundra City Council is the trustee of the Sport and Recreation Reserve (Parrearra Lake). No structures can be erected in Parrearra Lake before entering into a lease under Section 57 of the Land Act, 1994. The structures must be approved in accordance with the approval process and comply with the structural and operation requirements as outlined in the Parrearra Lake Management Plan.
2. A vessel berthed at a pontoon must not at any time, extend within 1.5 metres of the side boundaries of the designated Quay Line. Vessels must comply with all other Mooring Arrangements as specified in the Parrearra Lake Management Plan.
3. Restrictions to the height and beam of vessels may apply due to The Nicklin Way bridges and the width of the lock.
4. The lake area is a Sport and Recreation Reserve under the control of the Caloundra City Council and the use of the lake and environs is subject to control by local laws.
5. The mooring allocations shown on this plan are only for the potential use of lots 158-160 and 169-172 as shown on this plan.
6. Underwater stormwater outlets into the lake may impact on some of the mooring allocations shown on this plan. A user should satisfy themselves on this matter.
7. The easement shown across the park from a lot to a quay line allocation, is for the purpose of an underground extension of the water and electricity services from that lot to the mooring

<p>LENSWORTH KAWANA WATERS PTY LTD</p> <p>Plan of Mooring Layout Stage 2 Kawana Island</p>		<p>A</p>
<p>J.B. Goodwin, Midson & Partners consulting surveyors, planners and development consultants</p>		<p>A3</p>
<p>Surveyed Drawn</p>	<p>JAH 04-06-01</p>	<p>Designed Checked</p>
<p>Scale: 1:500</p>	<p>ref no P-2780-84-2</p>	
<p>628, Capetown Drive, Torowai 4098 Ph: (07)3570 2161 Fax: (07)3570 3644</p>		<p>AMDT</p>
<p>2/12, Technology Drive, Warrara 4975 Ph: (07)5463 1707 Fax: (07)5463 4800</p>		<p>FBK LEK</p>
<p>2, Park Street, Breamah 4310 Ph/Fax: (07)5463 1586</p>		<p>member firm of the association of consulting engineers</p>
<p><i>Amdt A 15-II-01 MK (CCC) Amend Notes</i></p>		

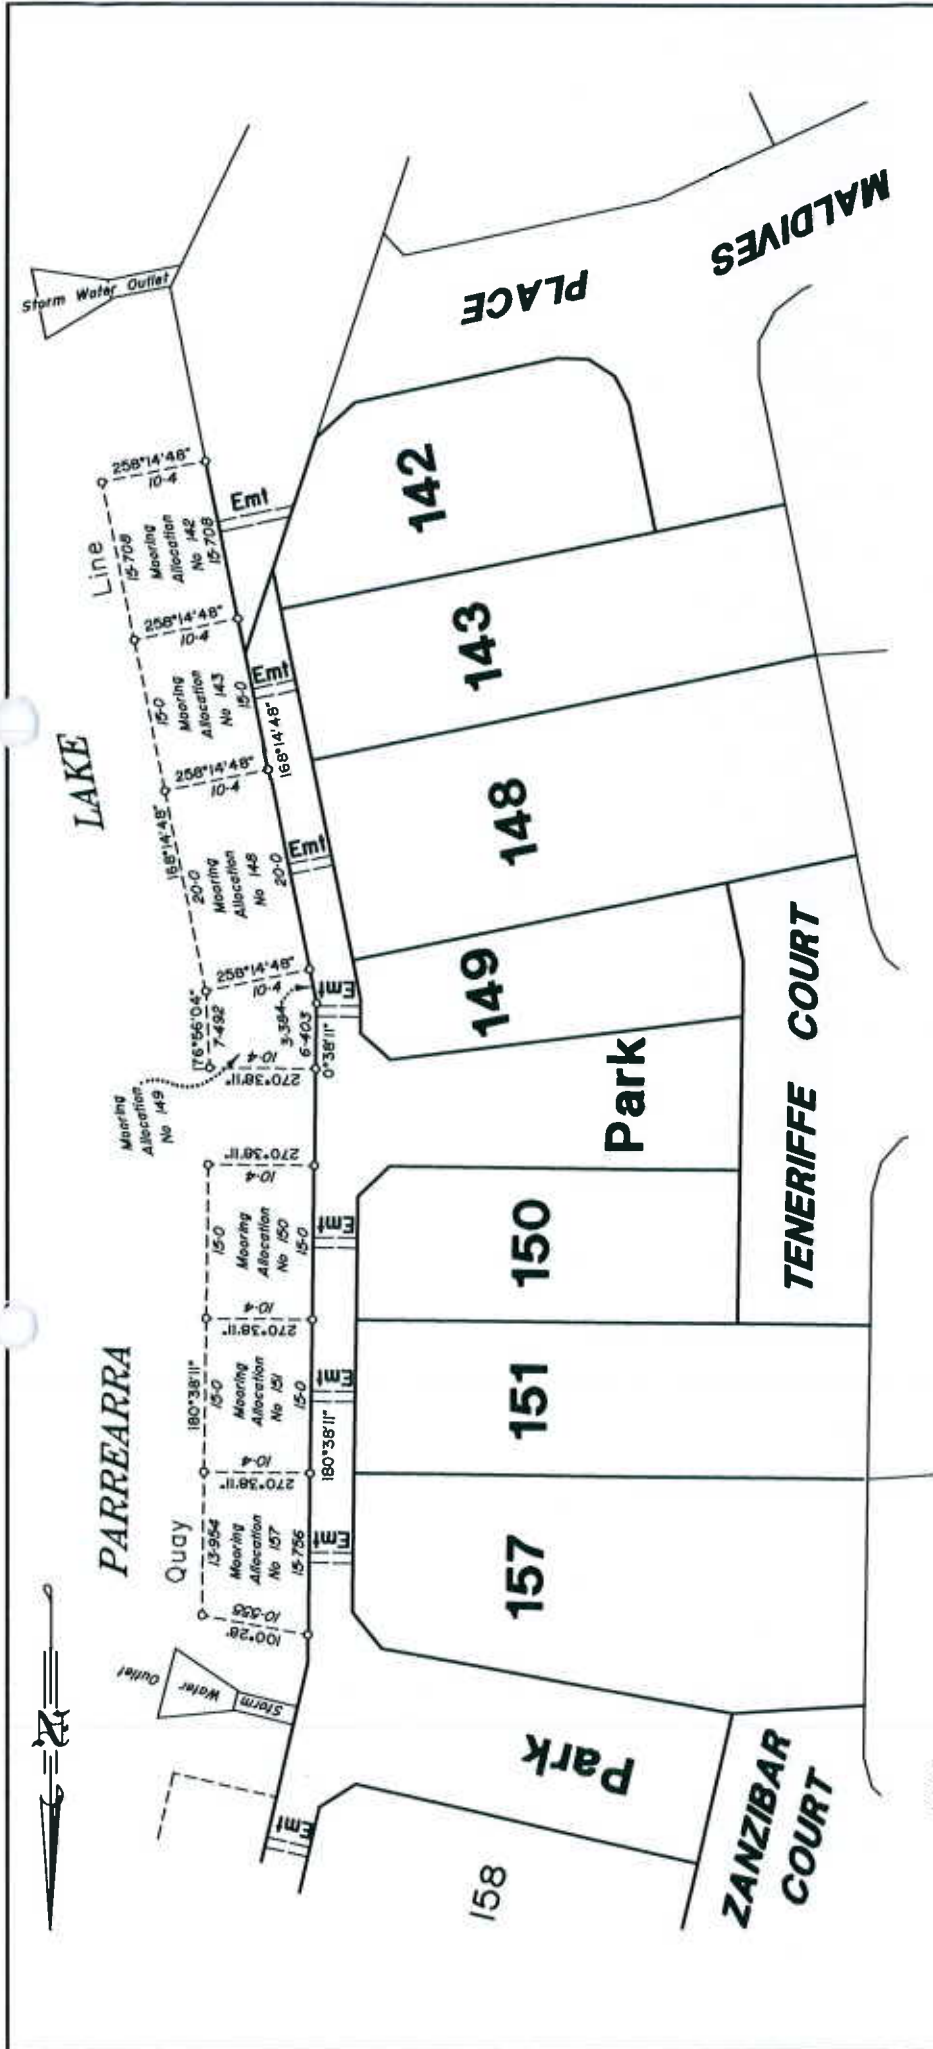


NOTES

1. Caloundra City Council is the trustee of the Sport and Recreation Reserve (Parrearra Lake). No structures can be erected in Parrearra Lake before entering into a lease under Section 57 of the Land Act 1994. The structures must be approved in accordance with the approval process and comply with the structural and operation requirements as outlined in the Parrearra Lake Management Plan.
2. A vessel berthed at a pontoon must not at any time, extend within 1.5 metres of the side boundaries of the designated Quay Line. Vessels must comply with all other Mooring Arrangements as specified in the Parrearra Lake Management Plan.
3. Restrictions to the height and beam of vessels may apply due to The Wickham Way bridges and the width of the lock
4. The lake area is a Sport and Recreation Reserve under the control of the Caloundra City Council and the use of the lake and environs is subject to control by local laws
5. The mooring allocations shown on this plan are only for the potential use of lots 142, 143, 148-151 and 157 as shown on this plan
6. Underwater stormwater outlets into the lake may impact on some of the mooring allocations shown on this plan. A user should satisfy themselves on this matter
7. The easement shown across the park from a lot to a quay line allocation, is for the purpose of an underground extension of the water and electricity services from that lot to the mooring

Scale 1:500 Lengths are in Metres




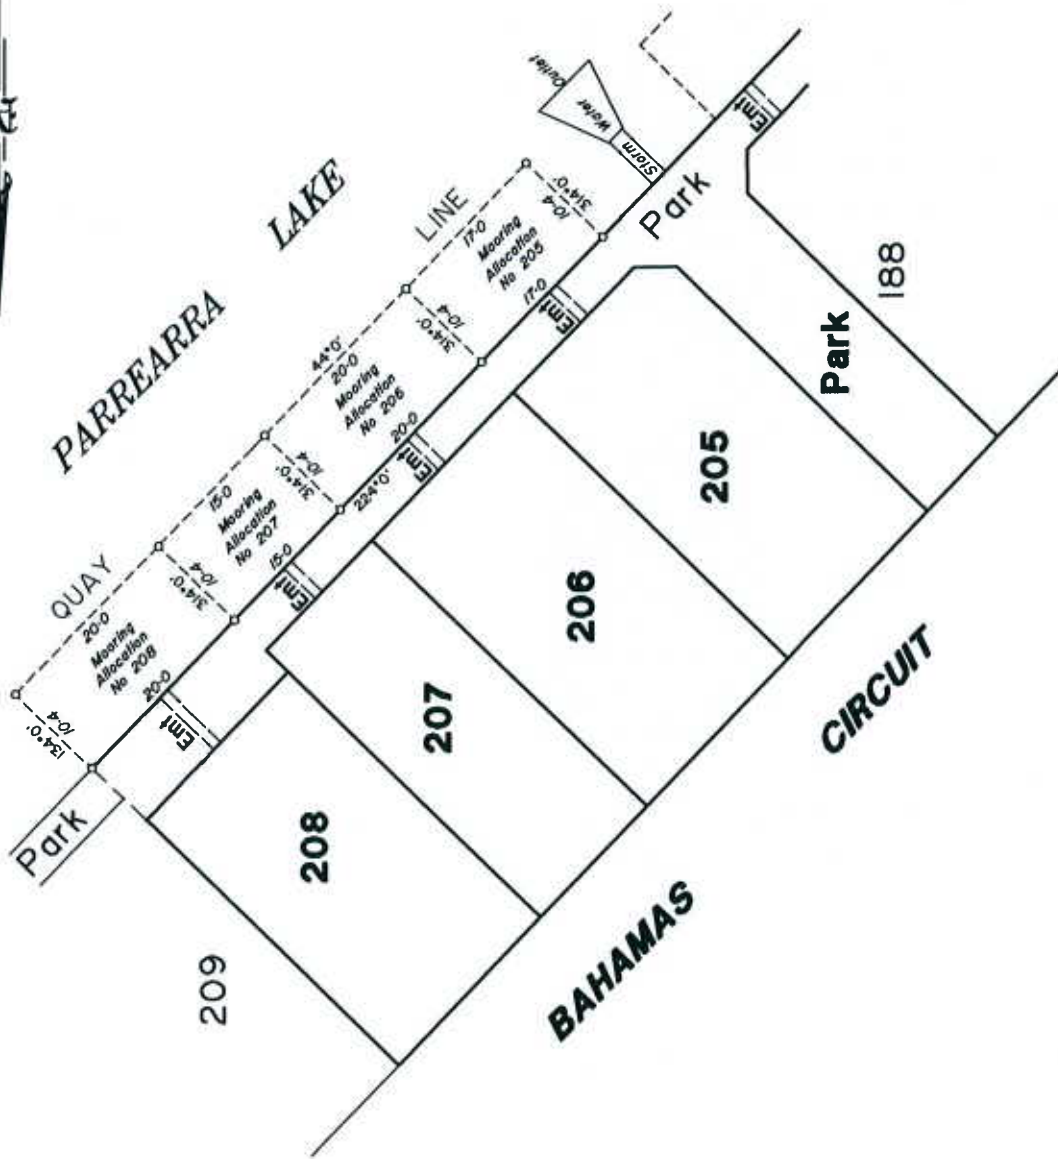
<p>J.B. Goodwin, Midson & Partners consulting surveyors, planners and development consultants</p> <p>828 Concession Drive Toowoomba 4008 Ph: (07)3570 2161 Fax: (07)3570 3844</p> <p>2/12 Technology Drive Warana 4575 Ph: (07)5483 1707 Fax: (07)5483 4880</p> <p>2 Park Street, Boonah 4310 Ph/Fax: (07)5483 1586</p> <p><small>member firm of the association of consulting surveyors</small></p>		<p>LENSWORTH KAWANA WATERS PTY LTD</p> <p>Plan of Mooring Layout Stage 2 Kawana Island</p>	<p>AMDT A</p>
<p>Designed Checked</p>	<p>Drawn Checked</p>	<p>Scale: 1:500</p> <p>ref no P-2780-84-1</p>	<p>A3</p>
<p>Surveyed Drawn</p>	<p>JAH 04-06-01</p>	<p>SJG FBK LBK</p>	<p>A3</p>

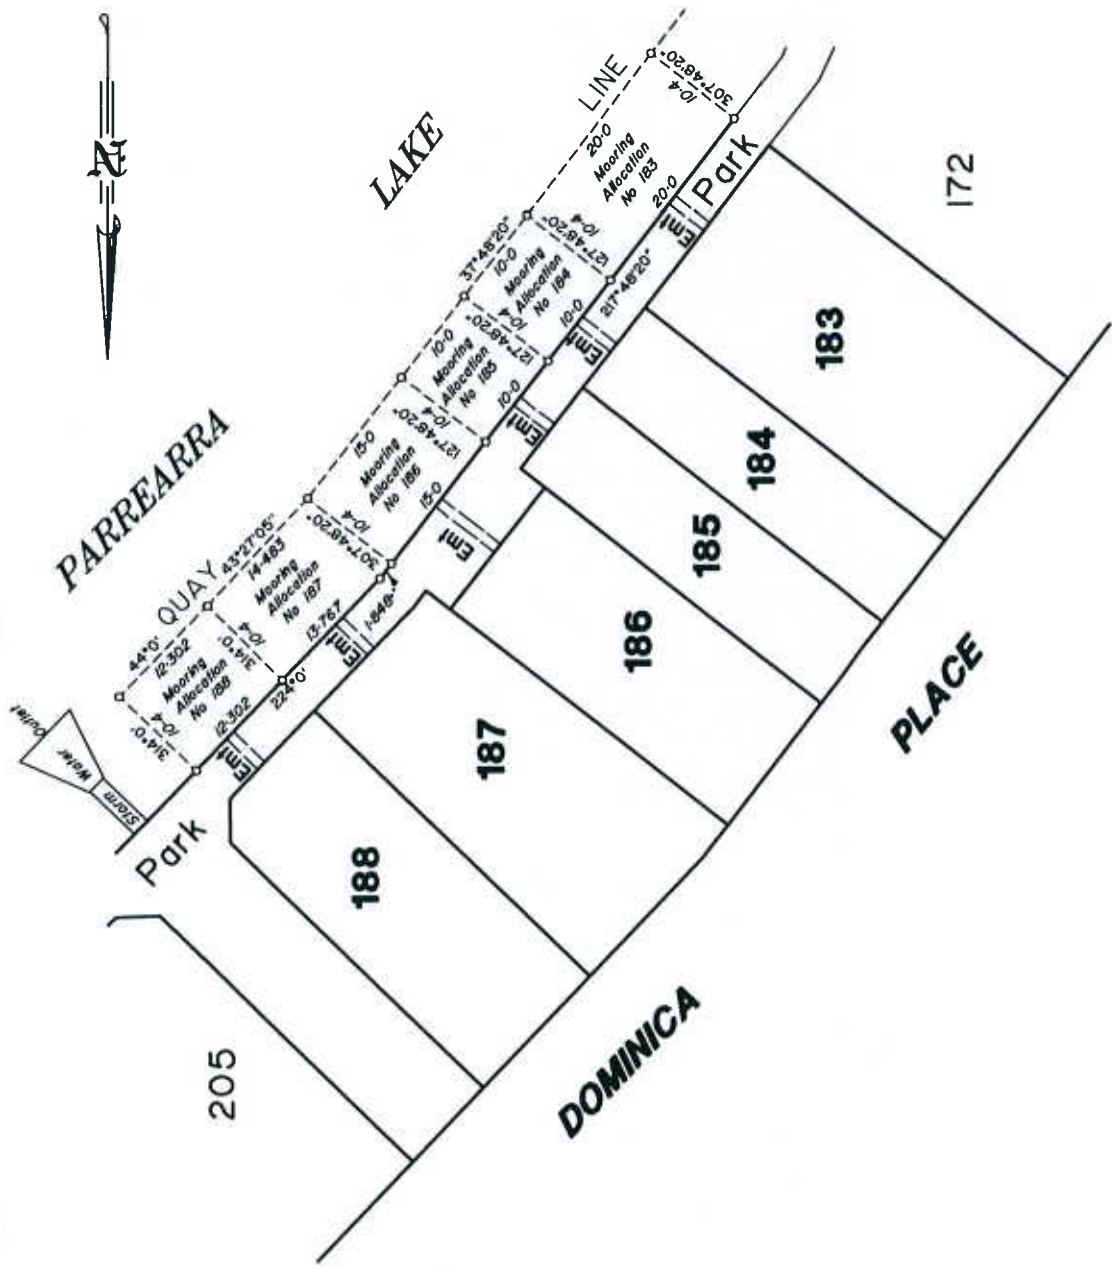

NOTES

1. Caloundra City Council is the trustee of the Sport and Recreation Reserve (Parrearra Lake). No structures can be erected in Parrearra Lake before entering into a lease under Section 37 of the Land Act, 1994. The structures must be approved in accordance with the approval process and comply with the structural and operation requirements as outlined in the Parrearra Lake Management Plan.
2. A vessel berthed at a pontoon must not at any time, extend within 1.5 metres of the side boundaries of the designated Quay Line. Vessels must comply with all other Mooring Arrangements as specified in the Parrearra Lake Management Plan.
3. Restrictions to the height and beam of vessels may apply due to The Nicklin Way bridges and the width of the lock.
4. The lake area is a Sport and Recreation Reserve under the control of the Caloundra City Council and the use of the lake and environs is subject to control by local laws.
5. The mooring allocations shown on this plan are only for the potential use of lots 183-188 as shown on this plan.
6. Underwater stormwater outlets into the lake may impact on some of the mooring allocations shown on this plan. A user should satisfy themselves on this matter.
7. The easement shown across the park from a lot to a quay line allocation, is for the purpose of an underground extension of the water and electricity services from that lot to the mooring


<p>J.B. Goodwin, Midson & Partners consulting surveyors, planners and development consultants</p> 		<p>LENSWORTH KAWANA WATERS PTY LTD Quay Line Plan for Lots 183-188 Stage 3 Kawana Island</p>		<p>AMDT A</p>	
<p>Drawn: JAH</p>	<p>24-08-01</p>	<p>Designed: [] Checked: []</p>	<p>scale: 1:500</p>	<p>ref no: P-2780-92-1</p>	<p>A3</p>
<p>Surveys: [] Drawn: []</p>		<p>FBK [] LFK []</p>	<p>528 Concession Drive, Toroway, 4085 Ph (07)5493 2161 Fax (07)5493 3844 2/12 Technology Drive, Wana 4575 Ph (07)5493 1907 Fax (07)5493 4880 2 Park Street, Boonah 4310 Ph/Fax (07)5493 1506 <small>member firm of the association of consulting engineers</small></p>		
<p>Amdt A 15-11-01 MK (CCC) Amend Notes</p>					



NOTES

1. Caloundra City Council is the trustee of the Sport and Recreation Reserve (Parrearra Lake). No structures can be erected in Parrearra Lake before entering into a lease under Section 57 of the Land Act, 1994. The structures must be approved in accordance with the approval process and comply with the structural and operation requirements as outlined in the Parrearra Lake Management Plan.
2. A vessel berthed at a pontoon must not at any time, extend within 1.5 metres of the side boundaries of the designated Quay Line. Vessels must comply with all other Mooring Arrangements as specified in the Parrearra Lake Management Plan.
3. Restrictions to the height and beam of vessels may apply due to The Nicklin Way bridges and the width of the lock.
4. The lake area is a Sport and Recreation Reserve under the control of the Caloundra City Council and the use of the lake and environs is subject to control by local laws.
5. The mooring allocations shown on this plan are only for the potential use of lots 205-208 as shown on this plan.
6. Underwater stormwater outlets into the lake may impact on some of the mooring allocations shown on this plan. A user should satisfy themselves on this matter.
7. The easement shown across the park from a lot to a quay line allocation, is for the purpose of an underground extension of the water and electricity services from that lot to the mooring


<p>J.B. Goodwin, Midson & Partners consulting surveyors, planners and development consultants</p> <p>CSIHP</p>		<p>Surveyed Drawn</p>	<p>JAH</p>	<p>24-08-01</p>	<p>Designed Checked</p>	<p>SJG</p>	<p>FBK LBK</p>	<p>scale: 1:500</p>	<p>ref no P-2780-92-2</p>	<p>AMDT A</p>
<p>LENSWORTH KAWANA WATERS PTY LTD</p> <p>Quay Line plan for Lots 205-208 Stage 3 Kawana Island</p>										
<p>828 Concession Drive Toowoomba 4088 Ph (07)3870 2161 Fax (07)3870 3844</p> <p>2/12 Technology Drive Warana 4575 Ph (07)5495 1707 Fax (07)5493 4860</p> <p>2 Park Street Boonah 4310 Ph/Fax (07)5433 1568</p> <p>member firm of the association of consulting engineers</p>										
<p>Amdt A 15-11-01 NK (CCC) Amend Notes</p>										

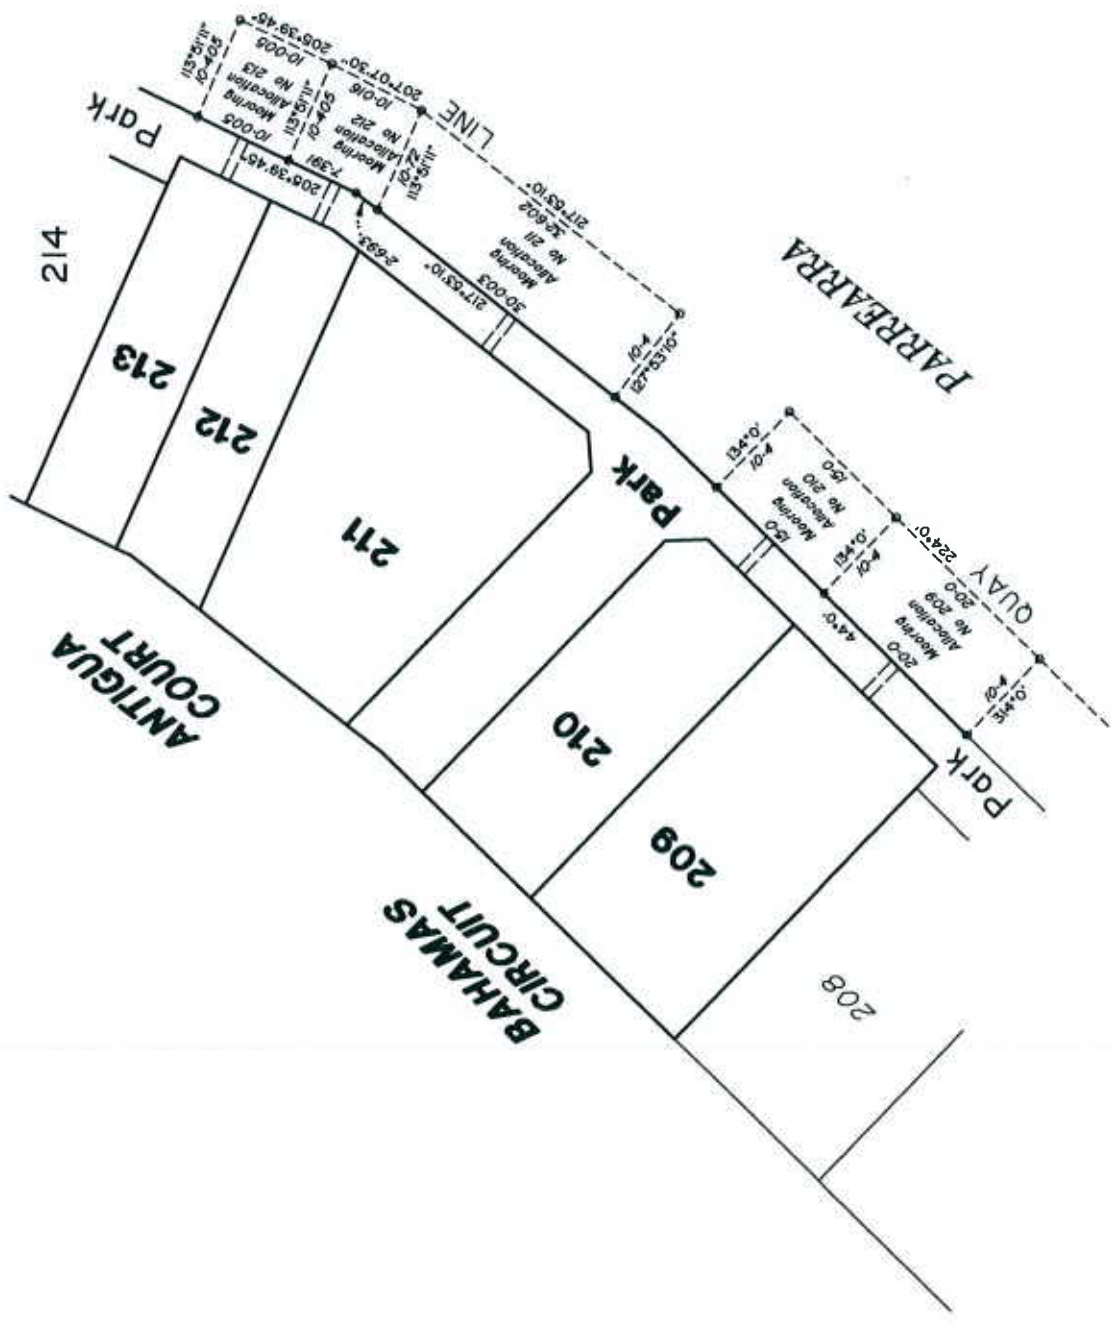

NOTES

1. Caloundra City Council is the trustee of the Sport and Recreation Reserve (Parrerra Lake). No structures can be erected in Parrerra Lake before entering into a lease under Section 57 of the Land Act 1994. The structures must be approved in accordance with the approval process and comply with the structural and operation requirements as outlined in the Parrerra Lake Management Plan.
2. A vessel berthed at a pontoon must not at any time, extend within 1.5 metres of the side boundaries of the designated Quay Line. Vessels must comply with all other Mooring Arrangements as specified in the Parrerra Lake Management Plan.
3. Restrictions to the height and beam of vessels may apply due to The Wickin Way bridges and the width of the lock.
4. The lake area is a Sport and Recreation Reserve under the control of the Caloundra City Council and the use of the lake and environs is subject to control by local laws.
5. The mooring allocations shown on this plan are only for the potential use of lots 209-231 as shown on this plan.
6. Underwater stormwater outlets into the lake may impact on some of the mooring allocations shown on this plan. A user should satisfy themselves on this matter.
7. The easement shown across the park from a lot to a quay line allocation, is for the purpose of an underground extension of the water and electricity services from that lot to the mooring.

LENSWORTH KAWANA WATERS PTY LTD		AMDT A
Quay Line Plan for Lots 209-213 Stage 4 Kawana Island		
scale: 1:500		ref no P-2780-93-I
J.B. Goodwin, Midson & Partners consulting surveyors, planners and development consultants 		Brisbane 622 Concoran Drive Torowang 4068 Ph (07)3670 2161 Fax (07)3670 3944 Kawana 2/12 Technology Drive Warrig 4575 Ph (07)5493 1707 Fax (07)5493 4880 Bnooth 3 Park Street, Bnooth 4310 Ph/Fax (07)5483 1506 <small>member firm of the association of consulting engineers</small>
Drawn	JAH	29-08-01
Designed	SUG	FBK
Checked	LBK	LBK

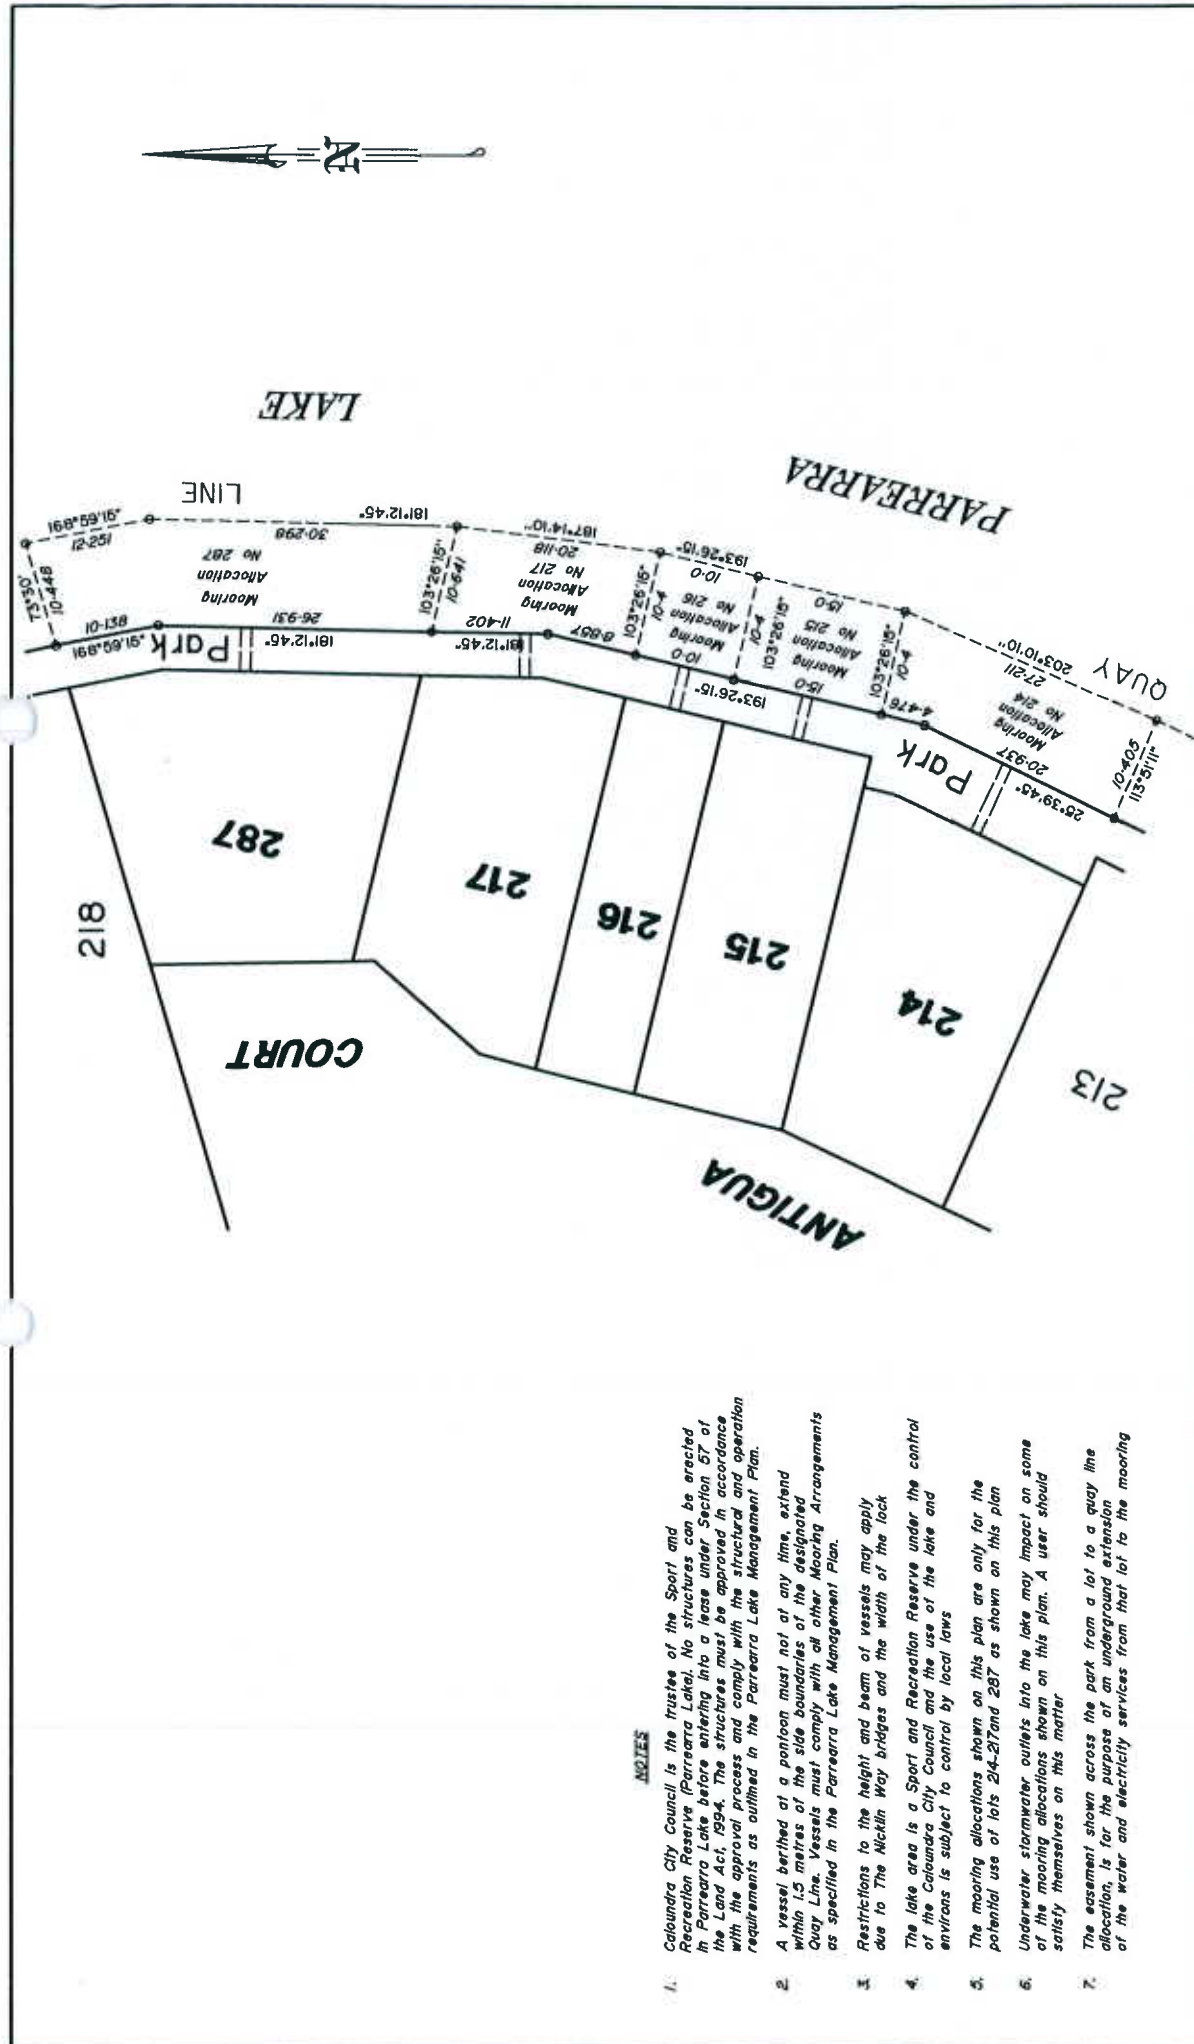


NOTES

1. Caloundra City Council is the trustee of the Sport and Recreation Reserve (Parrearra Lake). No structures can be erected in Parrearra Lake before entering into a lease under Section 37 of the Land Act, 1954. The structures must be approved in accordance with the approval process and comply with the structural and operation requirements as outlined in the Parrearra Lake Management Plan.
2. A vessel berthed at a pontoon must not at any time, extend within 1.5 metres of the side boundaries of the designated Quay Line. Vessels must comply with all other Mooring Arrangements as specified in the Parrearra Lake Management Plan.
3. Restrictions to the height and beam of vessels may apply due to The Micklin Way bridges and the width of the lock.
4. The lake area is a Sport and Recreation Reserve under the control of the Caloundra City Council and the use of the lake and environs is subject to control by local laws.
5. The mooring allocations shown on this plan are only for the potential use of lots 214-217 and 287 as shown on this plan.
6. Underwater stormwater outlets into the lake may impact on some of the mooring allocations shown on this plan. A user should satisfy themselves on this matter.
7. The easement shown across the park from a lot to a quay line allocation, is for the purpose of an underground extension of the water and electricity services from that lot to the mooring

J.B. Goodwin, Midson & Partners consulting surveyors, planners and development consultants 		Brisbane 628 Coronation Drive Toonang 4088 Ph (07)3670 2161 Fax (07)3670 3844		Kowara 2/12 Technology Drive Warrara 4575 Ph (07)5463 1707 Fax (07)5463 4880		Boonah 2 Park Street Boonah 4310 Ph/Fax (07)5463 1586		include firm of the installation of unloading ramps	
		Designed S/JG	Checked S/JG	FBK	LBK	Scale: 1:500	ref no P-2780-93-2	AMDT A	A3
LENS WORTH KAWANA WATERS PTY LTD Quay Line Plan for Lots 214-217 and 287 Stage 4 Kawana Island									
Amdt A MK 15-11-01 (CCC) Amend Notes									



PARREARRA

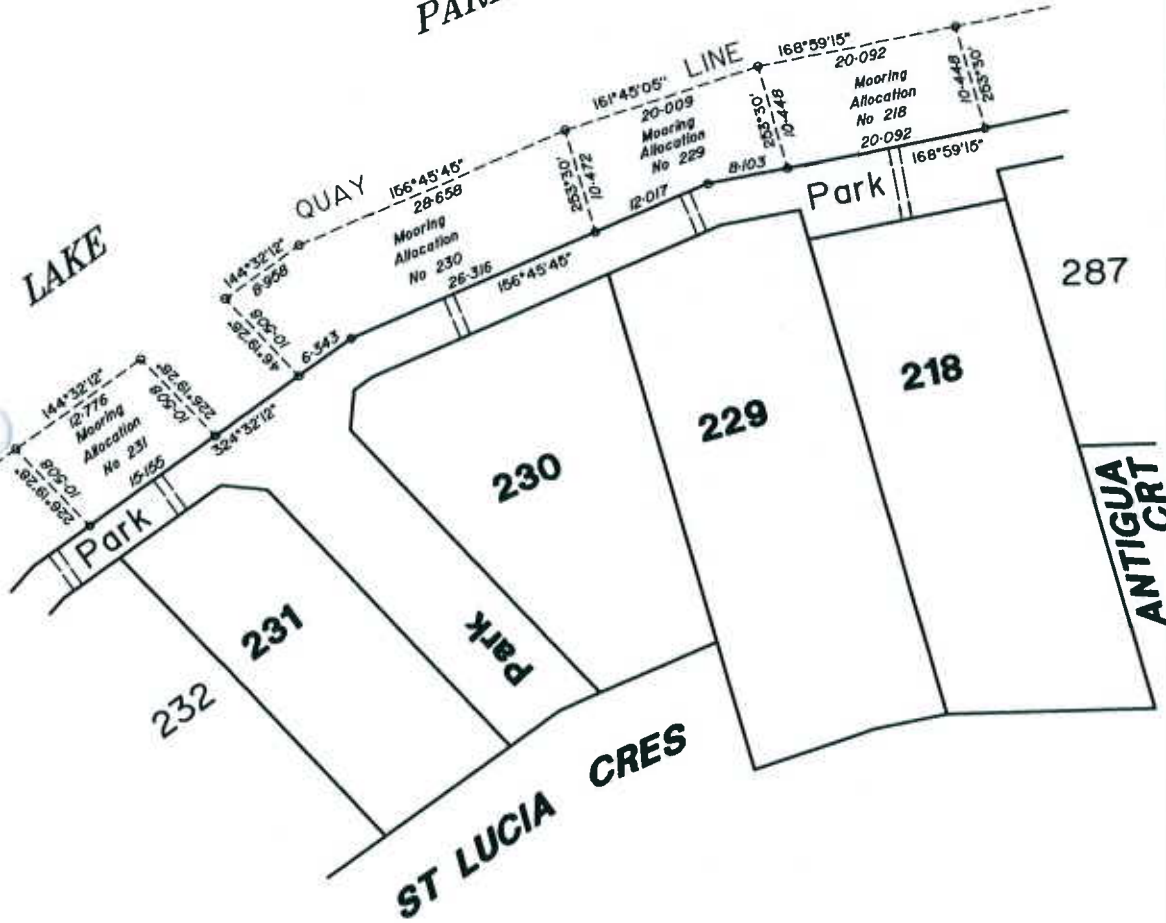

NOTES

1. Cabandra City Council is the trustee of the Sport and Recreation Reserve (Parrearra Lake). No structures can be erected in Parrearra Lake before entering into a lease under Section 57 of the Land Act 1994. The structures must be approved in accordance with the approval process and comply with the structural and operation requirements as outlined in the Parrearra Lake Management Plan.
2. A vessel berthed at a pontoon must not at any time, extend within 1.5 metres of the side boundaries of the designated Quay Line. Vessels must comply with all other Mooring Arrangements as specified in the Parrearra Lake Management Plan.
3. Restrictions to the height and beam of vessels may apply due to The Nicklin Way bridges and the width of the lock.
4. The lake area is a Sport and Recreation Reserve under the control of the Cabandra City Council and the use of the lake and environs is subject to control by local laws.
5. The mooring allocations shown on this plan are only for the potential use of lots 218, 229-231 as shown on this plan.
6. Underwater stormwater outlets into the lake may impact on some of the mooring allocations shown on this plan. A user should satisfy themselves on this matter.
7. The easement shown across the park from a lot to a quay line allocation, is for the purpose of an underground extension of the water and electricity services from that lot to the mooring.

J.B. Goodwin, Midson & Partners consulting surveyors, planners and development consultants 		Brisbane 625 Coronation Drive, Toombong 4006 Ph: (07)3870 2161 Fax: (07)3870 3844 2/13 Technology Drive, Waters 4875 Ph: (07)5463 1007 Fax: (07)5463 4880 2 Park Street, Staines 4310 Ph/Fax: (07)9463 1996 <small>member firm of the association of consulting engineers</small>		AMDT A
Surveyed Drawn	JAH 29-08-01	Designed Checked	SUG	
Scale: 1:500		ref no P-2780-93-3		
AMDT A MK 15/1-01 (CCC) Amend Notes				

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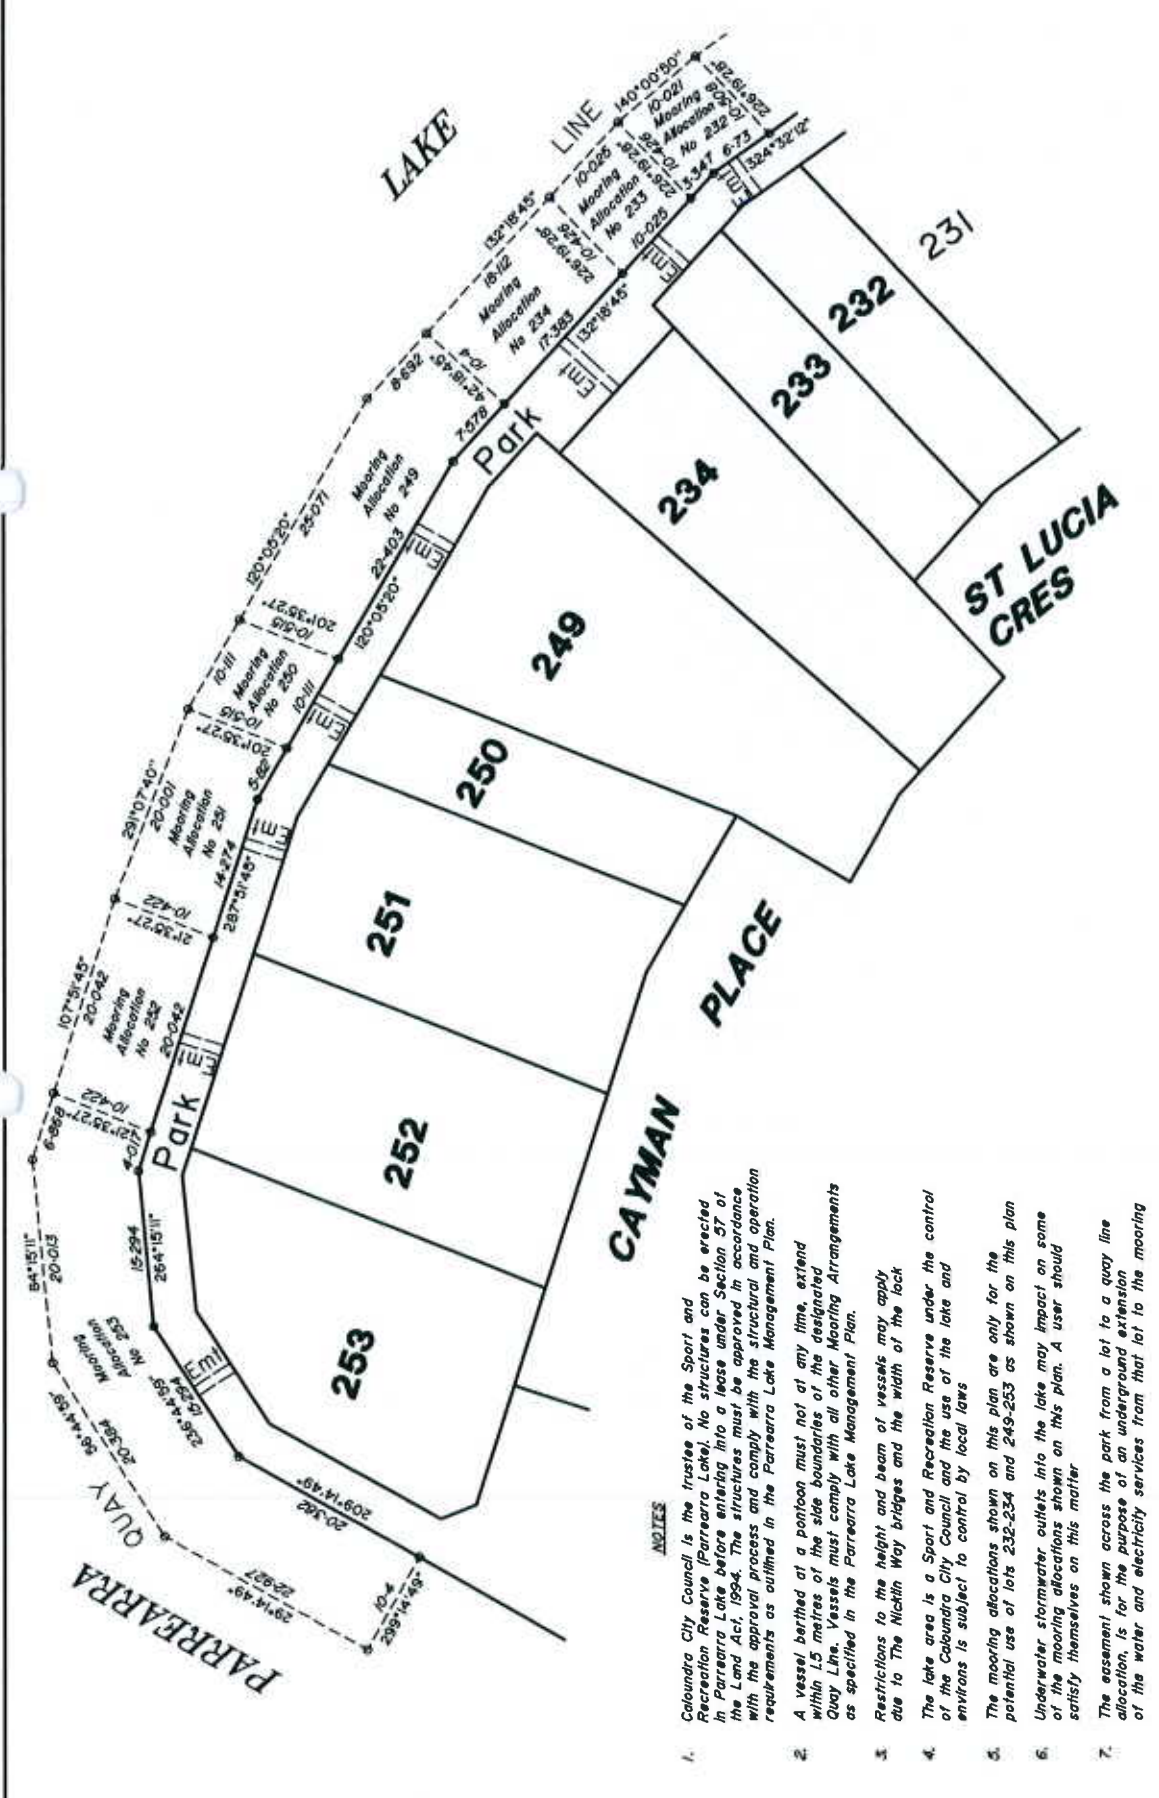
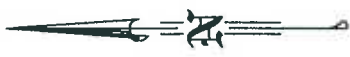
Quay Line Plan for Lots 218, and 229-231 Stage 4 Kawana Island

scale: 1:500 ref no P-2780-93-3

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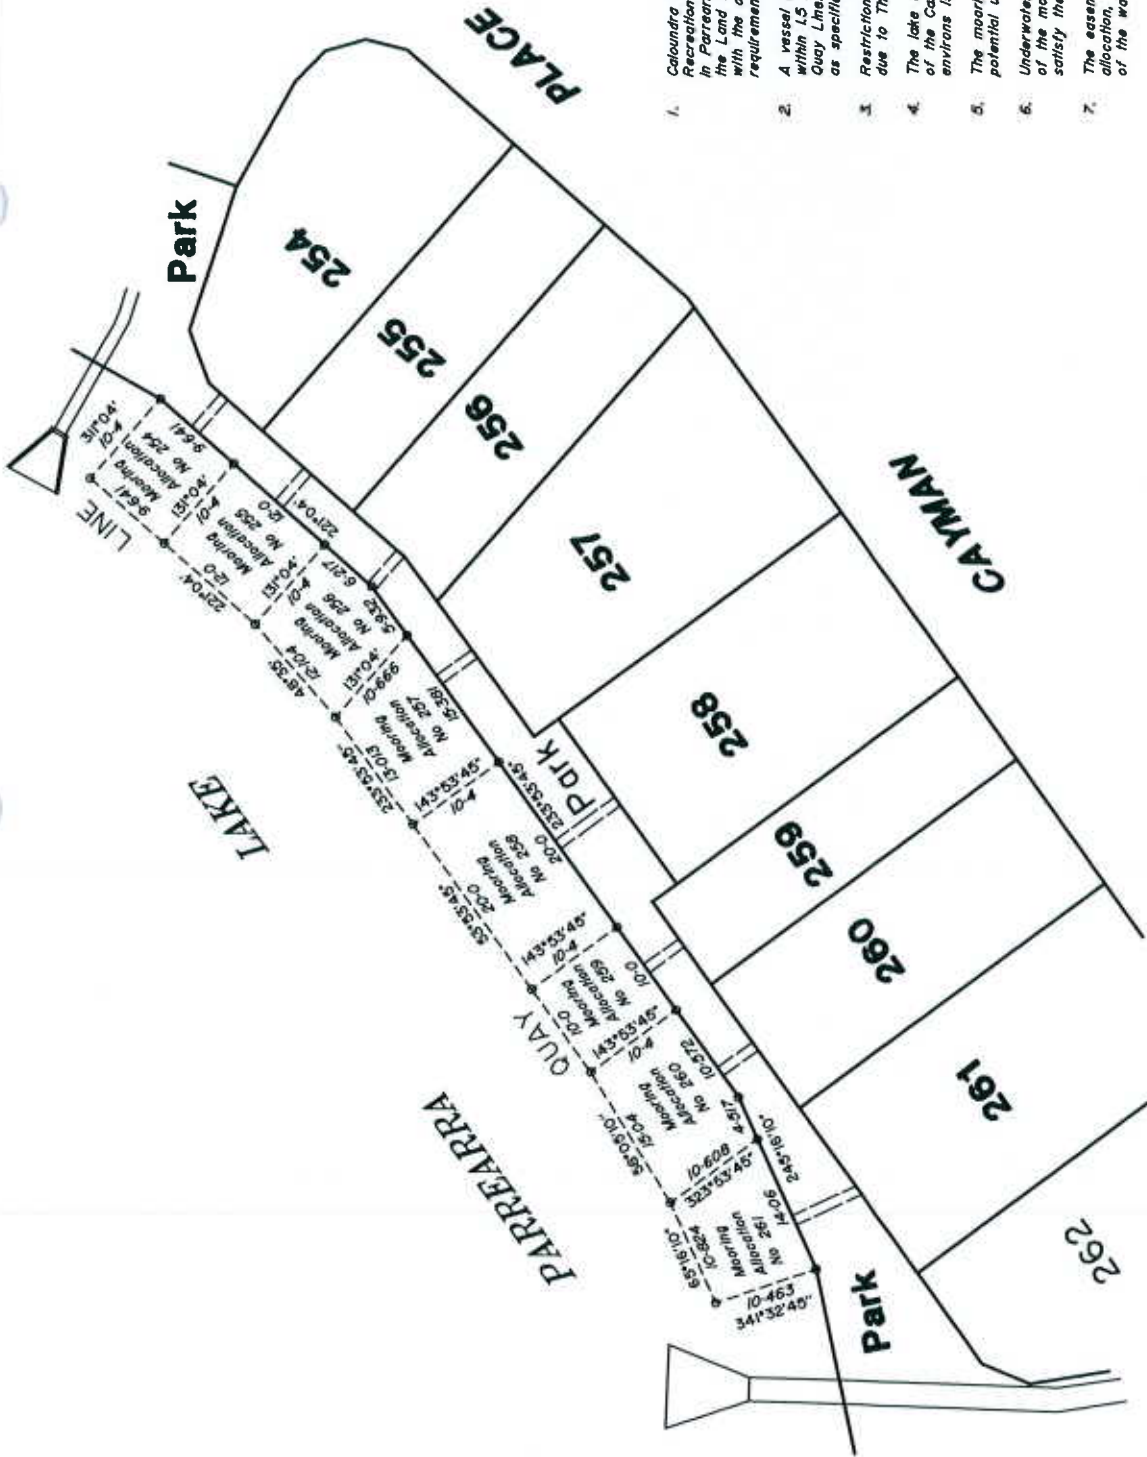
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NOTES

1. Caloundra City Council is the trustee of the Sport and Recreation Reserve (Parrearra Lake). No structures can be erected in Parrearra Lake before entering into a lease under Section 57 of the Land Act, 1994. The structures must be approved in accordance with the approval process and comply with the structural and operation requirements as outlined in the Parrearra Lake Management Plan.
2. A vessel berthed at a pontoon must not at any time, extend within 1.5 metres of the side boundaries of the designated Quay Line. Vessels must comply with all other Mooring Arrangements as specified in the Parrearra Lake Management Plan.
3. Restrictions to the height and beam of vessels may apply due to The Nicklin Way bridges and the width of the lock.
4. The lake area is a Sport and Recreation Reserve under the control of the Caloundra City Council and the use of the lake and environs is subject to control by local laws.
5. The mooring allocations shown on this plan are only for the potential use of lots 232-234 and 249-253 as shown on this plan.
6. Underwater stormwater outlets into the lake may impact on some of the mooring allocations shown on this plan. A user should satisfy themselves on this matter.
7. The easement shown across the park from a lot to a quay line allocation, is for the purpose of an underground extension of the water and electricity services from that lot to the mooring.

<p>LENSWORTH KAWANA WATERS PTY LTD</p> <p>Quay Line Plan for Lots 232-234 and 249-253 Stage 4 Kawana Island</p>		<p>AMDT</p> <p>B</p>
<p>628 Coronation Drive Toowoomba 4068 Ph (07)3670 2161 Fax (07)3670 3644</p> <p>2/12, Technology Drive Warrara 4575 Ph (07)5483 1707 Fax (07)5483 4680</p> <p>3 Park Street, Brisbane 4110 Ph/Fax (07)5483 1566</p> <p>member firm of the institutions of measuring engineers</p>		<p>scale: 1:500</p> <p>ref no P-2780-93-4</p>
<p>J.B. Goodwin, Midson & Partners consulting surveyors, planners and development consultants</p>	<p>Surveyed: <input type="checkbox"/> JAH</p> <p>Drawn: <input type="checkbox"/> JAH</p> <p>29-08-01</p>	<p>Designed: <input type="checkbox"/> SUG</p> <p>Checked: <input type="checkbox"/> SUG</p> <p>FBK</p> <p>LBK</p>
<p>Amend B MK 15-11-01 (CCC) Amend Notes</p> <p>Amend A 15-10-01 SUG Amend Mooring Allocation for Lot 232</p>		




NOTES

1. Caloundra City Council is the trustee of the Sport and Recreation Reserve (Parrearra Lake). No structures can be erected in Parrearra Lake before entering into a lease under Section 57 of the Land Act, 1954. The structures must be approved in accordance with the approval process and comply with the structural and operation requirements as outlined in the Parrearra Lake Management Plan.
2. A vessel berthed at a pontoon must not at any time, extend within 1.5 metres of the side boundaries of the designated Quay Line. Vessels must comply with all other Mooring Arrangements as specified in the Parrearra Lake Management Plan.
3. Restrictions to the height and beam of vessels may apply due to The McKinn Way bridges and the width of the lock.
4. The lake area is a Sport and Recreation Reserve under the control of the Caloundra City Council and the use of the lake and environs is subject to control by local laws.
5. The mooring allocations shown on this plan are only for the potential use of lots 254-261 as shown on this plan.
6. Underwater stormwater outlets into the lake may impact on some of the mooring allocations shown on this plan. A user should satisfy themselves on this matter.
7. The easement shown across the park from a lot to a quay line allocation, is for the purpose of an underground extension of the water and electricity services from that lot to the mooring.

<p>LENSWORTH KAWANA WATERS PTY LTD AMDT C</p> <p>Quay Line Plan for Lots 254-261 Stage 4 Kawana Island</p>		<p>scale: 1:500</p> <p>ref no P-2780-93-5</p>	
<p>J.B. Goodwin, Midson & Partners consulting surveyors, planners and development consultants</p> <p>2/12 Technology Drive Warrago 4575 Ph (07)5443 1707 Fax (07)5443 4880 2 Park Street Boonah 4310 Ph/Fax (07)5443 1396</p> <p>member firm of the association of consulting engineers</p>		<p>Brisbane 828 Corporation Drive Toowoomba 4008 Ph (07)3870 2161 Fax (07)3870 3944</p> <p>Kawana Ph (07)5443 1707 Fax (07)5443 4880</p> <p>Boonah Ph/Fax (07)5443 1396</p>	
<p>Survived Drawn</p>	<p>JAH</p>	<p>29-08-01</p>	<p>Designed Checked S/JG</p>
<p>Amtd C MK 15-11-01 (CCC) Amend Notes and SUG 15-11-01 Amend Mooring Allocation Lot 254 Amtd B SUG 15-10-01 Amend Mooring Allocations and Lots 255-257 Amtd A SUG 04-10-01 Amend Quay Line Allocation for Lot 261</p>		<p>A3</p>	

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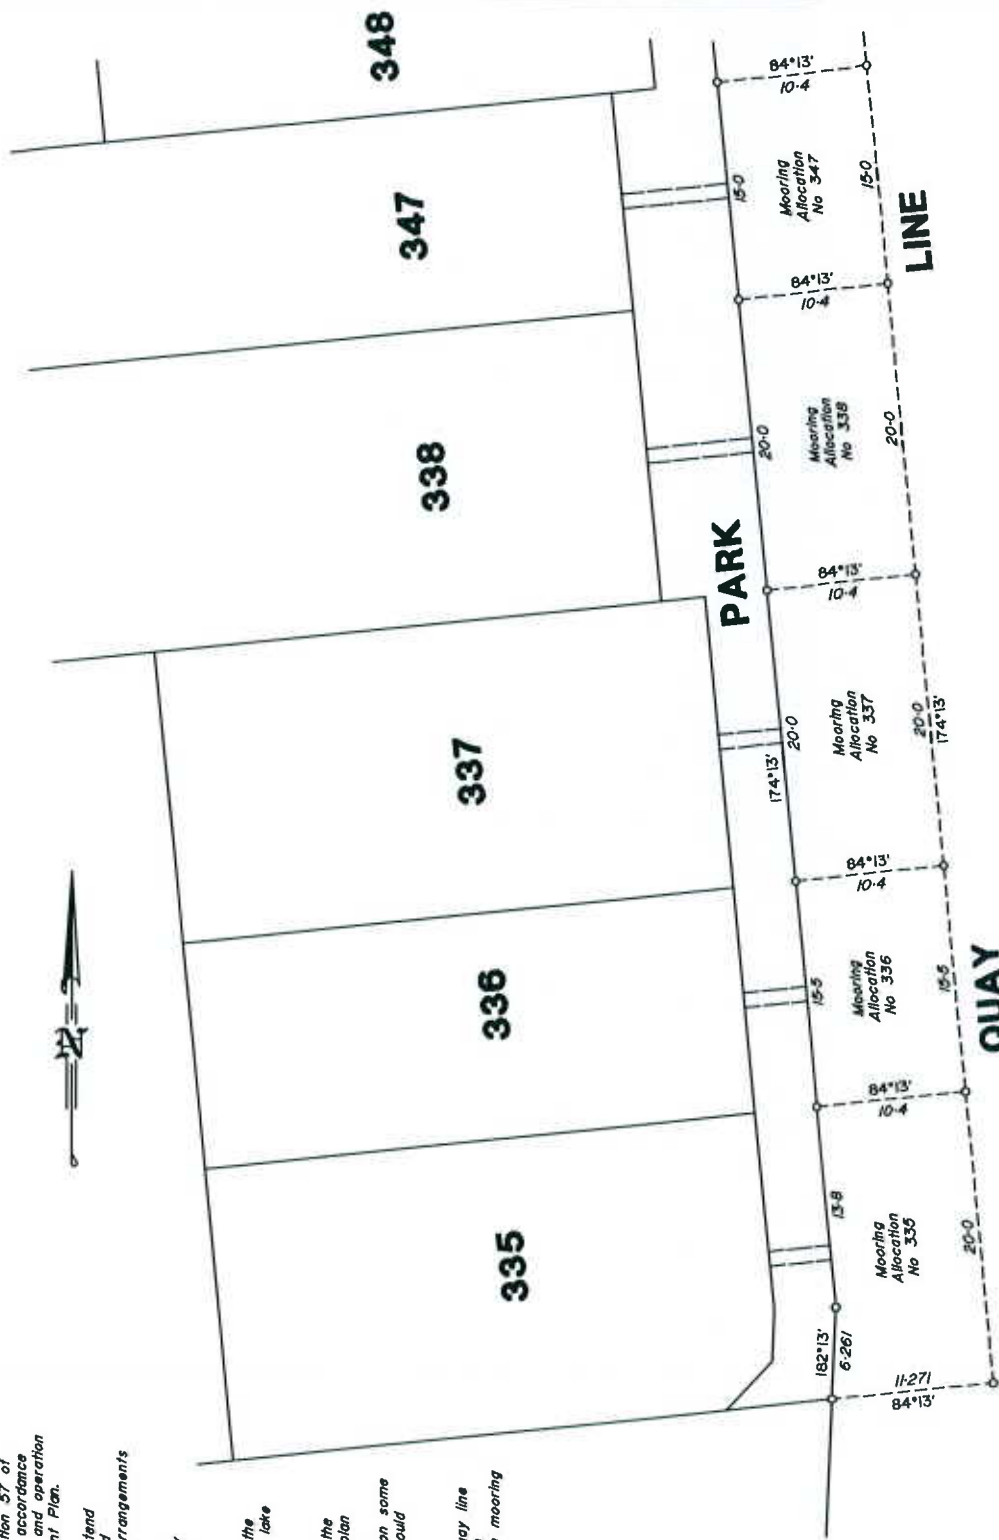
1. Colandra City Council is the trustee of the Sport and Recreation Reserve (Parrearra Lake). No structures can be erected in Parrearra Lake before entering into a lease under Section 37 of the Land Act, 1994. The structures must be approved in accordance with the approval process and comply with the structural and operation requirements as outlined in the Parrearra Lake Management Plan.
2. A vessel berthed at a pontoon must not at any time, extend within 1.5 metres of the side boundaries of the designated Quay Line. Vessels must comply with all other Mooring Arrangements as specified in the Parrearra Lake Management Plan.
3. Restrictions to the height and beam of vessels may apply due to The Nichlin Way, Kawana Island Boulevard bridges and the width of the lock.
4. The lake area is a Sport and Recreation Reserve under the control of the Colandra City Council and the use of the lake and environs is subject to control by local laws.
5. The mooring allocations shown on this plan are only for the potential use of lots 322-326 as shown on this plan.
6. Underwater stormwater outlets into the lake may impact on some of the mooring allocations shown on this plan. A user should satisfy themselves on this matter.
7. The easement shown across the park from a lot to a quay line allocation, is for the purpose of an underground extension of the water and electricity services from that lot to the mooring

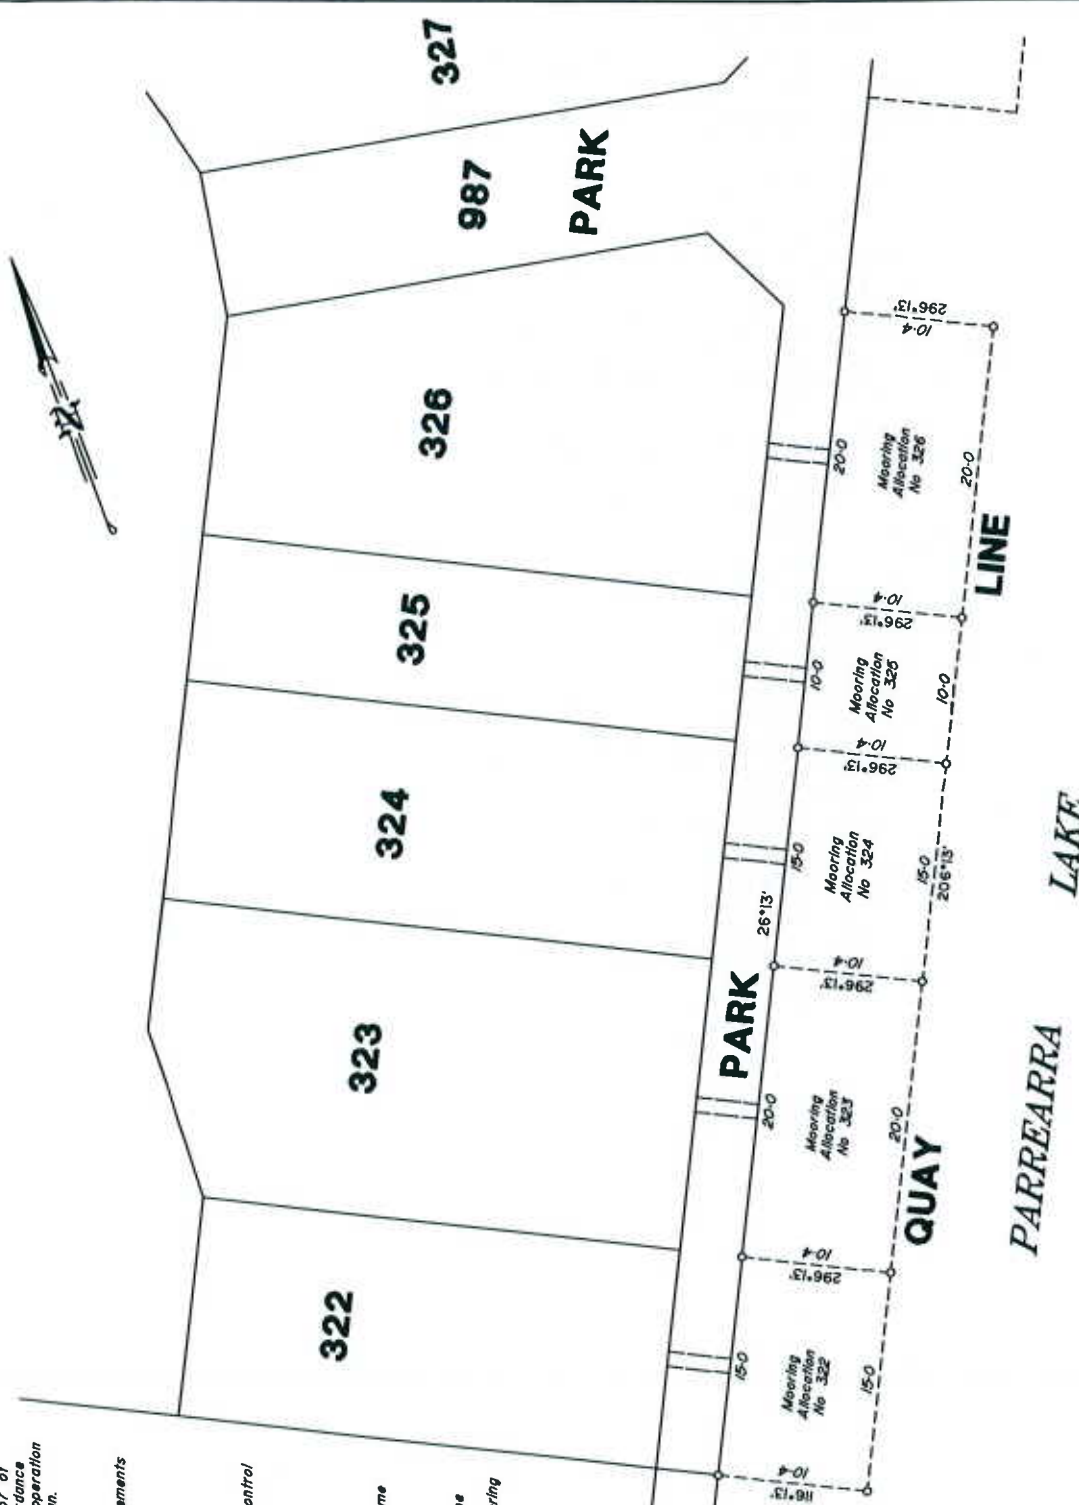

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J.B. Goodwin, Midson & Partners 		consulting engineers town planners and development consultants			

NOTES

1. Caloundra City Council is the trustee of the Sport and Recreation Reserve (Parrearra Lake). No structures can be erected in Parrearra Lake before entering into a lease under Section 57 of the Land Act, 1994. The structures must be approved in accordance with the approval process and comply with the structural and operation requirements as outlined in the Parrearra Lake Management Plan.
2. A vessel berthed at a pontoon must not at any time, extend within 1.5 metres of the side boundaries of the designated Quay Line. Vessels must comply with all other Mooring Arrangements as specified in the Parrearra Lake Management Plan.
3. Restrictions to the height and beam of vessels may apply due to The Nichlin Way, Kawana Island Boulevard bridges and the width of the lock.
4. The lake area is a Sport and Recreation Reserve under the control of the Caloundra City Council and the use of the lake and environs is subject to control by local laws.
5. The mooring allocations shown on this plan are only for the potential use of lots 335-338 & 347 as shown on this plan.
6. Underwater stormwater outlets into the lake may impact on some of the mooring allocations shown on this plan. A user should satisfy themselves on this matter.
7. The easement shown across the park from a lot to a quay line allocation, is for the purpose of an underground extension of the water and electricity services from that lot to the mooring



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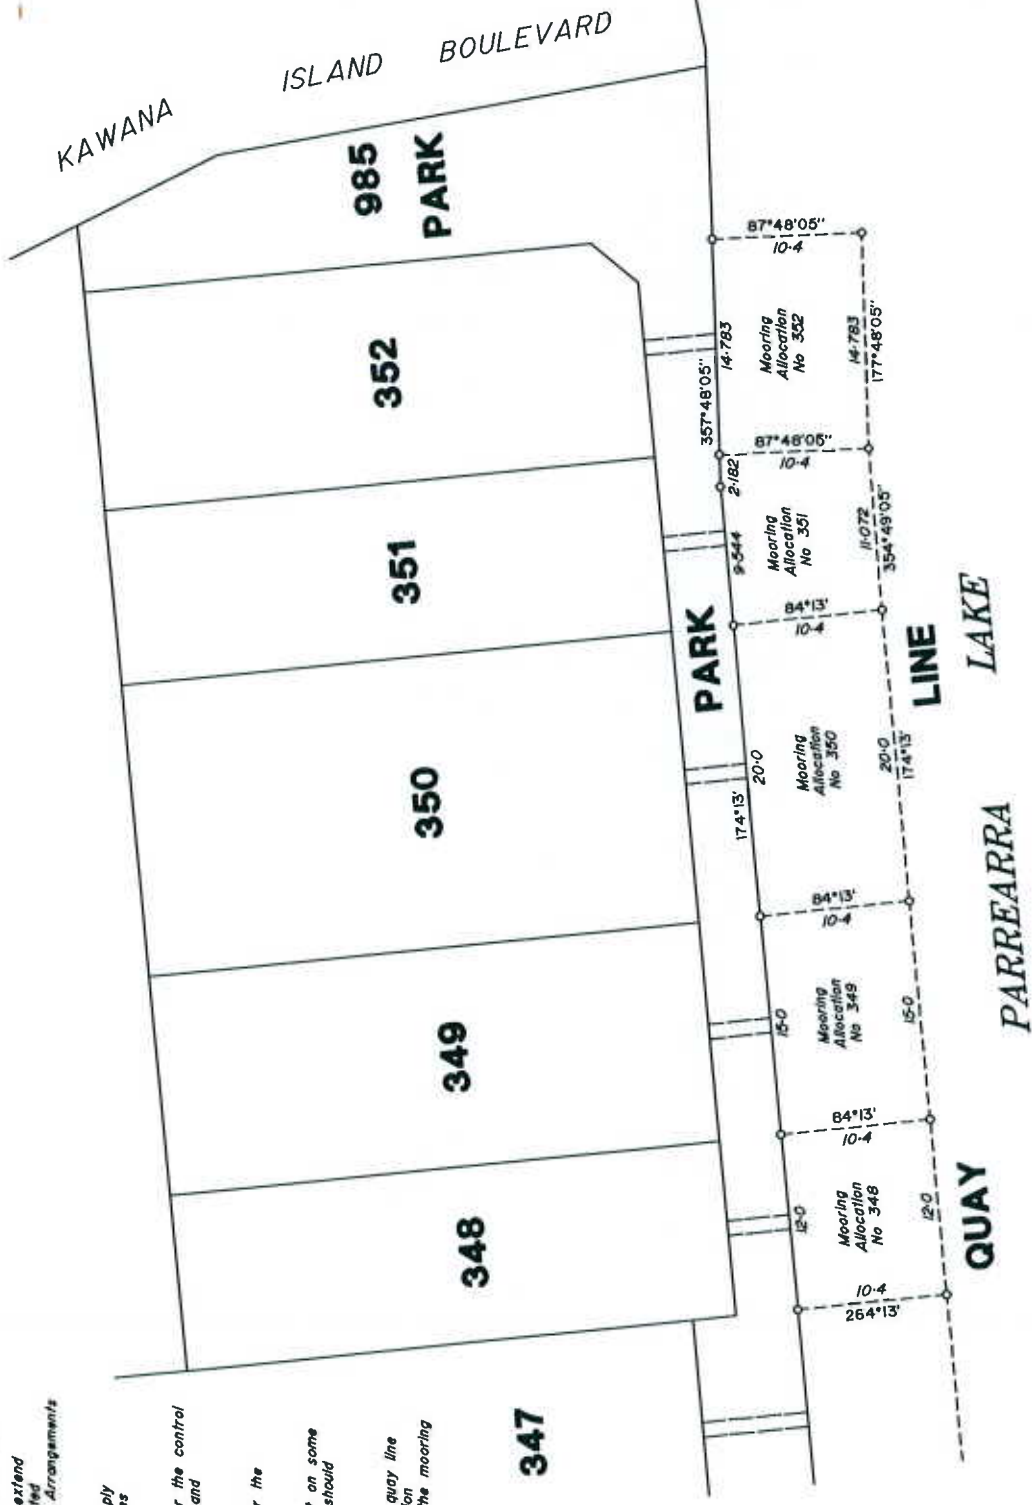
LENSWORTH KAWANA WATERS PTY LTD AMDT
Quay Line Plan for Lots 335-338 & 347
Stage 5 Kawana Island

scale: 1:350 ref no P-2780-505-3

A3

NOTES

1. Caloundra City Council is the trustee of the Sport and Recreation Reserve (Parrearra Lake). No structures can be erected in Parrearra Lake before entering into a lease under Section 37 of the Land Act, 1934. The structures must be approved in accordance with the approval process and comply with the structural and operation requirements as outlined in the Parrearra Lake Management Plan.
2. A vessel berthed at a pontoon must not at any time, extend within 1.5 metres of the side boundaries of the designated Quay Line. Vessels must comply with all other Mooring Arrangements as specified in the Parrearra Lake Management Plan.
3. Restrictions to the height and beam of vessels may apply due to The Nicklin Way, Kawana Island Boulevard bridges and the width of the lock
4. The lake area is a Sport and Recreation Reserve under the control of the Caloundra City Council and the use of the lake and environs is subject to control by local laws
5. The mooring allocations shown on this plan are only for the potential use of lots 348-352 as shown on this plan
6. Underwater stormwater outlets into the lake may impact on some of the mooring allocations shown on this plan. A user should satisfy themselves on this matter
7. The easement shown across the park from a lot to a quay line allocation, is for the purpose of an underground extension of the water and electricity services from that lot to the mooring



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Brisbane 2 Park Street Brisbane 4310
Ph/Fax 07 54431566


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 town planners and
 development consultants

LENSWORTH KAWANA WATERS PTY LTD **AMDT**
 Quay Line Plan for Lots 348-352
 Stage 5 Kawana Island
 scale: 1:350
 ref no P-2780-505-4

A3



NOTES

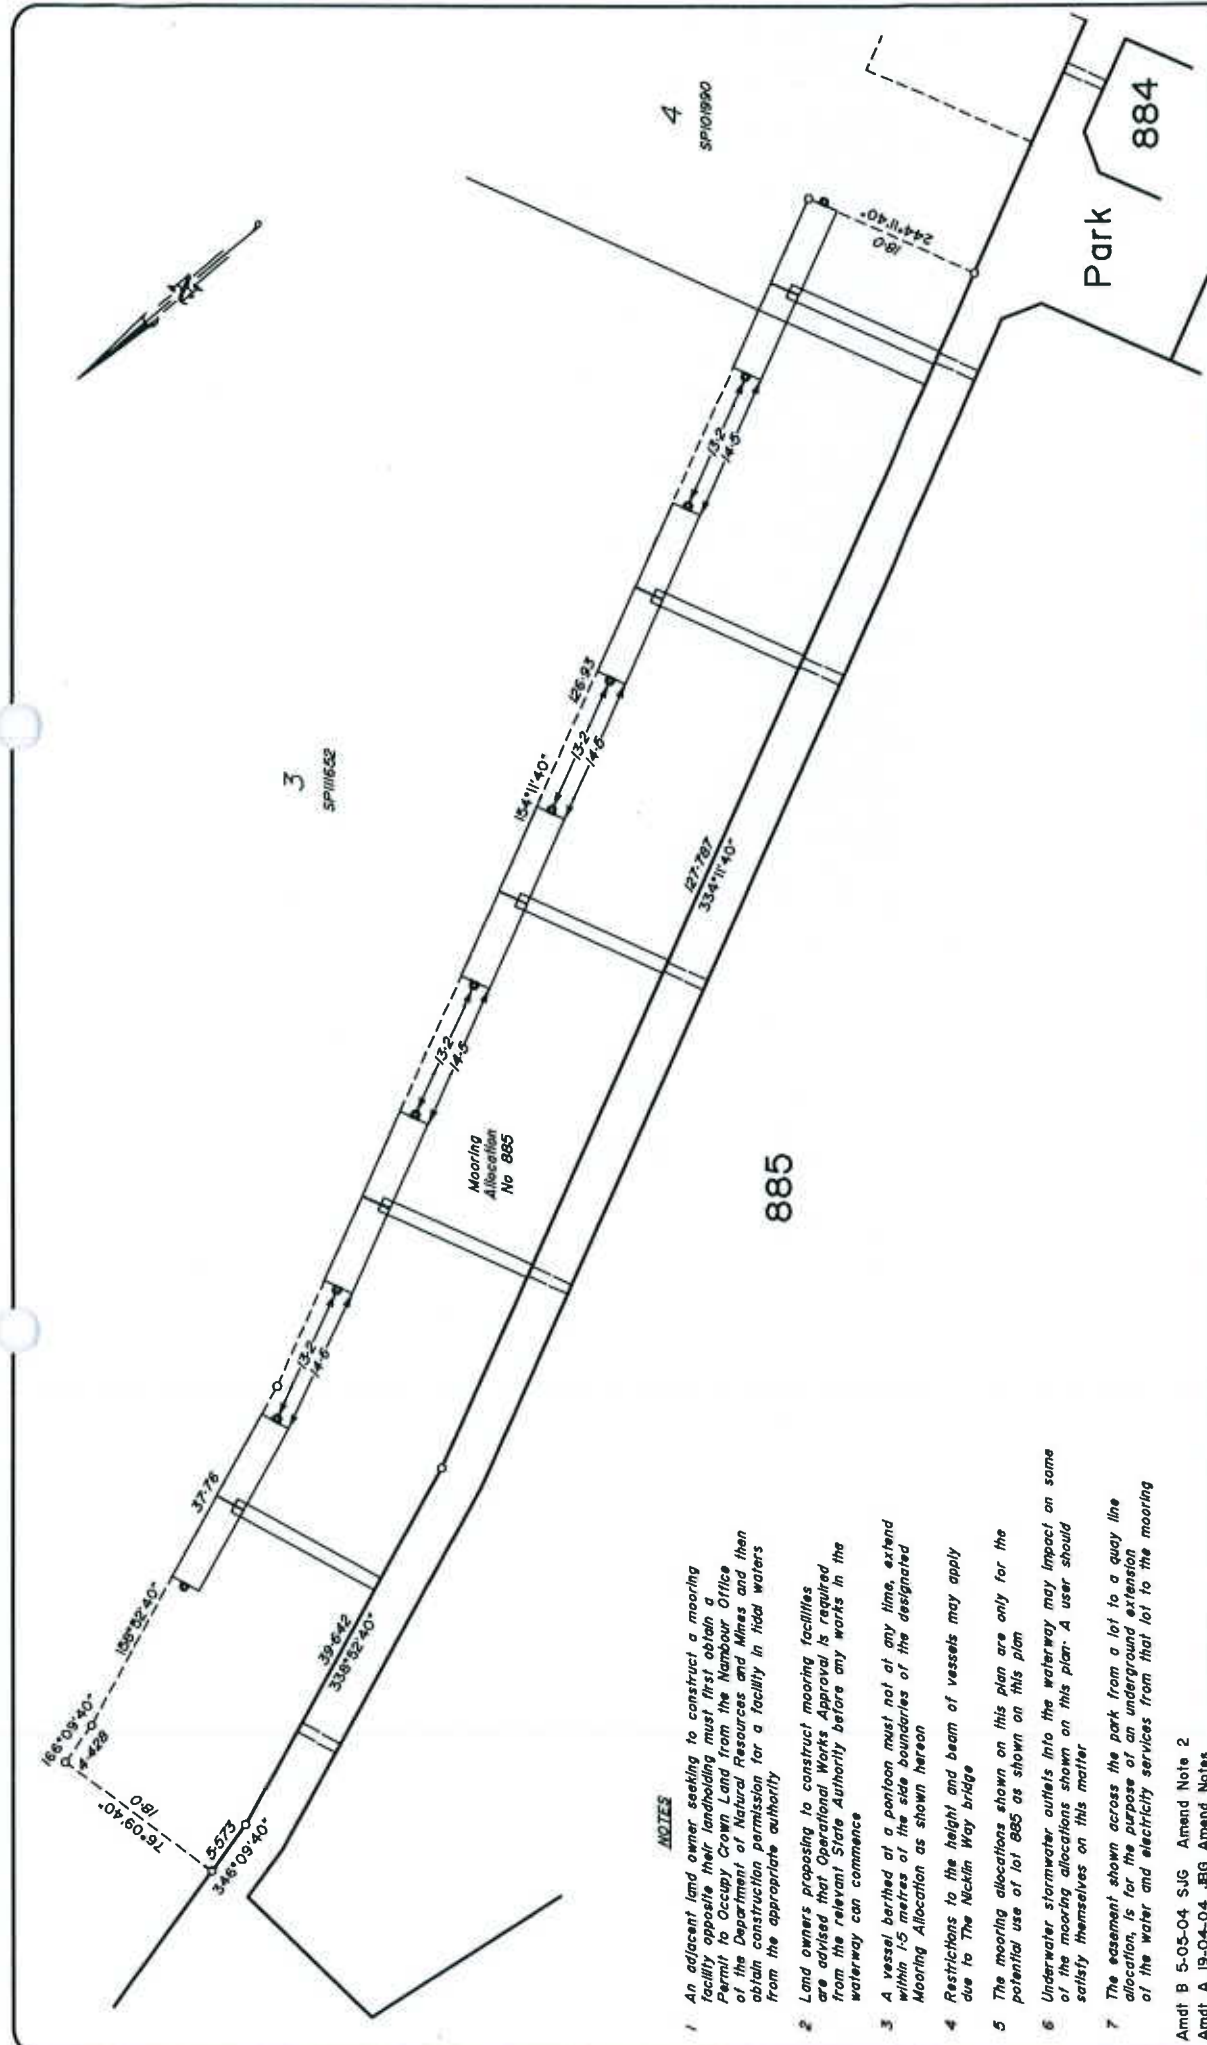- 1 An adjacent land owner seeking to construct a mooring facility opposite their landholding must first obtain a Permit to Occupy Crown Land from the Neighbour Office of the Department of Natural Resources and Mines and then obtain construction permission for a facility in tidal waters from the appropriate authority
- 2 Land owners proposing to construct mooring facilities are advised that Operational Works Approval is required from the relevant State Authority before any works in the waterway can commence
- 3 A vessel berthed at a pontoon must, not at any time, extend within 1.5 metres of the side boundaries of the designated Mooring Allocation as shown hereon
- 4 Restrictions to the height and beam of vessels may apply due to The Nicklin Way bridge
- 5 The mooring allocations shown on this plan are only for the potential use of lot 885 as shown on this plan
- 6 Underwater stormwater outlets into the waterway may impact on some of the mooring allocations shown on this plan. A user should satisfy themselves on this matter
- 7 The easement shown across the park from a lot to a quay line allocation, is for the purpose of an underground extension of the water and electricity services from that lot to the mooring

Amdt B 5-05-04 SJG Amend Note 2
 Amdt A 19-04-04 JBG Amend Notes

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 Boonah 2 Park Street, Boonah 4310
 Ph/Fax 07 54831996

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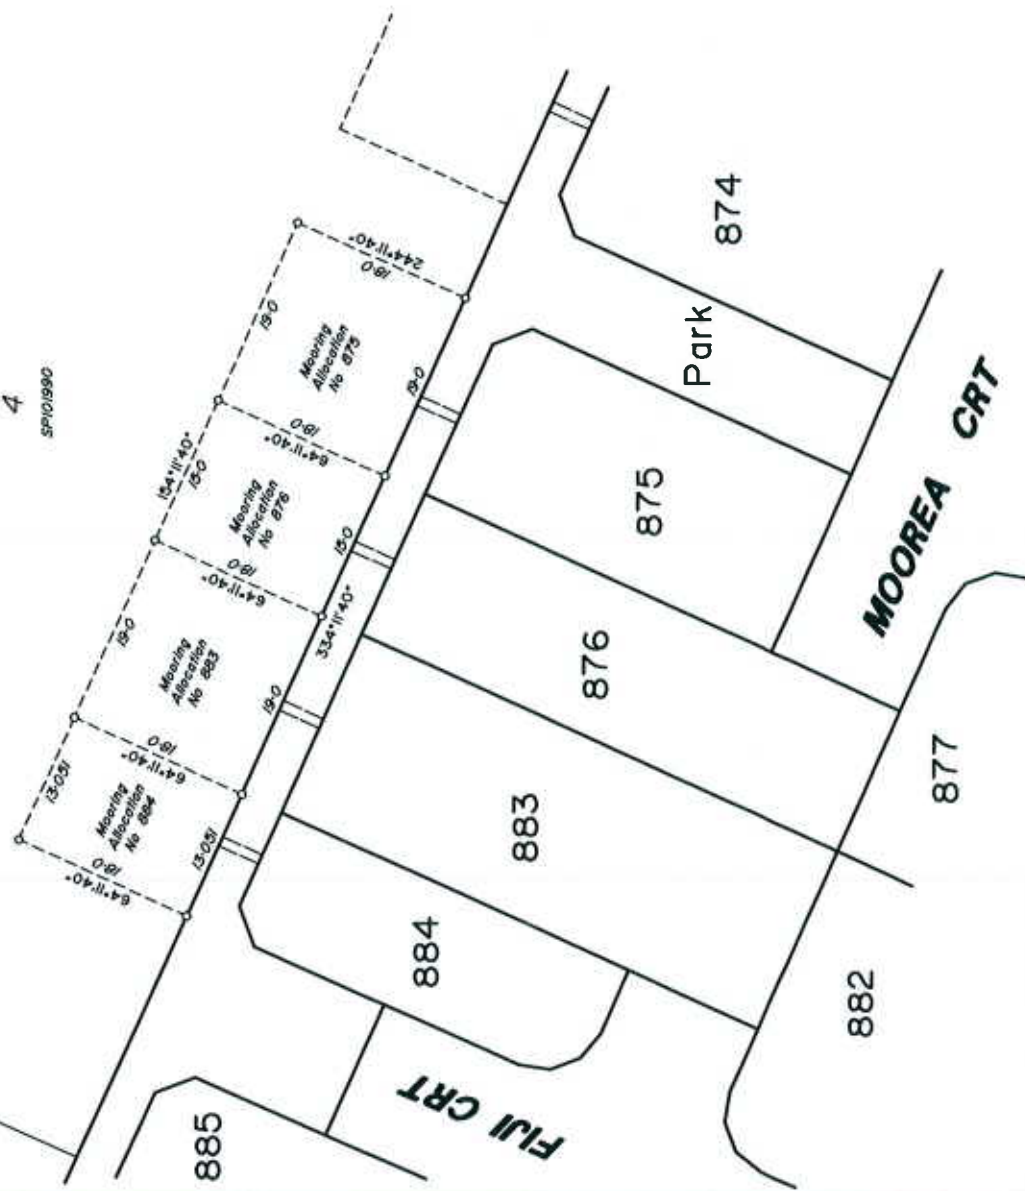
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STOCKLAND KAWANA WATERS PTY LTD AMDT
 Mooring Allocation Plan for
 Lot 885
 Stage 8 Kawana Island

scale: 1:500 ref no P-2780-536 | of 5
A3

3
SP111652

4
SP101990



NOTES

- 1 An adjacent land owner seeking to construct a mooring facility opposite their landholding must first obtain a Permit to Occupy Crown Land from the Nambour Office of the Department of Natural Resources and Mines and then obtain construction permission for a facility in tidal waters from the appropriate authority
- 2 Land owners proposing to construct mooring facilities are advised that Operational Works Approval is required from the relevant State Authority before any works in the waterway can commence
- 3 A vessel berthed at a pontoon must not at any time, extend within 1.5 metres of the side boundaries of the designated Mooring Allocation as shown herein
- 4 Restrictions to the height and beam of vessels may apply due to The Nicklin Way bridge
- 5 The mooring allocations shown on this plan are only for the potential use of lot 885 as shown on this plan
- 6 Underwater stormwater outfalls into the waterway may impact on some of the mooring allocations shown on this plan. A user should satisfy themselves on this matter
- 7 The easement shown across the park from a lot to a quay line allocation, is for the purpose of an underground extension of the water and electricity services from that lot to the mooring

Amnd B 5-05-04 SJG Amend Note 2
Amnd A 19-04-04 JBG Amend Notes




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STOCKLAND KAWANA WATERS PTY LTD AMDT
 Mooring Allocation Plan for Lots
 875, 876, 883 and 884
 Stage 8 Kawana Island
 ref no P-2780-536 2 of 5
 scale: 1:500
 B
 A3



NOTES

- 1 An adjacent land owner seeking to construct a mooring facility opposite their landholding must first obtain a Permit to Occupy Crown Land from the Nambour Office of the Department of Natural Resources and Mines and then obtain construction permission for a facility in tidal waters from the appropriate authority
- 2 Land owners proposing to construct mooring facilities are advised that Operational Works Approval is required from the relevant State Authority before any works in the waterway can commence
- 3 A vessel berthed at a pontoon must not at any time, extend within 1.5 metres of the side boundaries of the designated Mooring Allocation as shown herein
- 4 Restrictions to the height and beam of vessels may apply due to The Nicklin Way bridge
- 5 The mooring allocations shown on this plan are only for the potential use of lot 865 as shown on this plan
- 6 Underwater stormwater outlets into the waterway may impact on some of the mooring allocations shown on this plan. A user should satisfy themselves on this matter
- 7 The easement shown across the park from a lot to a quay line allocation, is for the purpose of an underground extension of the water and electricity services from that lot to the mooring

Amdt B 5-05-04 S.J.G Amend Note 2
 Amdt A 19-04-04 J.B.G Amend Notes

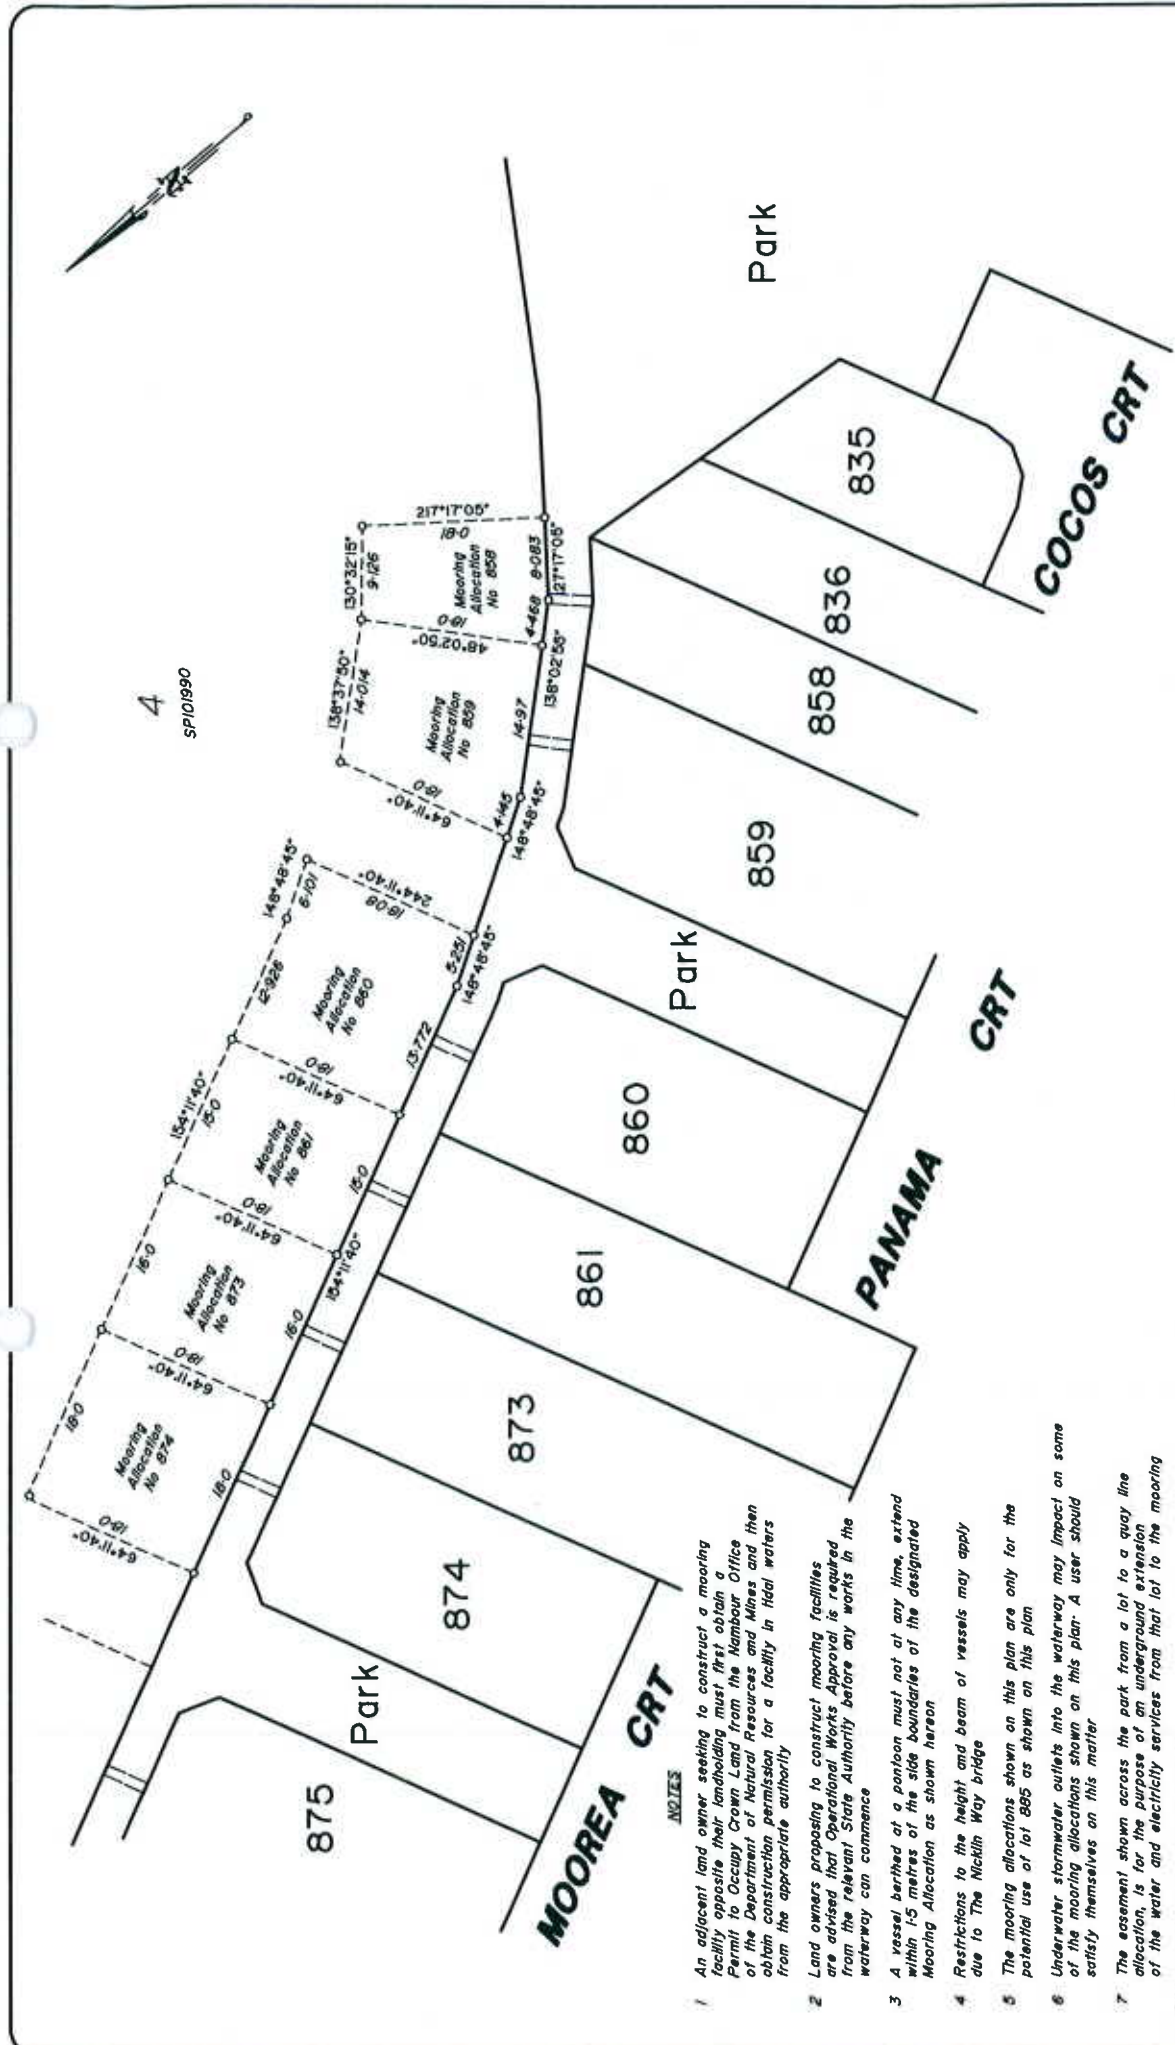


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STOCKLAND KAWANA WATERS PTY LTD AMDT
 Mooring Allocation Plan for Lots
 858-861, 873 and 874
 Stage 8 Kawana Island
 scale: 1:500
 ref no P-2780-536 3 of 5
A3



- 3 A vessel berthed at a pontoon must not at any time, extend within 1.5 metres of the side boundaries of the designated Mooring Allocation as shown hereon
- 4 Restrictions to the height and beam of vessels may apply due to The Nicklin Way bridge
- 5 The mooring allocations shown on this plan are only for the potential use of the nominated allotment as shown
- 6 Underwater stormwater outfalls into the waterway may impact on some of the mooring allocations shown on this plan. A user should satisfy themselves on this matter
- 7 The easement shown across the park from a lot to a quay line allocation, is for the purpose of an underground extension of the water and electricity services from that lot to the mooring


NOTES

- 1 An adjacent land owner seeking to construct a mooring facility opposite their landholding must first obtain a Permit to Occupy Crown Land from the Nambour Office of the Department of Natural Resources and Mines and then obtain construction permission for a facility in tidal waters from the appropriate authority
- 2 Land owners proposing to construct mooring facilities are advised that Operational Works Approval is required from the relevant State Authority before any works in the waterway can commence

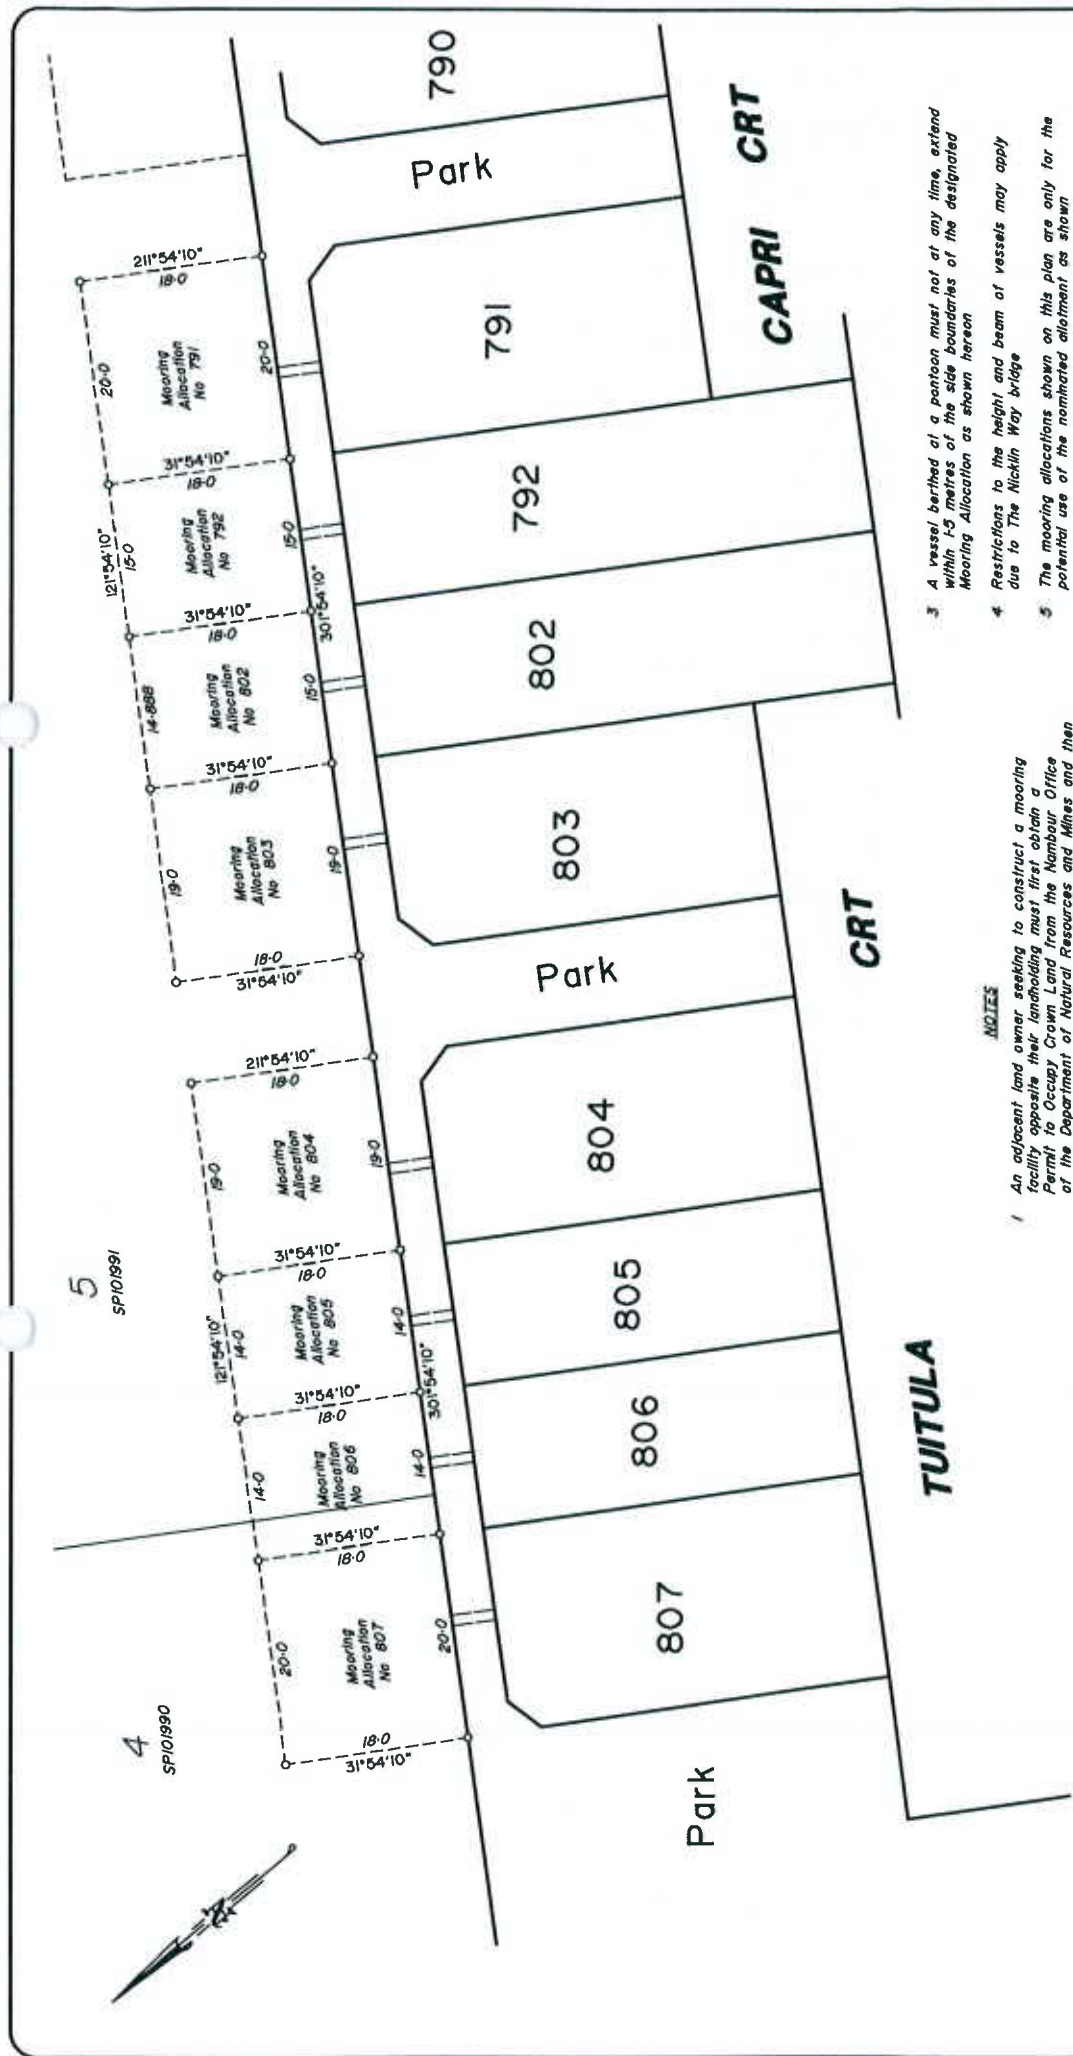Amtd B 5-05-04 S.J.G Amend Note 2
Amtd A 19-04-04 J.B.G Amend Notes

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<p>J.B. Goodwin, Midson & Partners </p> <p>consulting surveyors town planners and development consultants</p> <p></p>		<p>Brisbane 828 Coronation Drive Toowong 4088 Ph 07 38702181 Fax 07 38702944</p> <p>Kawana 2/12 Technology Drive Warana 4375 Ph 07 54931707 Fax 07 54834860</p> <p>Bonmah 2 Park Street Bonmah 4310 Ph/Fax 07 54831596</p> <p>member firm of the association of consulting surveyors</p>	

5
SP101991

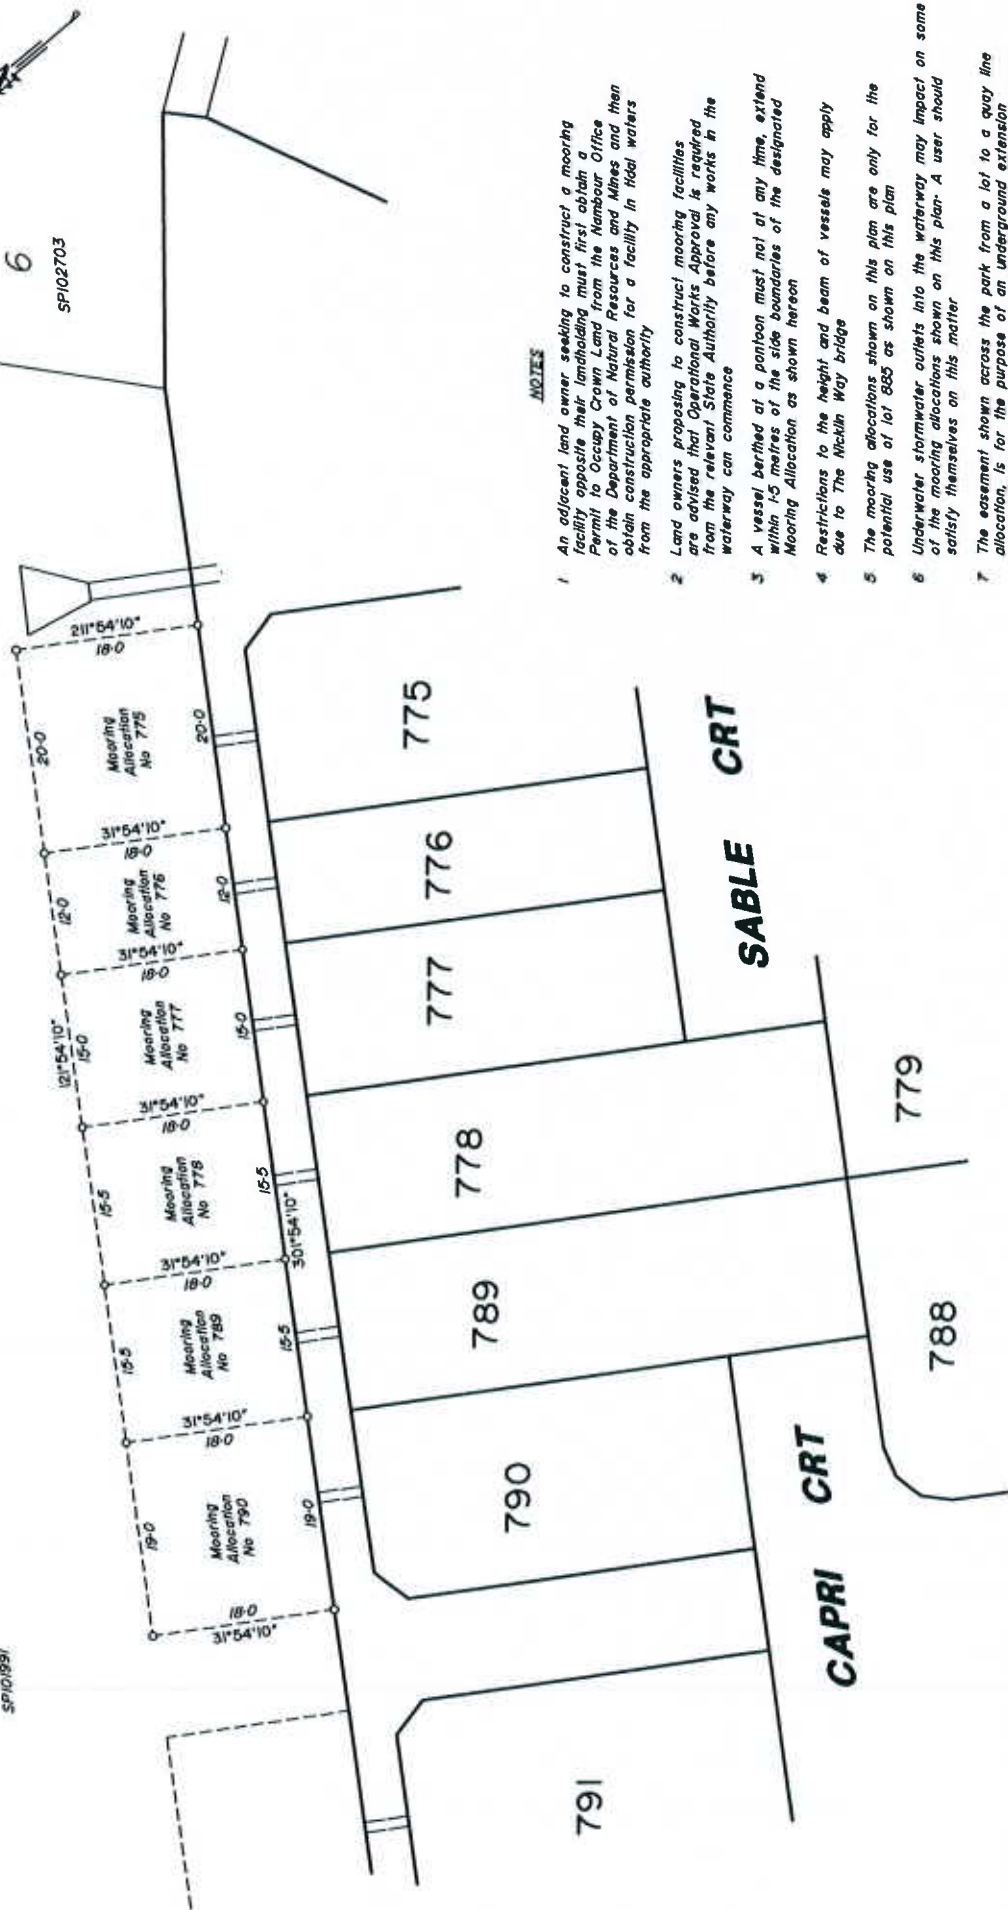

6
SP102703

NOTES

- 1 An adjacent land owner seeking to construct a mooring facility opposite their landholding must first obtain a permit to Occupy Crown Land from the Harbour Office of the Department of Natural Resources and Mines and then obtain the construction permission for a facility in tidal waters from the appropriate authority
- 2 Land owners proposing to construct mooring facilities are advised that Operational Works Approval is required from the relevant State Authority before any works in the waterway can commence
- 3 A vessel berthed at a pontoon must not at any time, extend within 15 metres of the side boundaries of the designated Mooring Allocation as shown hereon
- 4 Restrictions to the height and beam of vessels may apply due to The McMillin Way bridge
- 5 The mooring allocations shown on this plan are only for the potential use of lot 885 as shown on this plan
- 6 Underwater stormwater outlets into the waterway may impact on some of the mooring allocations shown on this plan. A user should satisfy themselves on this matter
- 7 The easement shown across the park from a lot to a quay line allocation, is for the purpose of an underground extension of the water and electricity services from that lot to the mooring

Amdt B 5-05-04 S.JG Amend Note 2 Add Stormwater Outlet
Amdt A 19-04-04 JBG Amend Notes

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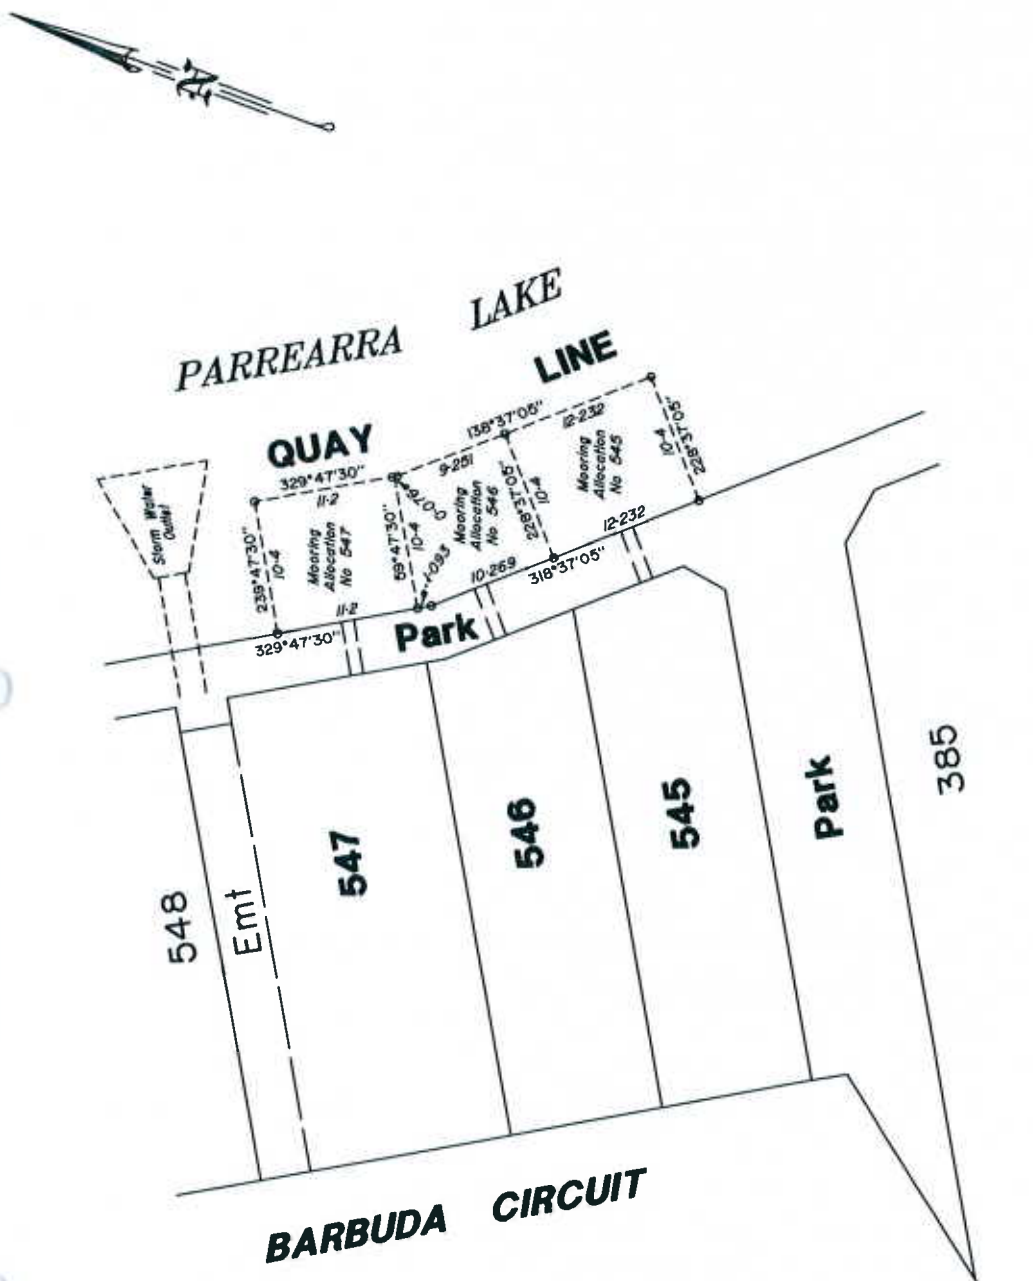
Mooring Allocation Plan for Lots
775-778, 789 and 790
Stage 8 Kawana Island

scale: 1:500 ref no P-2780-536 5 of 5

A3

NOTES

1. Catuandra City Council is the trustee of the Sport and Recreation Reserve (Parrearra Lake). No structures can be erected in Parrearra Lake before entering into a lease under Section 57 of the Land Act, 1994. The structures must be approved in accordance with the approval process and comply with the structural and operation requirements as outlined in the Parrearra Lake Management Plan.
2. A vessel berthed at a pontoon must not at any time, extend within 1.5 metres of the side boundaries of the designated Quay Line. Vessels must comply with all other Mooring Arrangements as specified in the Parrearra Lake Management Plan.
3. Restrictions to the height and beam of vessels may apply due to The Nicklin Way, Kawana Island Boulevard bridges and the width of the lock.
4. The lake area is a Sport and Recreation Reserve under the control of the Catuandra City Council and the use of the lake and environs is subject to control by local laws.
5. The mooring allocations shown on this plan are only for the potential use of lots 545-547 as shown on this plan.
6. Underwater stormwater outlets into the lake may impact on some of the mooring allocations shown on this plan. A user should satisfy themselves on this matter.
7. The easement shown across the park from a lot to a quay line allocation, is for the purpose of an underground extension of the water and electricity services from that lot to the mooring.



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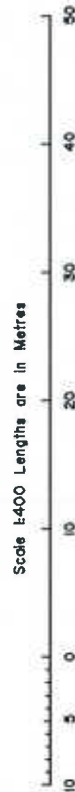
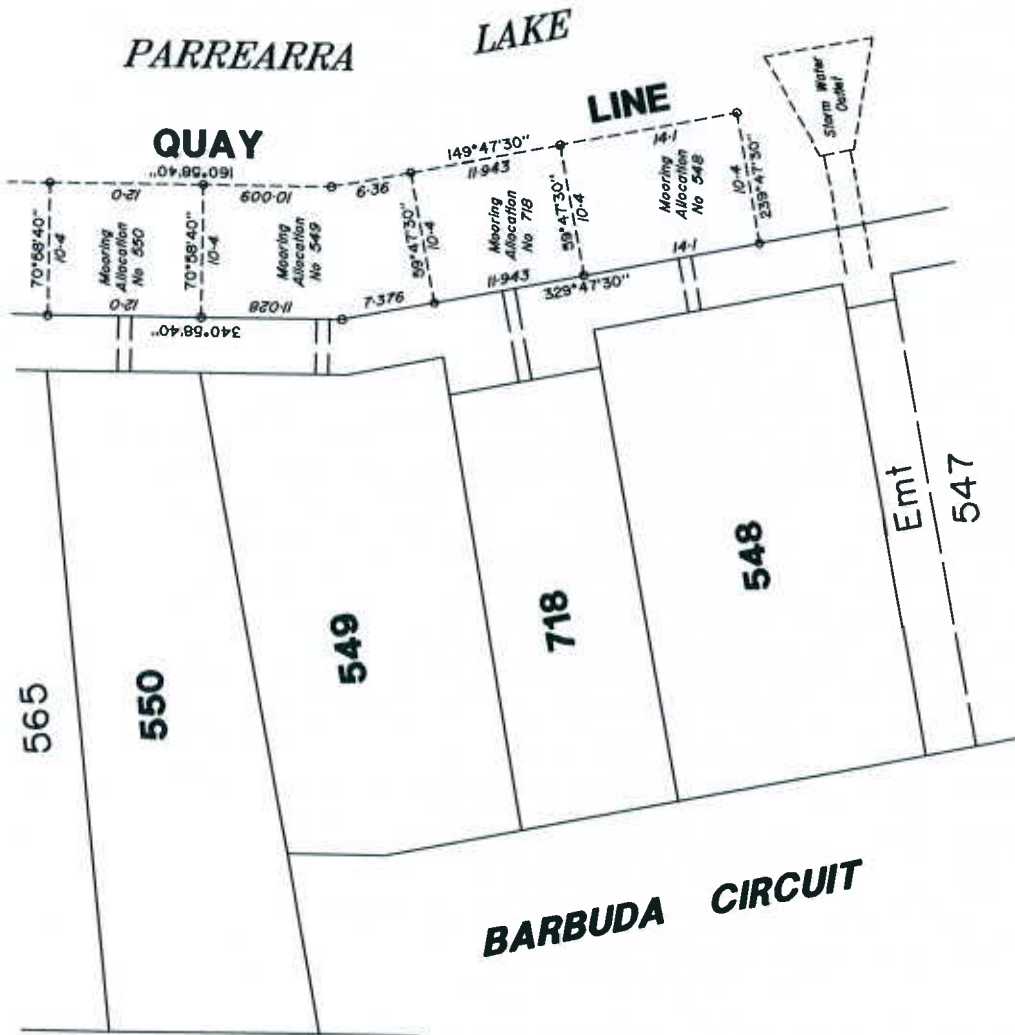
Quay Line Plan
Lots 545-547
Stage 7 Kawana Island

scale: 1:400 ref no P-2780-527-1

A3

NOTES

1. Coloundra City Council is the trustee of the Sport and Recreation Reserve (Parrearra Lake). No structures can be erected in Parrearra Lake before entering into a lease under Section 57 of the Land Act, 1994. The structures must be approved in accordance with the approval process and comply with the structural and operation requirements as outlined in the Parrearra Lake Management Plan.
2. A vessel berthed at a pontoon must not at any time extend within 1.5 metres of the side boundaries of the designated Quay Line. Vessels must comply with all other Mooring Arrangements as specified in the Parrearra Lake Management Plan.
3. Restrictions to the height and beam of vessels may apply due to The Nicklin Way, Kawana Island Boulevard bridges and the width of the lock.
4. The lake area is a Sport and Recreation Reserve under the control of the Coloundra City Council and the use of the lake and environs is subject to control by local laws.
5. The mooring allocations shown on this plan are only for the potential use of lots 548-550 and 718 as shown on this plan.
6. Underwater stormwater outlets into the lake may impact on some of the mooring allocations shown on this plan. A user should satisfy themselves on this matter.
7. The easement shown across the park from a lot to a quay line allocation, is for the purpose of an underground extension of the water and electricity services from that lot to the mooring.



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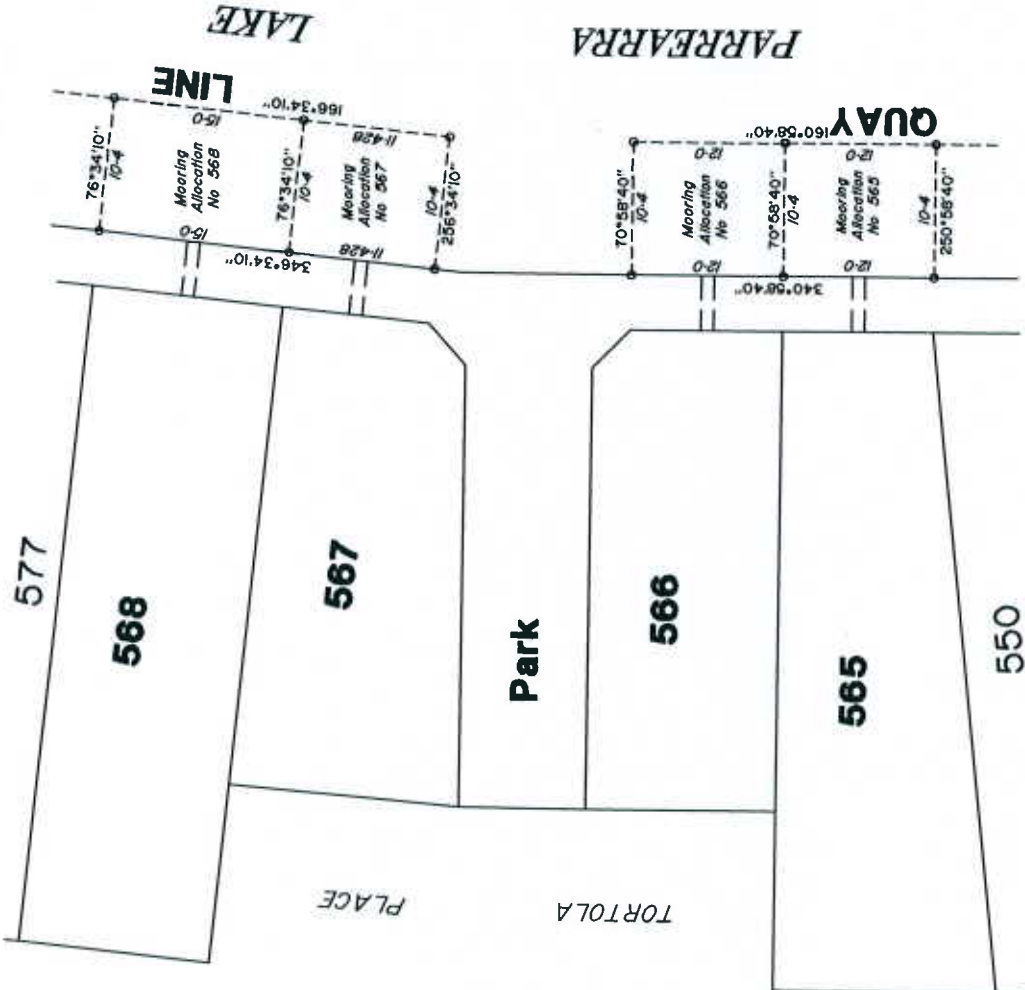
Quay Line Plan
Lots 548-550 and 718
Stage 7 Kawana Island

scale: 1:400 ref no P-2780-527-2

A3

NOTES

1. Coloumbra City Council is the trustee of the Sport and Recreation Reserve (Parrearra Lake). No structures can be erected in Parrearra Lake before entering into a lease under Section 57 of the Land Act, 1994. The structures must be approved in accordance with the approval process and comply with the structural and operation requirements as outlined in the Parrearra Lake Management Plan.
2. A vessel berthed at a pontoon must not at any time, extend within 1.5 metres of the side boundaries of the designated Quay Line. Vessels must comply with all other Mooring Arrangements as specified in the Parrearra Lake Management Plan.
3. Restrictions to the height and beam of vessels may apply due to The Nicklin Way, Kawana Island Boulevard bridges and the width of the dock.
4. The lake area is a Sport and Recreation Reserve under the control of the Coloumbra City Council and the use of the lake and environs is subject to control by local laws.
5. The mooring allocations shown on this plan are only for the potential use of lots 565-568 as shown on this plan.
6. Underwater stormwater outlets into the lake may impact on some of the mooring allocations shown on this plan. A user should satisfy themselves on this matter.
7. The easement shown across the park from a lot to a quay line allocation, is for the purpose of an underground extension of the water and electricity services from that lot to the mooring



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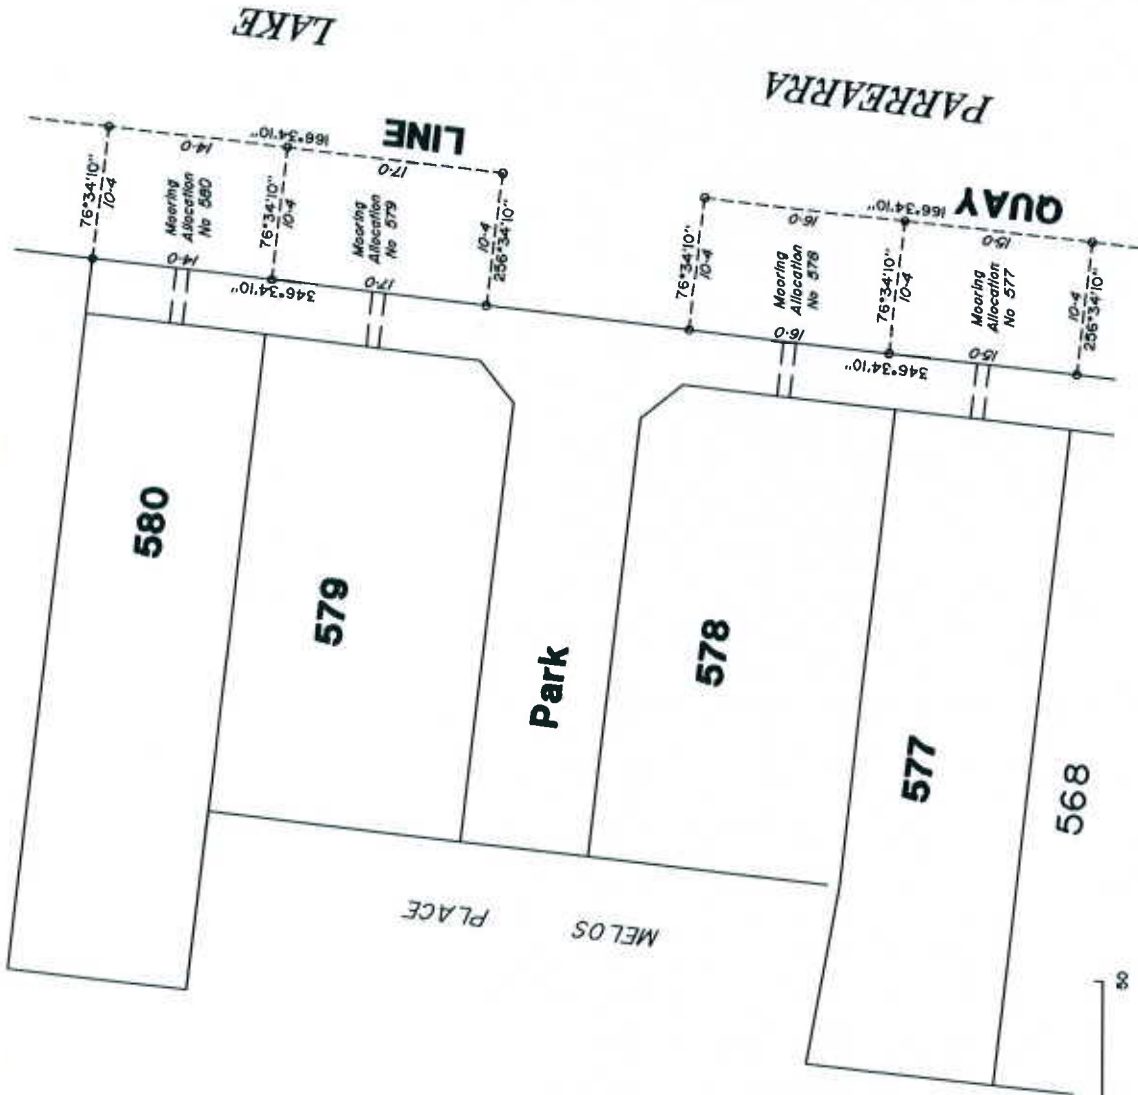
Quay Line Plan
 Lots 565-568
 Stage 7 Kawana Island

scale: 1:400 ref no P-2780-527-3

A3

NOTES

1. Caloundra City Council is the trustee of the Sport and Recreation Reserve (Parrearra Lake). No structures can be erected in Parrearra Lake before entering into a lease under Section 57 of the Land Act, 1994. The structures must be approved in accordance with the approval process and comply with the structural and operation requirements as outlined in the Parrearra Lake Management Plan.
2. A vessel berthed at a pontoon must not at any time extend within 1.5 metres of the side boundaries of the designated Quay Line. Vessels must comply with all other Mooring Arrangements as specified in the Parrearra Lake Management Plan.
3. Restrictions to the height and beam of vessels may apply due to The Nicklin Way, Kawana Island Boulevard bridges and the width of the lock
4. The lake area is a Sport and Recreation Reserve under the control of the Caloundra City Council and the use of the lake and environs is subject to control by local laws
5. The mooring allocations shown on this plan are only for the potential use of lots 577-590 as shown on this plan
6. Underwater stormwater outlets into the lake may impact on some of the mooring allocations shown on this plan. A user should satisfy themselves on this matter
7. The easement shown across the park from a lot to a quay line allocation, is for the purpose of an underground extension of the water and electricity services from that lot to the mooring



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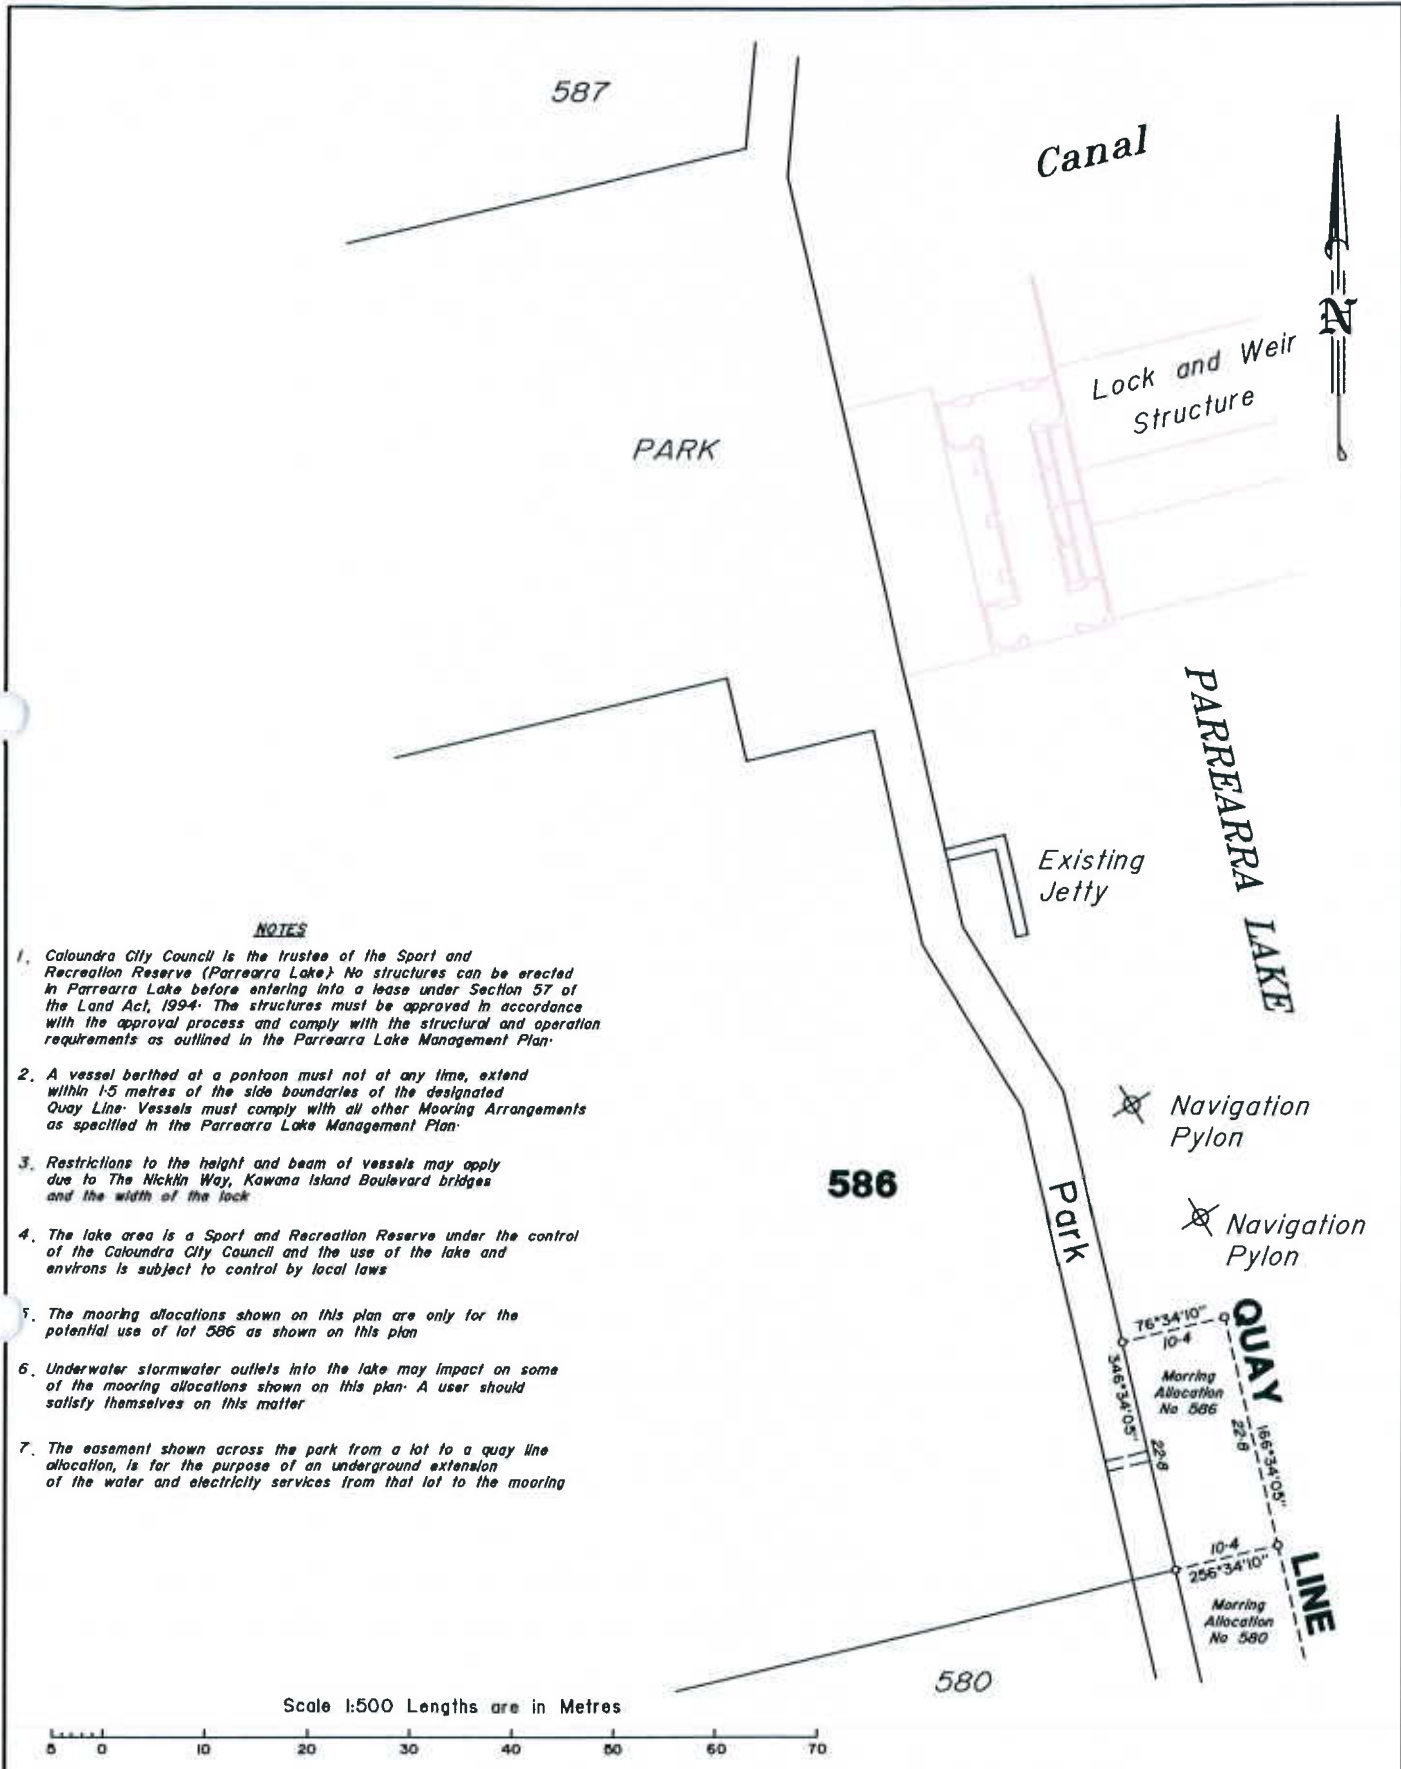
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Quay Line Plan
Lots 577-580
Stage 7 Kawana Island

scale: 1:400 ref no P-2780-527-4

A3



NOTES

1. Caloundra City Council is the trustee of the Sport and Recreation Reserve (Parrearra Lake). No structures can be erected in Parrearra Lake before entering into a lease under Section 57 of the Land Act, 1994. The structures must be approved in accordance with the approval process and comply with the structural and operation requirements as outlined in the Parrearra Lake Management Plan.
2. A vessel berthed at a pontoon must not at any time, extend within 1.5 metres of the side boundaries of the designated Quay Line. Vessels must comply with all other Mooring Arrangements as specified in the Parrearra Lake Management Plan.
3. Restrictions to the height and beam of vessels may apply due to The Nicklin Way, Kawana Island Boulevard bridges and the width of the lock.
4. The lake area is a Sport and Recreation Reserve under the control of the Caloundra City Council and the use of the lake and environs is subject to control by local laws.
5. The mooring allocations shown on this plan are only for the potential use of lot 586 as shown on this plan.
6. Underwater stormwater outlets into the lake may impact on some of the mooring allocations shown on this plan. A user should satisfy themselves on this matter.
7. The easement shown across the park from a lot to a quay line allocation, is for the purpose of an underground extension of the water and electricity services from that lot to the mooring.

Scale 1:500 Lengths are in Metres



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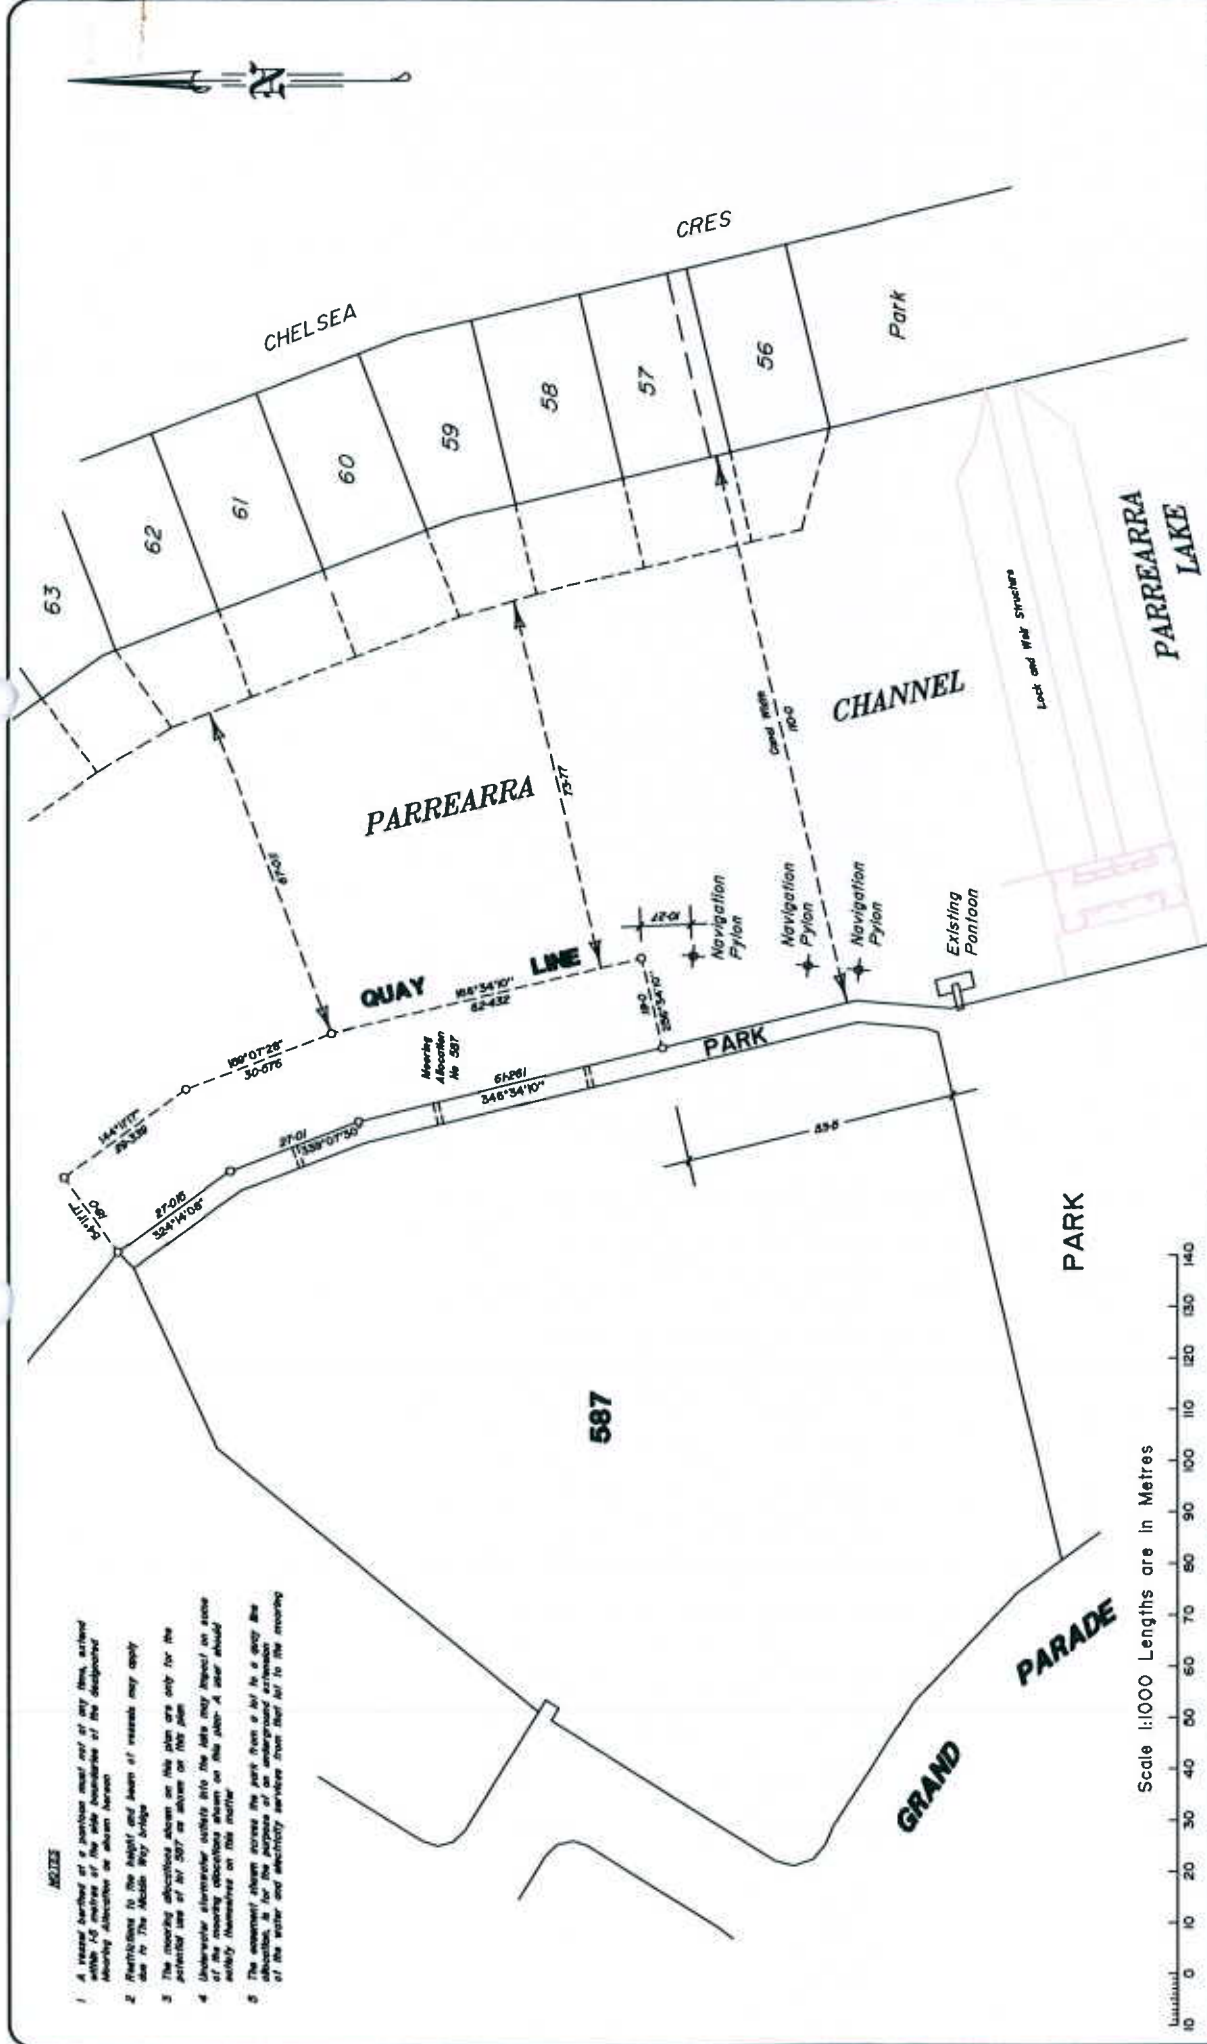
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Quay Line Plan
 Lot 586
 Stage 7 Kawana Island

drawn: JAH	scale	1:500	A3
07-06-03			
checked: SJG	ref no	P-2780-528	

NOTES

1. A vessel berthed at a mooring must not, at any time, extend within 10 metres of the side boundaries of the designated mooring structure or other mooring.
2. Restrictions to the height and beam of vessels may apply due to the Middle River bridge.
3. The mooring allocations shown on this plan are only for the intended use of lot 587 as shown on the plan.
4. On-water structures extend into the lake may impact on some moorings, it is the responsibility of the vessel owner to ensure early notification of the mooring.
5. The mooring shown across the park from a lot is a quay line allocation, it is for the purpose of an emergency structure of the water and electricity services that may be in the mooring.



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LENSWORTH KAWANA WATERS PTY LTD

Mooring Allocation Plan
for Lot 587
Stage 7 Kawana Island

scale: 1:1000

ref no P-2780-529

A3

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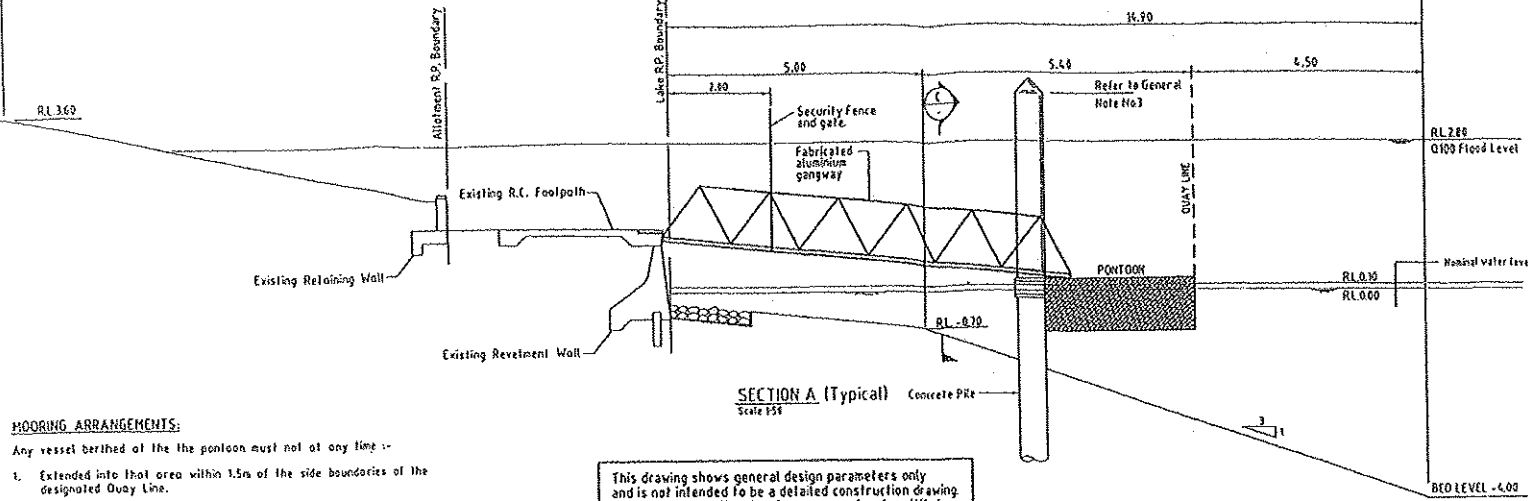
Appendix D:

**Design Standards for pontoons, Ramps and
and Decks**

GENERAL NOTES:

- Design live loads for gangways and pontoons (Private use only) - single user residential site 20kPa
- All structures shall be designed to withstand berthing impact and hydraulic loadings for a channel velocity of 0.75m/s.
- Top Level of pontoon piles to be sufficient to provide adequate extension above pontoon rollers for a maximum pile level of RL 2.80m AHD.
- Pontoons must be stable at all times. When the specified live load is distributed over half the width of the pontoon and over the walkway, there shall be not less than 75 mm of reserve buoyancy; the bottom corner shall not emerge from the water and the angle of tilt shall not exceed 15°.
- Pontoons must be constructed of materials suitable for the purpose. Thin walled steel oil drums shall not be permitted for pontoon floats. Pontoons must be protected against corrosion, attack by marine organisms and deterioration of the materials by abrasion or immersion in sea water.
- All pontoons to be restrained by at least one driven pile, stay wires are not permitted.
- Pontoons are not to extend beyond quay line or closer than 15m to the projection of the side boundary of the quay line.
- The pontoon must contain fixed lighting sufficient to indicate the presence of the pontoon, the lighting must be adequately shielded as to not cause a risk to the safe navigation of other vessels or a nuisance to surrounding properties.
- All piles are to be fitted with retro-reflective tape or a similar material, sufficient to be clearly visible from approaching vessels.
- The length of the pontoon must extend to the outer edge of the Quay Line.





Details in this area are indicative only and will vary to suit landscaping requirements




MOORING ARRANGEMENTS:

- Any vessel berthed at the the pontoon must not at any time -
- Extended into that area within 1.5m of the side boundaries of the designated Quay Line.
 - Exceed the design limitations of the pontoon.
 - Impede the safe navigation of vessels that utilise the waterway.
 - Compromise the safe ingress and egress of vessels to and from neighbouring structures.

This drawing shows general design parameters only and is not intended to be a detailed construction drawing. Detailed construction drawings prepared and certified by a qualified structural engineer are required for each individual installation.

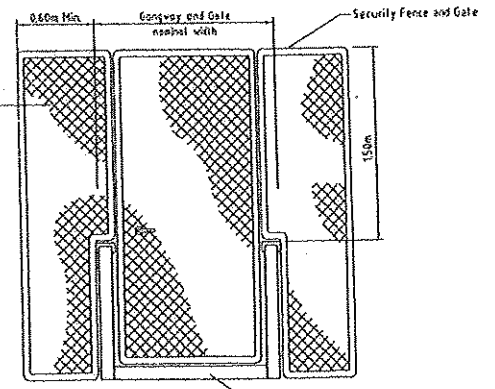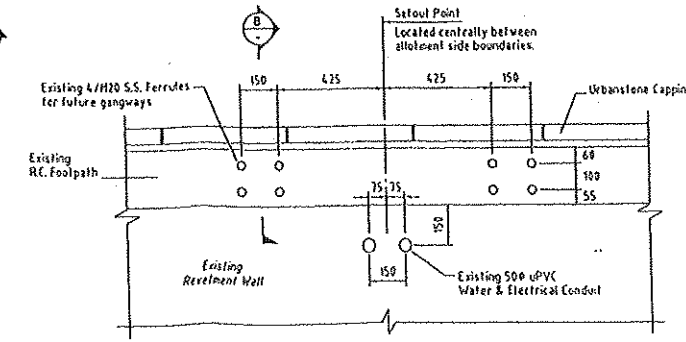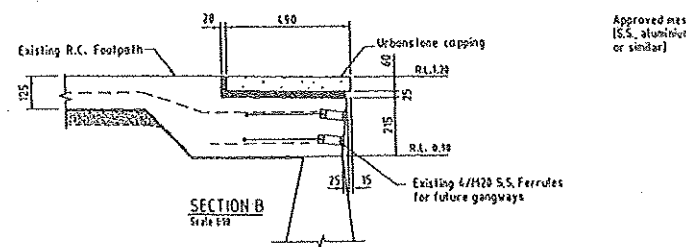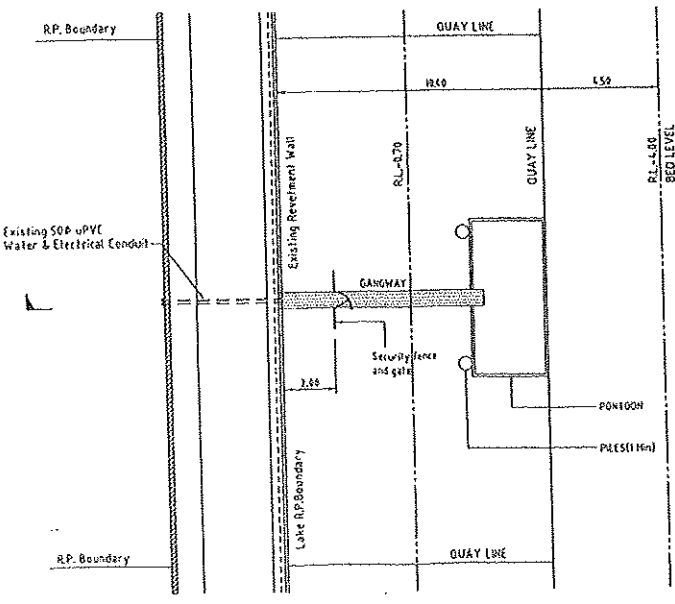


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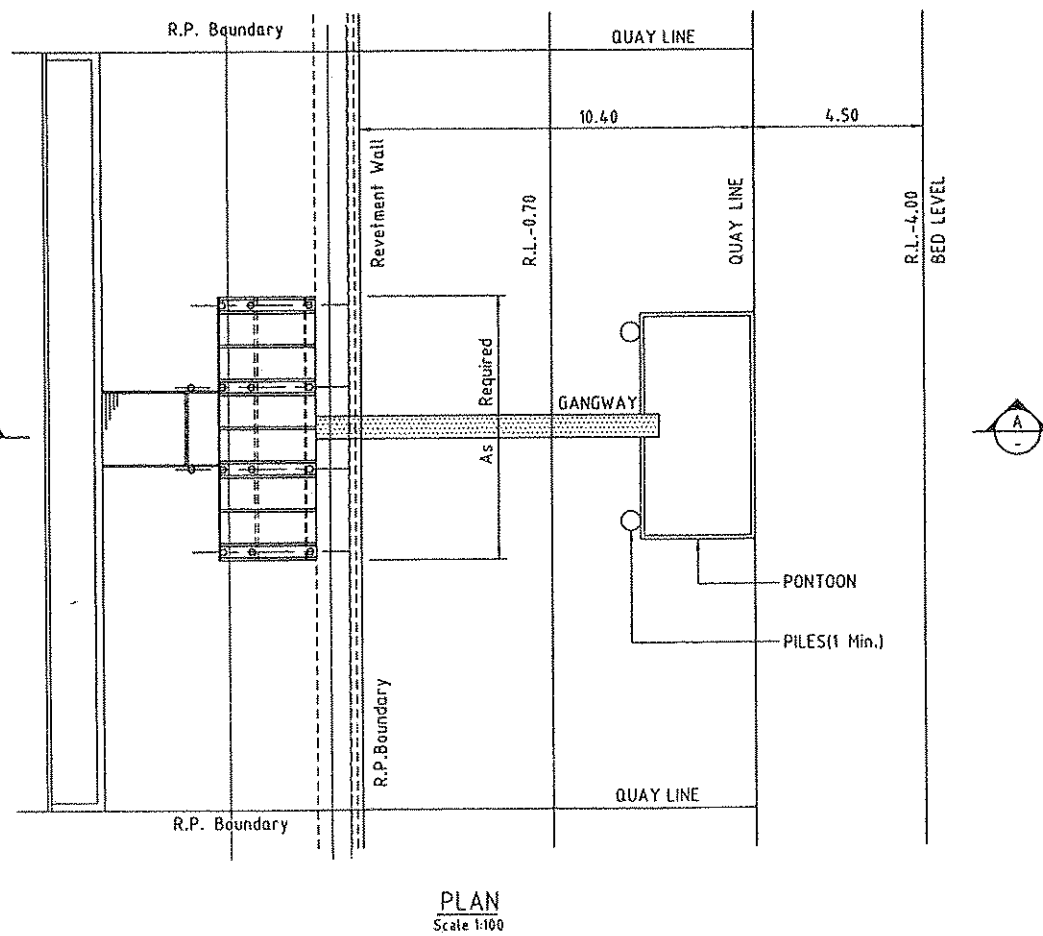
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CHECKED: D.K.		
APPROVED: P.R.L.		
DATE: 21/05/2021		
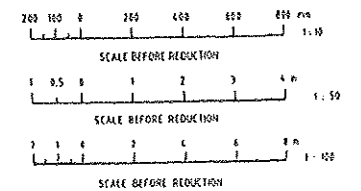
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 Cardno MBK (NSW) Pty Ltd
 40/411 014 St
 10/100-100/100 St
 10/100-100/100 St

LENSWORTH KAWANA WATERS PTY LTD
 KAWANA ISLAND
 PRIVATE RESIDENCE
 DATE: 01-05-2021
 DRAWING NO: 478/97-J
 PONTON DESIGN PARAMETERS - 10.4m QUAY LINE



DETAIL 1
Scale 1:10

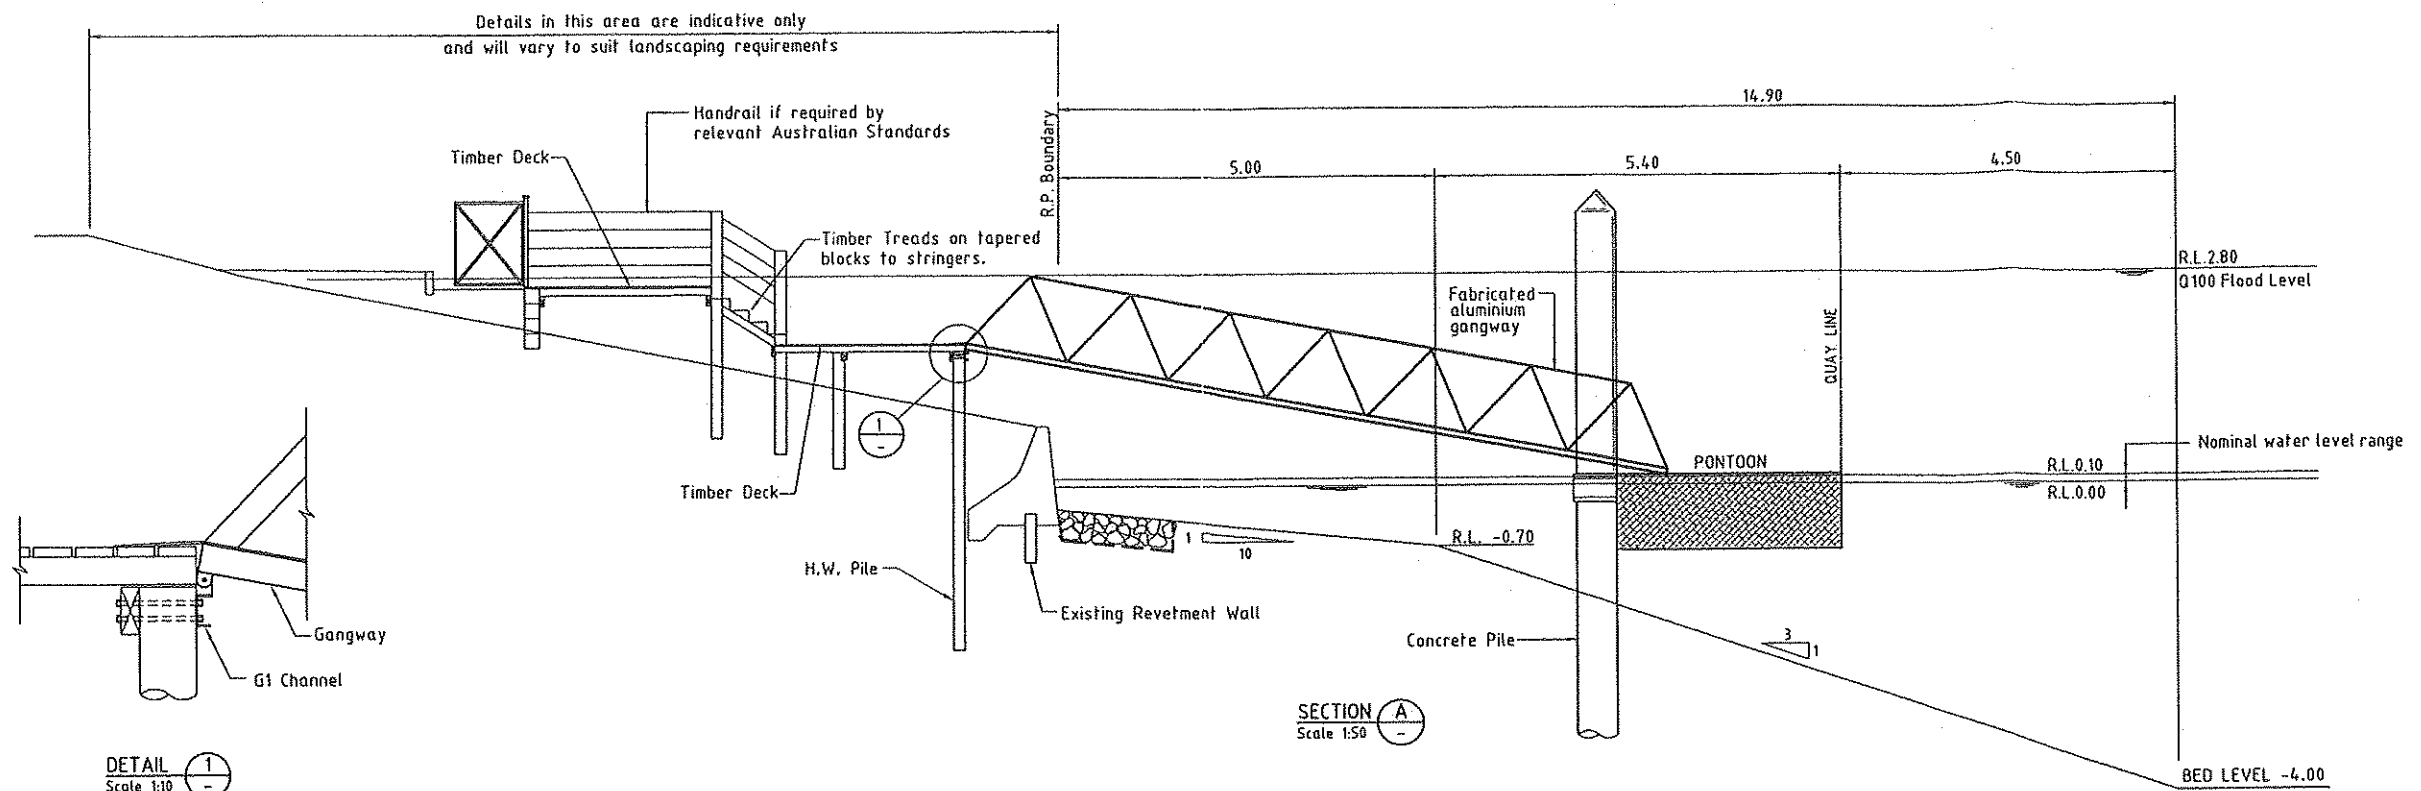

GENERAL NOTES:


- Design live loads for gangways and pontoons (Private use only):
- single user residential site 1.5kPa
- multi user residential site 2.0kPa
- All structures shall be designed to withstand berthing impact and hydraulic loadings for a channel velocity of 0.75m/s. No loads are to be imposed on revetment wall by deck or gangway.
- Top Level of pontoon piles to be sufficient to provide adequate extension above pontoon rollers for a maximum lake level of R.L. 2.80m AHD.
- Pontoons must be stable at all times. When the specified live load is distributed over half the width of the pontoon and over the walkway, there shall be not less than 75 mm of reserve buoyancy; the bottom corner shall not emerge from the water and the angle of tilt shall not exceed 15°.
- Pontoons must be constructed of materials suitable for the purpose. Thin walled steel oil drums shall not be permitted for pontoon floats. Pontoons must be protected against corrosion, attack by marine organisms and deterioration of the materials by abrasion or immersion in sea water.
- Gangway shall be fabricated from aluminium alloy 6061-T6. All welds shall be 3mm continuous fillet using filler alloy 5356.
- All pontoons within main channel to be restrained by at least one driven pile, stay wires are not permitted.
- Staywire and strut restraints systems are permitted in branch channels (lot 8 on SP103463 & lot 11 on SP142007).
- Pontoons are not to extend beyond quay line or closer than 1.5m to the projection of the side boundary of the quay line.
- No fixing or deck support shall be made onto the existing revetment wall.
- Maximum deck level to be R.L. 2.0 AHD at revetment wall.
- The pontoon must contain fixed lighting sufficient to indicate the presence of the pontoon. The lighting must be adequately shielded as to not cause a risk to the safe navigation of other vessels or a nuisance to surrounding properties.
- All piles are to be fitted with retro-reflective tape or a similar material, sufficient to be clearly visible from approaching vessels.
- The length of the pontoon must extend to the outer edge of the Quay Line.

MOORING ARRANGEMENTS:


Any vessel berthed at the the pontoon must not at any time :-

- Extended into that area within 1.5m of the side boundaries of the designated Quay Line.
- Exceed the design limitations of the pontoon.
- Impede the safe navigation of vessels that utilise the waterway.
- Compromise the safe ingress and egress of vessels to and from neighbouring structures.


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DESIGNED: <i>[Signature]</i>	DATE: 25-06-2001	<p>Cardno MBK (Qld) Pty Ltd ACN: 051 014 992</p>	<p>OFFICES</p> <p>Brisbane (07) 3569 9822</p> <p>Sydney (02) 9416 8233</p> <p>Gold Coast (07) 5530 9333</p> <p>Sunshine Coast (07) 5443 2555</p> <p>Townsville (07) 4722 1166</p> <p>Heavy Bay (07) 4124 5455</p> <p>Bundaberg (07) 4151 1211</p> <p>Central Coast (NSW) (02) 4320 2558</p> <p>INTERNATIONAL</p> <p>Port Moresby (0011675) 325 2322</p> <p>Manila (0011632) 910 5146</p>	<p>LENSWORTH KAWANA WATERS PTY LTD</p> <p>PARREARRA LAKE</p>	<p>DATE: 25-06-2001</p> <p>DRAWING No: 478/97-K</p>
DRAWN: <i>[Signature]</i>			<p>RECOMMENDED: PROJ. MAN. APPROVED: PROJ. DIR.</p> <p><i>[Signature]</i> <i>[Signature]</i></p> <p>AUTOCAD R15 FILENAME: IKT-KDWG DATE: 25-6-2001 TIME: 3:13 PM</p>	<p>TELEPHONE</p> <p>Brisbane (07) 3569 9822</p> <p>Sydney (02) 9416 8233</p> <p>Gold Coast (07) 5530 9333</p> <p>Sunshine Coast (07) 5443 2555</p> <p>Townsville (07) 4722 1166</p> <p>Heavy Bay (07) 4124 5455</p> <p>Bundaberg (07) 4151 1211</p> <p>Central Coast (NSW) (02) 4320 2558</p> <p>INTERNATIONAL</p> <p>Port Moresby (0011675) 325 2322</p> <p>Manila (0011632) 910 5146</p>	<p>REVISIONS</p> <p>B 15/11/01 Notes revised to suit councils requirements.</p> <p>A 27/07/01 Revisions to notes.</p>

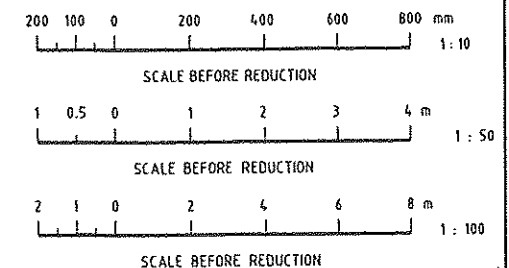

SECTION A
Scale 1:50

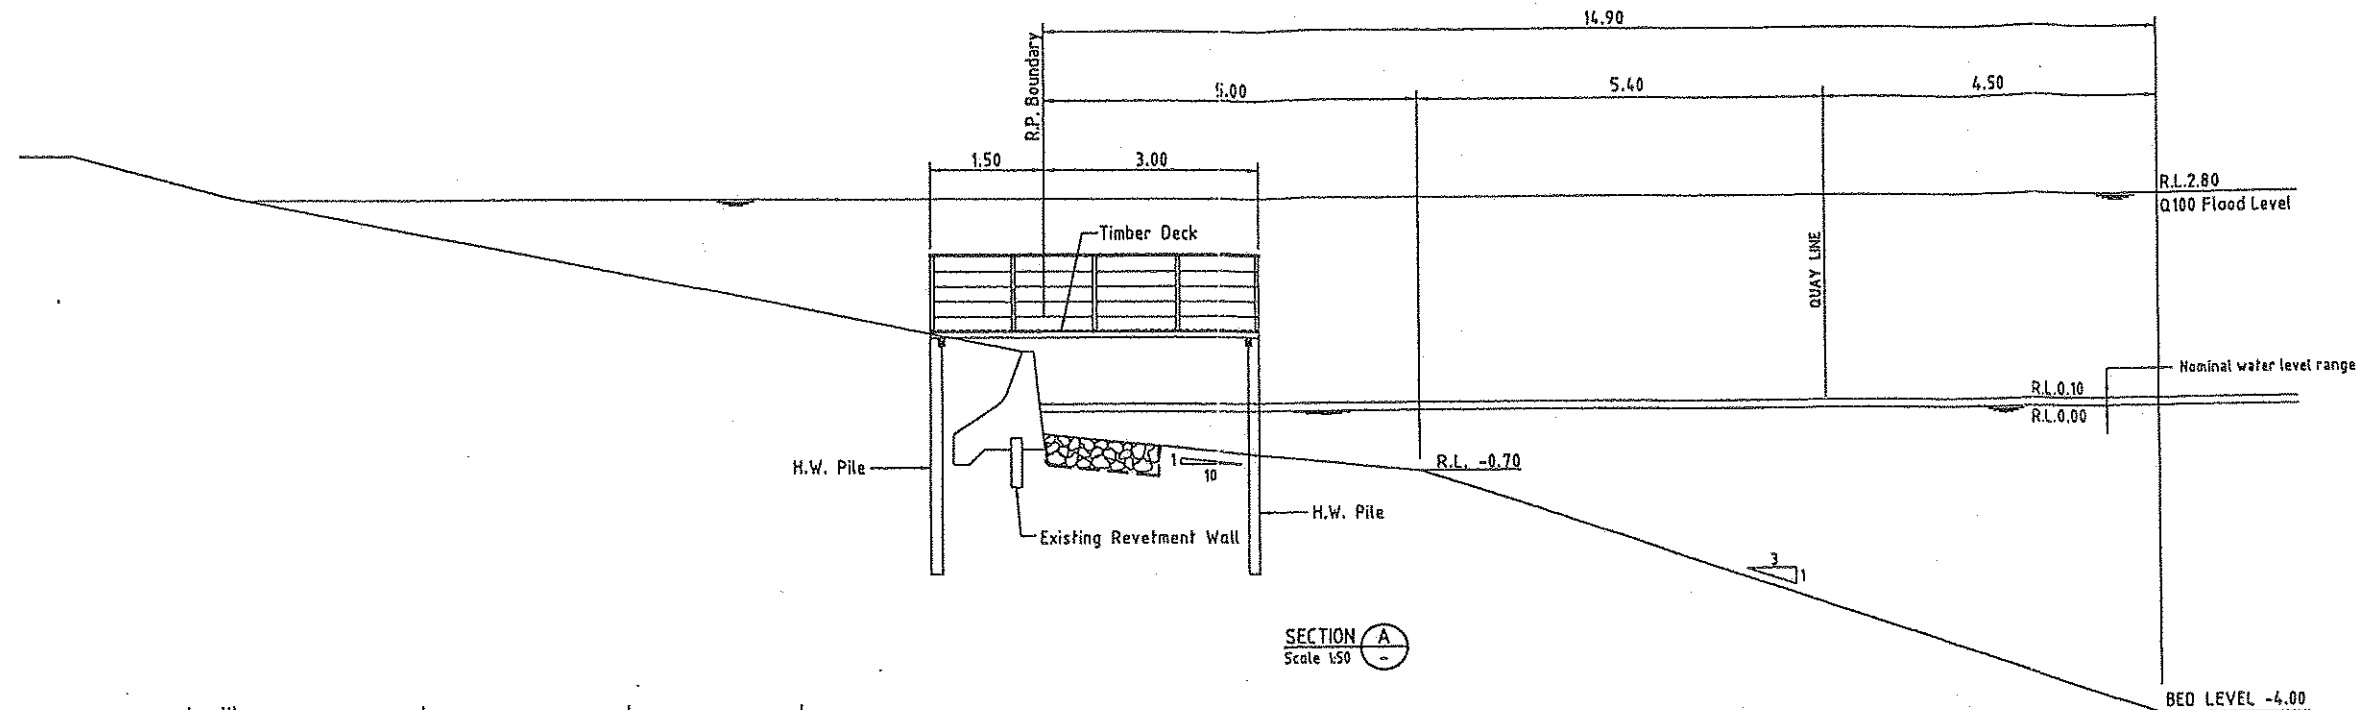


PLAN
Scale 1:100

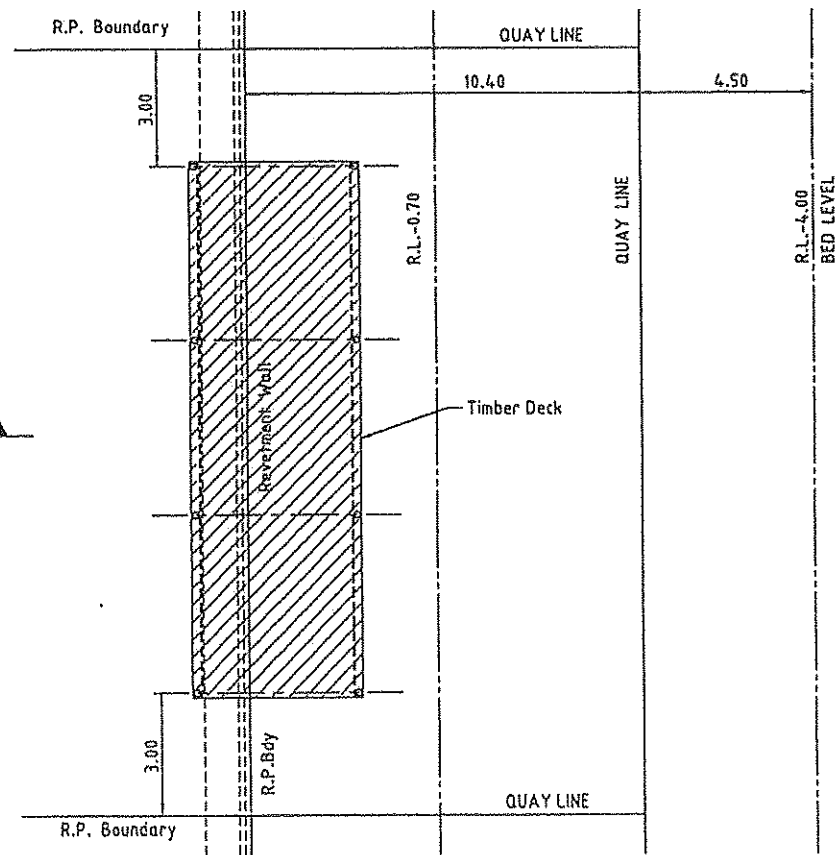
GENERAL NOTES:

- All structures shall be designed to withstand hydraulic loadings for a channel velocity of 0.75m/s. No loads are to be imposed on revetment wall by deck.
- Design live loads for decks (Private use only):
- single user residential site 1.5kPa
- multi user residential site 2.0kPa
- No fixing or deck support shall be made onto the existing revetment wall.
- Maximum deck level to be R.L. 2.0m AHD at the revetment wall.
- No vessels are to be moored to decks.


This drawing shows general design parameters only and is not intended to be a detailed construction drawing. Detailed construction drawings prepared by a qualified structural engineer are required for each individual installation.

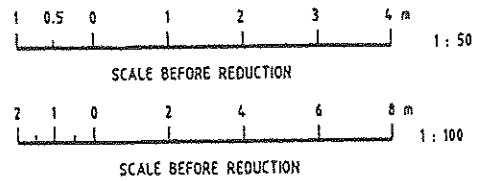


DESIGNED: <i>[Signature]</i>	A1 DATUM: A.H.D.	Cardno MBK	OFFICES: Brisbane, Sydney, Gold Coast, Townsville, Hervey Bay, Bundaberg, Central Coast (NSW), INTERNATIONAL, Port Moresby, Manila.	TELEPHONE: (07) 3369 9221, (02) 9418 8233, (07) 5538 8331, (07) 5443 8355, (07) 4772 1188, (07) 4124 5456, (07) 4151 1211, (02) 4325 2556, (011 675) 325 2222, (0011 632) 910 5148.	FAX: (07) 3369 9222, (02) 9418 8233, (07) 5538 4647, (07) 5443 2042, (07) 4772 1188, (07) 4124 5155, (07) 4151 3710, (02) 4324 3251, (0011 675) 325 0951, (0011 632) 910 5148.	LENSWORTH KAWANA WATERS PTY LTD PARREARRA LAKE	DATE: 25-06-2001 DRAWING No: 478/97-L
DRAWN: <i>[Signature]</i>		Cardno MBK (Old) Pty Ltd ACN: 051 074 922	SUNSHINE COAST OFFICE: 68 Duporn Avenue, Maroochydore, Qld 4556 En: 07 5443 2555 Fax: 07 5443 2542				
CHECKED: <i>[Signature]</i>							
RECOMMENDED: PROJ. MAN. <i>[Signature]</i>	APPROVED: PROJ. DIR. <i>[Signature]</i>						
REV. DATE	REVISIONS	REC. APPR. DATE	REVISIONS	REC. APPR.			

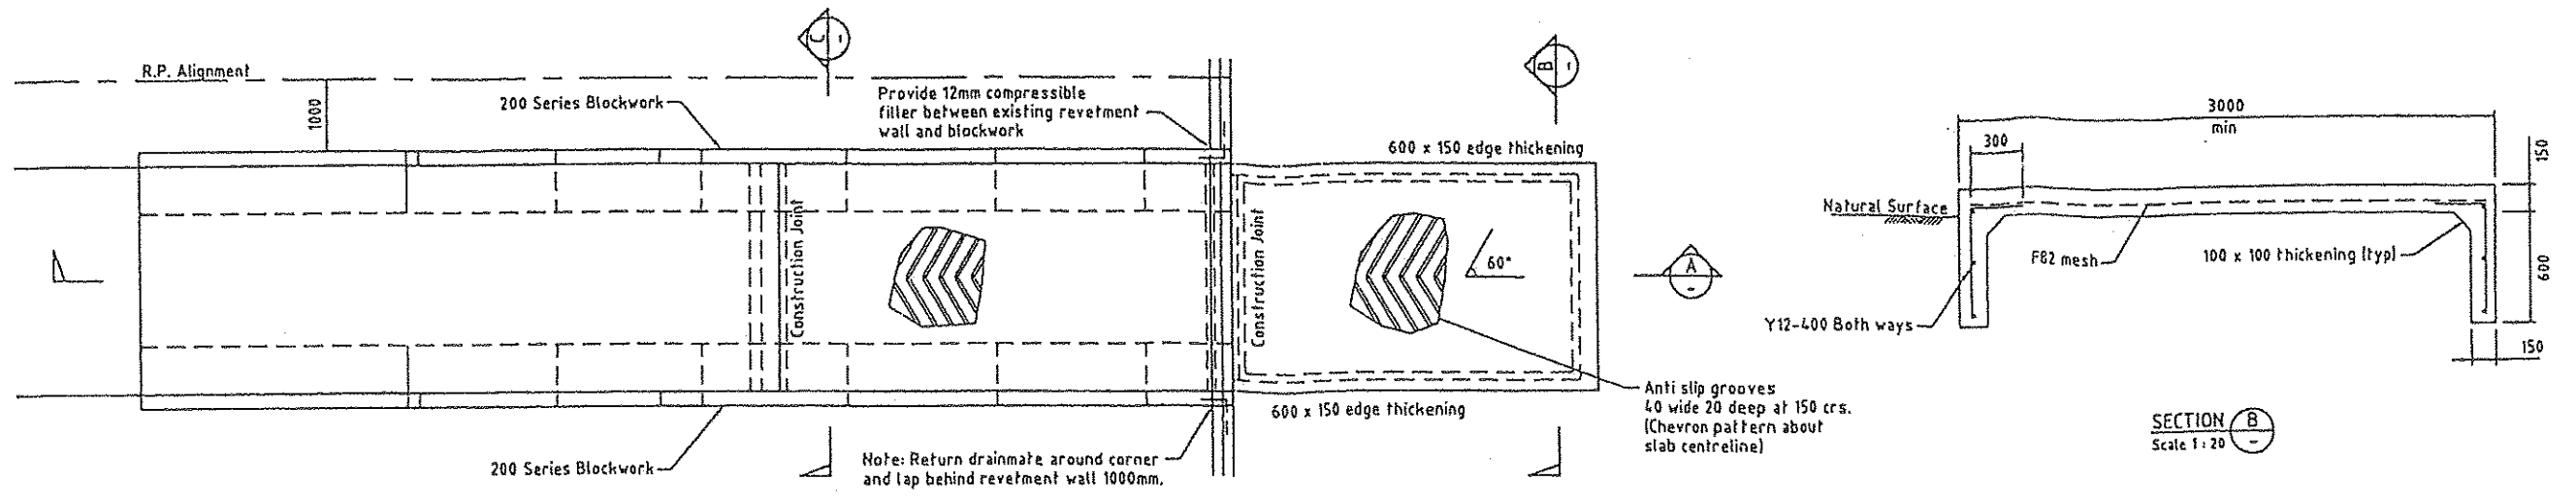


PLAN (TYPICAL)
Scale 1:20

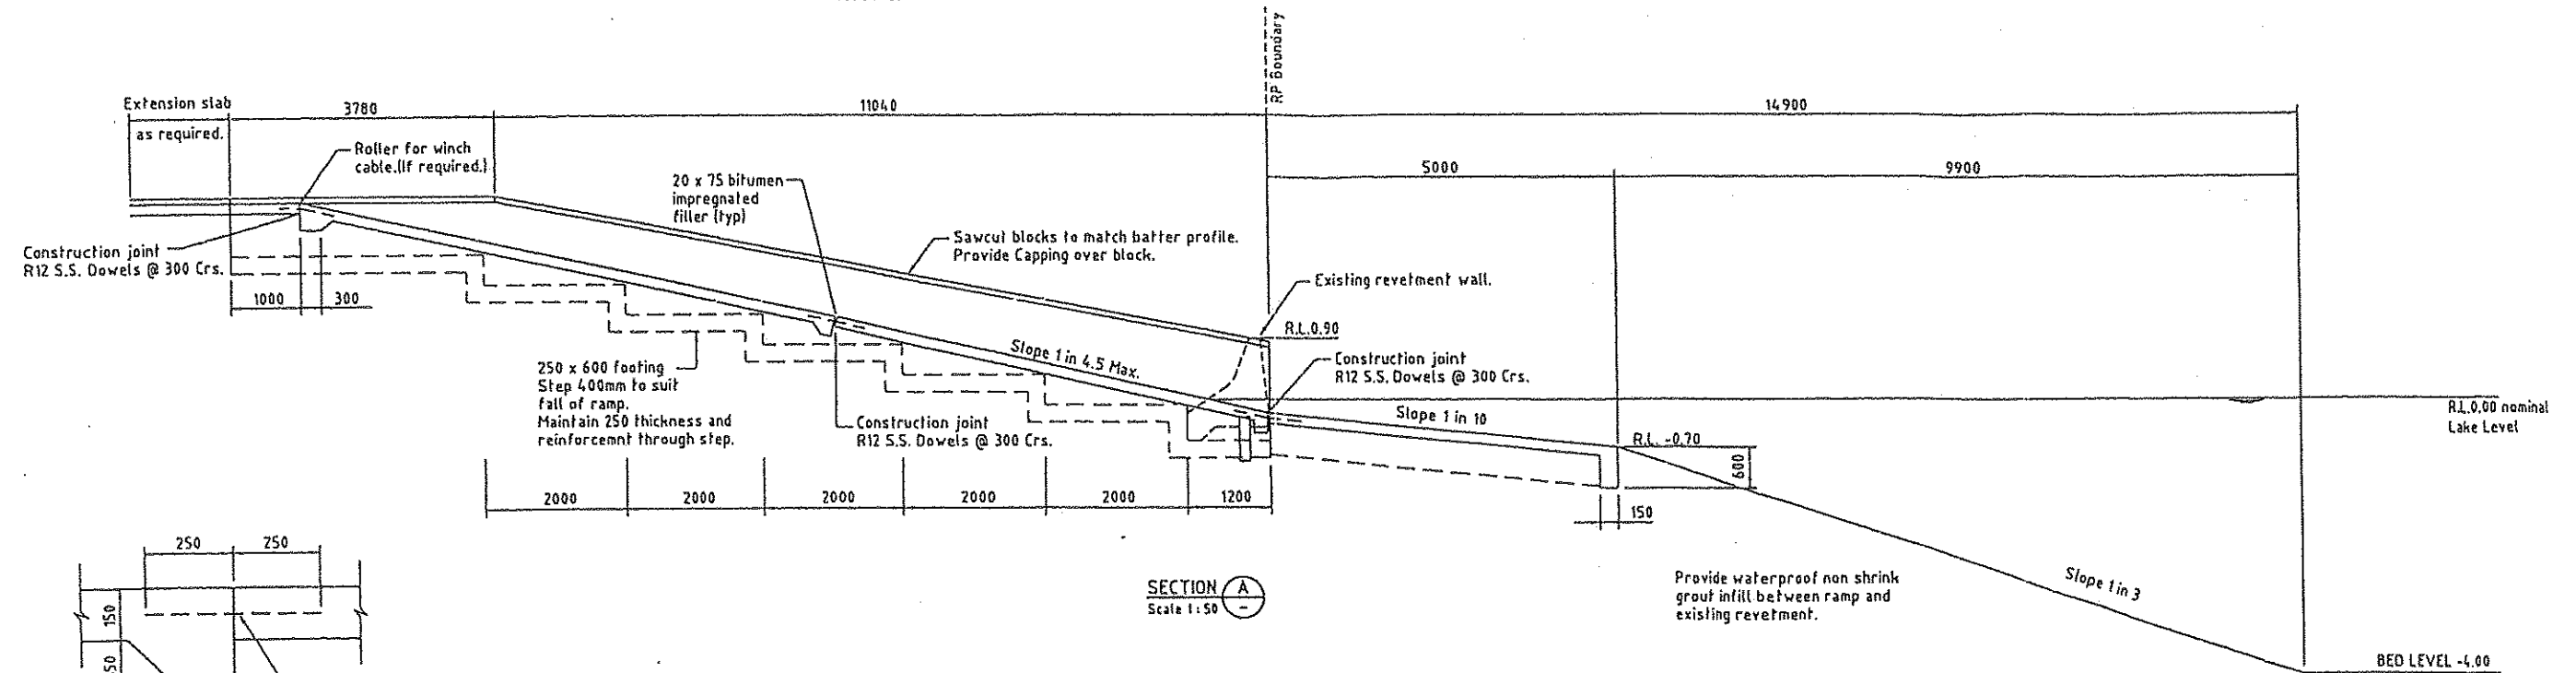


SECTION A
Scale 1:50

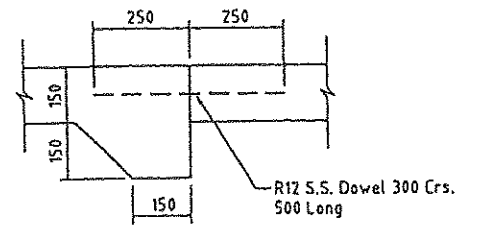

CONSTRUCTION JOINTS
Scale 1:10

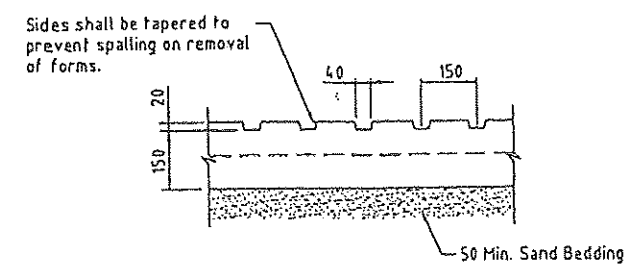

ANTI SLIP GROOVES (TYPICAL)
Scale 1:10

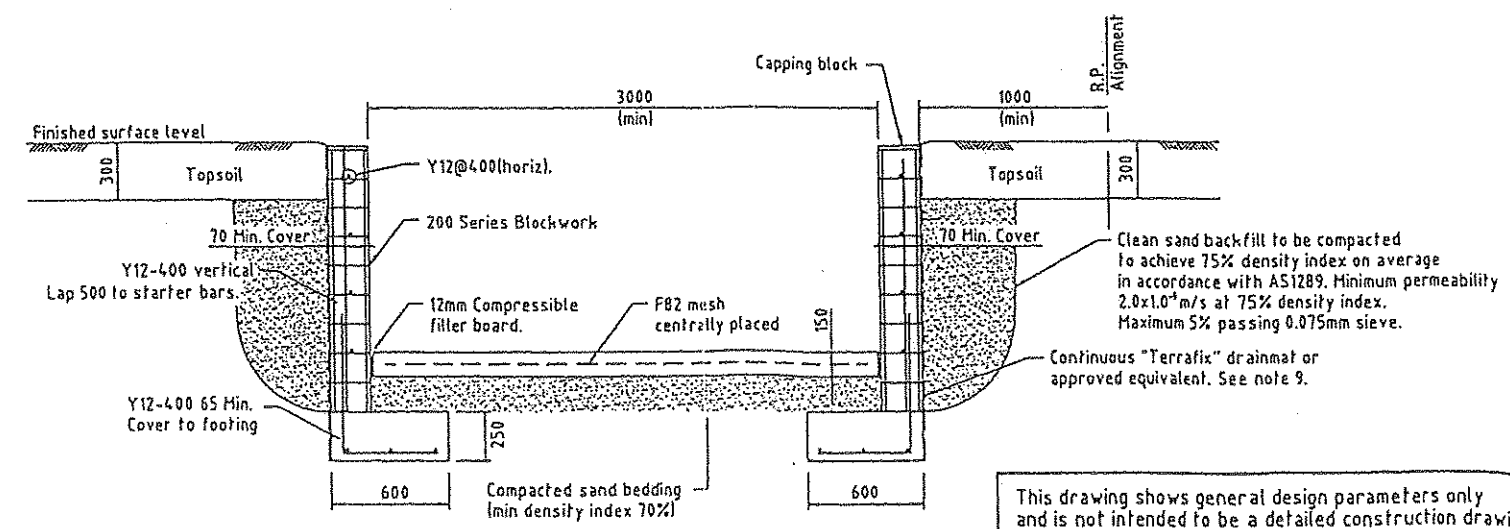


SECTION C
Scale 1:20

GENERAL NOTES

- All concrete quality and construction procedures shall be in accordance with AS 3600.
- Concrete shall Class N40/20 80 and be suitable for durability exposure classification C.
- Grout N20/10 230 ± 30mm slump
- Laps, slab 250mm, wall & footing 500mm.
- Cover, slab 55mm, footings 65mm, wall 70mm.
- All cores grout filled.
- Compact grout by rodding.
- Blockwork to be 200 Series concrete blocks to manufacturers specifications.
- "Terrafix" drainmat to be continuously sealed each end with approved sealant. Lap in accordance with manufacturer's specifications.
- Blockwork Mortar shall be a M4 Mortar (C1, S3)

This drawing shows general design parameters only and is not intended to be a detailed construction drawing. Detailed construction drawings prepared and certified by a qualified structural engineer are required for each individual installation.

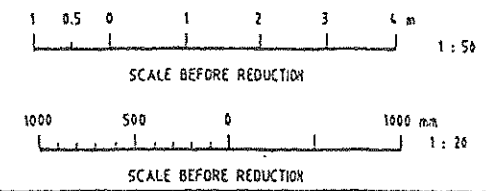

DESIGNED: <i>[Signature]</i>	DATE: 25-06-2001	<p>Cardno MBK (Qld) Pty Ltd 12th, 01 074 002</p>	<p>OFFICES</p> <p>Brisbane (07) 5500 8025 Sydney (02) 8416 8233 Gold Coast (07) 5526 8233 Sunshine Coast (07) 5443 2525 Tweed Heads (07) 4173 1166 Harvey Bay (07) 4124 5455 Bundaberg (07) 4151 1211 Central Coast NSW (07) 4223 2558</p>	<p>FAX</p> <p>(07) 5560 8123 (02) 8416 8238 (07) 5528 8647 (07) 5443 2647 (07) 4171 2526 (07) 4124 5153 (07) 4121 5710 (02) 4324 3251</p>	<p>LENSWORTH KAWANA WATERS PTY LTD PARREARRA LAKE</p>
<p>DRAWN: <i>[Signature]</i></p> <p>CHECKED: <i>[Signature]</i></p> <p>RECOMMENDED: PROJ. MGR. <i>[Signature]</i></p> <p>APPROVED: PROJ. DIR. <i>[Signature]</i></p>	<p>A1 DATUM. A.H.D.</p>		<p>INTERNATIONAL</p> <p>Port Moresby (675) 1873 323 2222 Suva (677) 1622 810 5145 Nadi (677) 1622 810 5145</p>	<p>DATE: 25-06-2001</p> <p>DRAWING No: 478/97-M</p>	

**Appendix E: Parrearra Navigation Lock and Weir
Maintenance Procedures**

PARREARRA LOCK MAINTENANCE PROCEDURES

1.0 INTRODUCTION

- 1.1 The following sections set out suggested maintenance and inspection procedures for the Parrearra navigation lock.

Due to unforeseen circumstances, variations to the suggested procedures or additional procedures may be required.

Only suitably qualified and experienced personnel should undertake the inspection and maintenance procedures. It is recommended that the contractors and sub-contractors involved in the original construction are used wherever possible. All relevant safety regulations should be observed when undertaking this work.

In addition to the following procedures, reference should be made to the Installation, Technical, Operating and Maintenance Manual before undertaking any maintenance or inspections.

PARREARRA LOCK MAINTENANCE PROCEDURES

2.0 WEEKLY MAINTENANCE INSPECTIONS

2.1 Caloundra City Council shall establish a service agreement with a maintenance provider (MP) to undertake regular inspections and operational checks of the navigation lock. These inspections were previously undertaken on a fortnightly basis for Lensworth Kawana Waters Pty Ltd by Whelan Electrical Services Pty Ltd.

2.2 The inspections involved the following:

- ◆ Check operation of lock gates and load on each actuator
- ◆ Testing of trip wires
- ◆ Check operation of traffic lights
- ◆ Lubrication of lock gate seals above waterline
- ◆ Testing of emergency phone
- ◆ Testing of emergency stops
- ◆ Check penstock operation
- ◆ Provision of report sheet (Refer to Appendix A)

2.3 The inspection should also include a general inspection of the lock, weir, jetty and pontoon for vandalism or other damage. Items to be checked include:

- ◆ Condition of timber work
- ◆ Security fences and gates
- ◆ Pontoon gangway
- ◆ Pontoon pile oyster encrustation and condition of rollers
- ◆ Local area lighting
- ◆ Landscaping

Items requiring attention should be noted in the report and appropriate maintenance scheduled.

PARREARRA LOCK MAINTENANCE PROCEDURES

- 2.4 Using the services of a maintenance provider or its own staff, Council should log on to the remote computer at the lock and download the logged data. This data includes water levels, pH and lock usage.

The data should be reviewed for anomalous values or for error messages. Whilst connected to the remote computer the status of the penstock should be checked to ensure that it is operating in accordance with the programmed parameters.

It is particularly important that the penstocks are operating correctly during periods when the tides are expected to overtop the weir (Structure Z) adjacent to the navigation lock. This will occur for predicted tides above 1.9m at Mooloolaba.

When the weir is overtopped, the lake level will rise fairly rapidly by up to 0.5m. If the penstocks are not operating correctly to lower the lake level prior to the arrival of the next high tide, the revetment walls surrounding the lake will be overtopped.

The available hard drive space on the remote computer should regularly be reviewed and unnecessary data files deleted as required after they have been downloaded.

Regular backups of the lock access card user data base should be undertaken to enable rapid system recovery in the event of a failure of the remote computer. It is recommended that this function is performed by the maintenance provider responsible for the maintenance of the user database.

PARREARRA LOCK MAINTENANCE PROCEDURES

3.0 ONE YEAR MAINTENANCE PROCUEDURES

- 3.1 Caloundra City Council shall confirm time frame with maintenance provider (MP). Allow 3 days for shut down and 2 days for contingency.
- 3.2 Caloundra City Council to arrange for letter drop to card holders and residents in Parrearra lake area (Refer to Appendix B).
- 3.3 MP to subcontract the following works to undertake the one year maintenance program.
- ◆ Diving contractor.
 - ◆ Crane contractor.
 - ◆ General maintenance contractor.
 - ◆ Cathodic protection consultant.
 - ◆ Bowler Geotechnical.
 - ◆ Naskam security.
 - ◆ Cardno MBK to check report after completion.
- 3.4 Crane contractor (arranged and co-ordinated by the MP)
- ◆ Arrange for 20 tonne all terrain or 30 tonne or greater crane to lift and remove the bulkhead storage bay cover.
 - ◆ Crane contractor to remove screens from each end of tidal exchange conduit.
 - ◆ Crane contractor to install bulkhead gates to each end of lock chamber and to each end of tidal exchange conduit.
 - ◆ Crane contractor to locate and remove the dewatering pump to the edge of the lock.
 - ◆ Crane contractor to have dogman and associated lifting eyes and slings for all lifting operations.

PARREARRA LOCK MAINTENANCE PROCEDURES

3.5 Diving contractor (arranged and co-ordinated by the MP)

- ◆ Divers to inspect and clean all marine growth from bulkhead guide slots for lock chamber and tidal exchange conduit.
- ◆ Divers to check the seating of the bulkheads prior to pump out.
- ◆ Divers to inspect and clean weep holes of weir.
- ◆ Divers to connect slings and shackles when removing tidal exchange conduit.
- ◆ Advise in writing the results of all tests and inspections.

3.6 General Maintenance (arranged and co-ordinated by the MP)

- ◆ To supervise the pump out of the lock chamber and gate recesses.
- ◆ To remove all marine life caught in the process and release back into lake system. To include specimen for testing (co-ordinate with Bowler Geotechnical).
- ◆ Remove all marine growth from the rubber fenders within lock chamber.
- ◆ Remove significant marine growth from the aluminium ladders.
- ◆ Inspect and repair any areas (apart from the structural steel elements of the lock) that are affected by rust.
- ◆ Check and lubricate all locks.
- ◆ Inspect and clean the inlet screen to the water level sensor stilling well within the lock chamber.
- ◆ Inspect and clean the sump of the lock.
- ◆ Inspect, clean and repaint the red markers to the concrete walls.
- ◆ Inspect and clean the depth marker. Repaint as required.
- ◆ Re oil the timber cover to the bulkhead storage bay.
- ◆ Inspect and clean all manhole and pit covers.
- ◆ Advise the MP and Caloundra City Council of any works that require approval whilst lock is dry and undertake those works.
- ◆ Advise in writing the results of all tests and inspections.

PARREARRA LOCK MAINTENANCE PROCEDURES

3.7 Steel work contractor (arranged and co-ordinated by the MP)

- ◆ Inspect all steel work for damage.
- ◆ Inspect all steelwork for signs of rust. Clean and repair as necessary
- ◆ Remove any marine growth that may impede the operation of the lock gates.
- ◆ Inspect and clean lubrication holes for lock gate lower polymer bearings.
- ◆ Inspect and clean penstock gate and guides.
- ◆ Inspect and clean the tidal exchange conduit screens. Repaint with anti fouling agent as required.
- ◆ Inspect all bolts and nuts for tightness. Retighten where required.
- ◆ Advise the MP and Caloundra City Council of any works that require approval whilst lock is dry and undertake those works.
- ◆ Advise in writing the results of all tests and inspections.

3.8 Cathodic Protection Consultant (arranged and co-ordinated by the MP)

- ◆ Inspect and check the zinc anodes to the gates and bulkheads.
- ◆ Check the anode potentials.
- ◆ Advise the MP and Caloundra City Council of any works that require approval whilst lock is dry and undertake those works
- ◆ Advise in writing the results of all tests and inspections.

3.9 Bowler Geotechnical (arranged and co-ordinated by the MP)

- ◆ Undertake water quality samples at the beginning of the process within the lock area, lake and canal side of the lock. pH levels etc
- ◆ Analysis fish samples from the lock area.
- ◆ Advise the MP and Caloundra City Council of any works that require approval whilst lock is dry and undertake those works.
- ◆ Advise in writing the results of all tests and inspections.

PARREARRA LOCK MAINTENANCE PROCEDURES

3.10 Whelan Electrical to check electrical/data process and equipment.

- ◆ Supervise and co-ordinate the whole shutdown and cleaning process and re-commission the lock including full operational checks.
- ◆ Confirm with the Caloundra City Council that the letter drop has been undertaken.
- ◆ Check tides to ensure the high tide will not be higher than the level of the lock weir. If expected to be higher, ensure penstock is operational to control lake water level. Co-ordination with Cardno MBK maybe required.
- ◆ Shut down the lock from operating.
- ◆ Check lock operation in all operating modes.
- ◆ Inspect, check and clean the switchboard cubicle.
- ◆ Check alarm system to cabinet.
- ◆ Inspect clean and repair all lighting.
- ◆ Advise the Caloundra City Council of any works that require approval whilst lock is dry and undertake those works
- ◆ Advise in writing the results of all tests and inspections to the Facility Manager Caloundra City Council.

3.11 Naskam Security (arranged and co-ordinated by the MP)

- ◆ Check, clean and confirm operation of alarm system.
- ◆ Confirm with Whelan Electrical system alarms are working.
- ◆ Advise the MP and Caloundra City Council of any works that require approval whilst lock is dry and undertake those works
- ◆ Advise in writing the results of all tests and inspections.

3.12 Cardno MBK (arranged by Caloundra City Council)

- ◆ Check results of all the reports from the various subcontractors and advise of the standard and condition of the lock and weir structure. Report findings to MP and the Caloundra City Council.
- ◆ Conduct independent inspections on behalf of the Caloundra City Council.
- ◆ Advise the MP and Caloundra City Council of any works that require approval whilst lock is dry.

PARREARRA LOCK MAINTENANCE PROCEDURES

- 3.13 MP to assemble all reports from sub contractor and deliver a collated report of all results to Caloundra City Council Facility Manager and the nominated representative from Cardno MBK within 14 days of shut down.
- 3.14 The Caloundra City Council Facility Manager will confirm with Cardno MBK the results and commence any rectification works.

PARREARRA LOCK MAINTENANCE PROCEDURES

4.0 PROCEDURES FOR BULKHEAD INSTALLATION AND REMOVAL AND LOCK DE-WATERING

4.1 Bulkhead Installation and Lock De-watering.

- ◆ Open security gates for access to site.
- ◆ Unlock all gates to lock safety fences.
- ◆ Remove fence panels and steel chequer cover plates to tidal exchange conduit screen/bulkhead guides.
- ◆ Shut down the lock operation. Ensure that penstocks at both weirs (Structures Y and Z) are closed.
- ◆ Ensure both pairs of lock gates are closed.
- ◆ Remove bulkhead storage bay cover and move to a position where it will not impede operation. Eye bolts are located in switchboard cubicle.
- ◆ Divers to clean out bulkhead guide slots to lock chamber and tidal exchange conduit.
- ◆ Position dewatering pump and connect all pipework.
- ◆ Divers to connect slings to lake side tidal exchange conduit screen and crane to remove.
- ◆ Position lake side tidal exchange conduit bulkhead into position using crane.
- ◆ Divers to connect slings to canal side tidal exchange conduit screen and crane to remove (note position of grate fins towards shore).
- ◆ Position canal side tidal exchange conduit bulkhead into position using crane.
- ◆ Install lake side lock chamber bulkhead using crane.
- ◆ Install canal side lock chamber bulkhead using crane.
- ◆ Commence pump out of lock (3-5 hours). Direct pump discharge to lake.
- ◆ When water depth is less than 1m open lock gates to release water from gate recesses.
- ◆ When water depth is about 300mm stop pumping and remove fish.
- ◆ Commence pumping with submersible pump until lock chamber is dry.
- ◆ Commence maintenance operations.

PARREARRA LOCK MAINTENANCE PROCEDURES

4.2 Bulkhead Removal Sequence.

- ◆ Ensure all maintenance works are completed and checked by MP.
- ◆ Ensure divers are on site to connect slings to tidal exchange conduit bulkheads.
- ◆ Close lake side lock gates.
- ◆ Ensure canal lock gates are left in the open position.
- ◆ Commence pumping operation to refill stilling well chambers between lake side lock gates and the bulkhead. Water may be pumped from the penstock chamber via gatic lid or from lake or river.
- ◆ Equalise water levels on both sides of lake side bulkhead.
- ◆ Remove lake side bulkhead using crane and lower onto rubber tyres for protection of anodes.
- ◆ Wash down bulkhead with fresh water and remove anodes.
- ◆ Reposition lifting equipment to lower bulkhead into storage area.
- ◆ Open lake side lock gates to the cracked position, slowly filling lock to level of lake. Once water level has stabilised close lake side gates.
- ◆ Close canal side lock gates.
- ◆ Equalise water levels on both sides of canal bulkhead using pump if required.
- ◆ Remove river side bulkhead using crane and lower onto rubber tyres for protection of anodes.
- ◆ Wash down bulkhead with fresh water and remove anodes.
- ◆ Reposition lifting equipment to lower bulkhead into storage area.
- ◆ Connect slings to tidal exchange conduit lake side bulkhead and remove from position and lay flat on tyres.
- ◆ Reposition slings and move lake side bulkhead into storage bay and place on top of lock bulkheads.
- ◆ Lift lake side tidal exchange conduit screen into position and replace lake side cover plate and hand railing.
- ◆ Connect slings to tidal exchange conduit canal side bulkhead and remove from position and lay flat on tyres.
- ◆ Reposition slings and move canal side bulkhead into storage bay and place on top of lock bulkheads.
- ◆ Lift canal side tidal exchange conduit screen into position and replace canal cover plate and hand railing.

PARREARRA LOCK MAINTENANCE PROCEDURES

- ◆ Replace timber cover to bulkhead storage bay noting correct orientation (markers on northern and southern sides).
- ◆ Remove eye bolts from cover and store in the switchboard cubicle.
- ◆ Check gate operations in all operating modes.
- ◆ Check all security locks are in place and secure.
- ◆ Recommission lock.
- ◆ Advise the Facility Manager of the Caloundra City Council that operation is complete.
- ◆ Advise Naskam security that lock is operational.

PARREARRA LOCK MAINTENANCE PROCEDURES

5.0 FIVE AND TEN YEAR MAINTENANCE INSPECTIONS

In addition to the procedures outlined in the preceding sections, it is recommended that the following inspection and maintenance operations are undertaken on the lock gate actuators and the penstock actuator. These operations would be arranged by the maintenance provider and would be undertaken by or in the presence of a representative of the actuator supplier.

The actuators were supplied by : Barron GJM Pty Ltd
P O Box 792
ARTARMON NSW 2064
Telephone: (02) 9436 1088
Fax: (02) 9439 3413

Unless major repairs are required, the following inspections should be able to be undertaken within the same timeframe as the annual inspections.

5.1 Five Yearly Procedures

Lock Gate Actuators:

- ◆ Remove one of the actuators, dismantle and check for wear.
- ◆ Inspect worm, worm wheel and motor coupling for wear, replace as necessary.
- ◆ Replace lubricant and all seals, reassemble actuator and test.
- ◆ Refit to gearbox and adjust switch operation.
- ◆ From knowledge gained, establish future maintenance plan.

Penstock Actuator:

- ◆ As for lock gate actuator

Penstock Linear Thruster Unit:

- ◆ The thruster was filled initially with 4 litres EP80 Gear Oil and one 250mm can of STP Oil Treatment.
- ◆ It is not intended that this lubricant be changed or topped up during the service life of the unit.
- ◆ It is recommended at 25,000 operations that the thruster be dismantled, checked for wear, reassembled and relubricated.

PARREARRA LOCK MAINTENANCE PROCEDURES

- ◆ It is important that the oil mixture (EP80 and STP) be admitted very slowly through the side inspection hole with the thruster vertical. This is to ensure that it can run through the nut vents into the lower part of the tube without overflowing into the outer tube.

5.2 Ten Yearly Procedures

Lock Gate Actuators and Gearboxes:

- ◆ Remove gearboxes from one gate, dismantle and inspect for wear. Replace as necessary.
- ◆ Replace lubricant, all seals and reassemble and test.
- ◆ Refit to gate and test.
- ◆ From knowledge gained, establish future maintenance plan.

PARREARRA LOCK MAINTENANCE PROCEDURES

6.0 OTHER MAINTENANCE INSPECTIONS

6.1 Navigation Lights

Caloundra City Council shall establish a service agreement with Queensland Transport for the maintenance of the navigation markers and beacons adjacent to the weir. The frequency of this maintenance shall be determined by Queensland Transport.

**PARREARRA LOCK
MAINTENANCE PROCEDURES**

APPENDIX A

Weekly Maintenance Report

WHELAN ELECTRICAL SERVICES PTY LTD

LOCK MAINTENANCE CHECKLIST

NOTE:- Gates must be moved as a pair. Operating individually will damage Gates.

Tick where applicable

Site:- KAWANA			
Date 16/ 7/02	Performed by Signature - <i>A</i>		
ITEM	DONE	N/A	REMARKS
Check for vandalism	/		
Check for fault indicators and reset	/		Details below
Operate Gates from locations	/		Outer Canal <input checked="" type="checkbox"/> Inner Canal <input type="checkbox"/> Inner Lake <input checked="" type="checkbox"/> Outer Lake <input checked="" type="checkbox"/>
Check Traffic Lights	/		
Check Motor Current	/		1A Amps 1B Amps 2A Amps 2B Amps
Check Voltage		 Volts
Check inside Switchboard for over-heated damaged components/Dust	/		
Check Computer Operation	/		
Test Trip Wires	/		1A <input checked="" type="checkbox"/> 1B <input checked="" type="checkbox"/> 2A <input type="checkbox"/> 2B <input checked="" type="checkbox"/>
Lubricate Seals above Water Line	/		
Test Emergency Stops	/		East <input checked="" type="checkbox"/> West <input checked="" type="checkbox"/>
Test Emergency Phone to Naskam	/		
Test Penstock Manually	/		
Check Gates set to Auto	/		
Check security system set and Switchboard Locked	/		
All entry gates locked	/		

Details -

Faults if any - some conduit damage on low voltage cables

Extra work required - Recover with loom tube.



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